

PLANNING BOARD STAFF REPORT September 21, 2023

Site Plan Review

CASE # 2

APPLICANT: Angelo Ingrassia, 58 S Main Fairport, LLC

PROJECT ADDRESS: 58 South Main Street

ZONING DISTRICT: B-1 Business District, Design Overlay District

SECTION OF CODE: Chapter 550 Article VI; Article IX

REQUEST: To construct an addition at the rear of the existing structure on Lot 1; to

make changes to the exterior of the existing structure, including removal the attached drive-through from the existing structure; to create an outdoor seating area; and to construct a 2,500 square foot building to be used as a

restaurant on Lot 2, including an outdoor seating area.

PROJECT INFORMATION: The applicant proposes to construct an addition at the rear of the existing

local landmark building (former Bank of America building) located at 58 South Main Street (Lot 1). Please note that a Certificate of Appropriateness

is required for this action.

The applicant proposes to construct a 2,500 square foot building to be used as a restaurant on Lot 2. Please note that a Certificate of Appropriateness

is required for this action.

CODE COMPLIANCE: Please see the attached memorandum to the Planning Board.

STANDARDS: The following standards will be used to evaluate the application:

550-19 Factors for Consideration

A. The Planning Board's review of a preliminary site plan shall include but is not limited to the following considerations:

- (1) The adequacy and arrangement of vehicular traffic access and circulation, including intersections, road widths, channelization structures and traffic controls.
- (2) The adequacy and arrangement of pedestrian traffic access and circulation, including the separation of pedestrian from vehicular traffic, walkway structures, control of intersections with vehicular traffic and pedestrian convenience.
- (3) The location, arrangement, appearance and sufficiency of off-street parking and loading areas.

- (4) The location, arrangement, size and design of buildings, lighting and signs.
- (5) The adequacy, type and arrangement of trees, shrubs and other landscaping constituting a visual and/or a noise-deterring buffer between these and adjoining lands.
- (6) In the case of an apartment house, townhouse or multiple dwelling, the adequacy of usable open space for playgrounds and informal recreation.
- (7) The adequacy of stormwater and sanitary waste disposal facilities.
- (8) The adequacy of structures, roadways and landscaping in areas with a moderate to high susceptibility to flooding and ponding and/or erosion.
- (9) The protection of adjacent properties against noise, glare, unsightliness or other objectionable features.
- B. In its review, the Planning Board may consult with the Village Engineer and other Village, town and county officials, as well as with representatives of federal and state agencies, including the Soil Conservation Service and the New York State Department of Environmental Conservation. The Planning Board may require that the exterior design of all structures be made by or under the direction of a registered architect, whose seal shall be affixed to the plans.
- C. When reviewing a site plan because of a change in the use or occupancy of land, a building or any portion thereof, the Planning Board shall consider the impact of the proposed change upon other uses within the same building or parcel. To the extent practical, the Planning Board may require such modification thereto as will promote the most efficient use of land consonant with compliance with the provisions of this chapter. In no event shall the Planning Board waive the direct application of a local law provision to the changed use or occupancy under review.

Article IX Design Overlay District

Please see the attached memorandum to the Planning Board

550-45 District design principles.

The following principles shall guide all development and redevelopment in the Design Overlay District and provide additional regulatory criteria for the Planning Board in its site plan review process:

- A. Create, maintain and/or reinforce pedestrian-oriented and humanscaled streetscapes that promote safe pedestrian movement, access and circulation, and a pleasant experience for pedestrians.
- B. Encourage and promote direct visual and physical access to and from the Erie Canal and Main Street.



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Site Plan Review

- C. Promote the design of buildings and sites to be an integral part of the public realm with identifiable buildings entrances, active storefronts, attractive parking areas, and an effective/efficient circulation system.
- D. Encourage and promote the design of buildings, sites and public spaces through the use of design elements, details, architectural styles and materials or treatments that reflect traditional Village character.
- E. Locate off-street parking areas to the side or rear of the structure and encourage the use of existing public lots whenever possible and, in cases where parking is adjacent to the street or sidewalk, provide clear separation with the use of landscaping, knee walls, fencing, or other methods viewed as appropriate by the Planning Board.
- F. Utilize landscaping to soften hard edges and buffer adjacent properties whenever possible.

CODE ENFORCEMENT: The subject property is not currently in code enforcement.



39 Cascade Drive / Rochester, NY 14614 / Phone (585) 458-7770

July 24, 2023

Ms. Jill Wiedrick Village of Fairport 31 South Main Street Fairport NY 14450

Re: The Cub Room Restaurant & Starbucks Coffee Shop

58 S Main Street (NYS Route 250) Village of Fairport, Monroe County

Dear Jill,

On behalf of our client, Angelo Ingrassia (58 S Main Fairport, LLC), we are pleased to submit the above-referenced project for your review. We request this application be placed on the Planning Board agenda of August 7, 2023, to initiate the process for Site Plan Approval.

The project site is on the west side of South Main Street, abutting the south side of the entrance drive into the Fairport Village Landing Plaza. The 0.38-acre parcel, which is zoned B-1 Commercial Business (Design Overlay District) will be subdivided. The northern lot of 0.20± acres will contain a restaurant, The Cub Room, in the 8,700± SF former Bank of America building, for which a one-story 700± SF addition is proposed. The southern lot of 0.18± acres will contain a Starbucks coffee shop in a 2,500± SF building to be constructed. Each use is an allowed use.

A patio will be constructed between the buildings, with seating under a covered portion adjacent to the coffee shop. The existing pavement area on the westernmost portion of the parcels adjacent to the municipal parking lot will be reconfigured to contain 11 parking spaces (including 2 accessible spaces), adding 9 parking spaces which will be posted as reserved for use by patrons of Starbucks – use of the accessible spaces is not restricted.

Sufficient parking is available in the adjacent municipal parking facility to the west and north, as well as other nearby public parking lots at Packett's Landing. No variances have been identified – a waiver from the Planning Board is required as the proposed Starbucks building is one-story, which is less than the minimum Design Overlay District requirement of two stories and provides less than the required width to height ratio.

The applicant is looking forward to re-energizing this location. The Cub Room is a superb re-use of a vacant building that has been the centerpiece of the village for close to 100 years. Starbucks provides an active, engaging street-front with outdoor seating that will add to the ambience and general vitality of the area.

Going the distance for you.

The Cub Room Restaurant & Starbucks Coffee Shop 58 S Main St, Village of Fairport 07/24/2023

Enclosed is the following information to aid in your review:

- 15 copies of this Letter of Intent
- 1 copy of the Site Plan Approval Application Form
- 1 copy of the Short Environmental Assessment Form (SEAF)
- 1 check for Planning Board fee in the amount of \$480
- 15 copies of the Site Plan Set (11x17)
- 15 copies of the Architectural Elevations for The Cub Room (11x17)
- 15 copies of the Architectural Elevations for Starbucks (11x17)
- 15 copies of the Site Plan Set (full size)

We look forward to presenting this project to the Planning Board. If you have any questions, please do not hesitate to contact our office.

Respectfully submitted,

Matt Tomlinson

MARATHON ENGINEERING

cc: Angelo Ingrassia



SITE PLAN APPLICATION

PROJECT ADDRESS	58 S Main St			
ZONING DISTRICT	B-1: Commer	cial Business, Design	Overlay District	
PROPOSED USE OF The Cub Room Res		icks Coffee Shop		
APPLICANT INFORM	MATION			
Name	Angelo Ingrassi	a, 58 S Main Fairport	, LLC	
Mailing Address	550 Latona Rd.	Bldg E, Ste 501, Roo	chester NY 14626	
Phone Number	585-350-8590			
Email Address	autoange@aol.d	com		
Interest in Property	Owner	Lessee	Other	
Signature Math	Juliason - As	againt.	Date 7/24/23	
PROPERTY OWNER	R INFORMATION (if other than above)		
Name	Same as applica	ant		
Mailing Address				
Phone Number				
Email Address				
Signature			Date	
PLAN PREPARER				
Name	Matt Tomlinson	, Marathon Engineeri	ng	
Mailing Address	39 Cascade Dr	Rochester NY 14614		
Phone Number	585-458-7770			
Email Address	mtomlinson@m	narathoneng.com		
	Office Use Only: Fee _	Account	Received	



SITE PLAN APPLICATION

Please note the State and Federal Permits Needed (list type and appropriate department)
Total Site Area (square feet or acres) 0.38 acres
Anticipated Construction Time 12 months
Will the development be staged? Yes No
Is any portion of the site in a floodplain? Yes No
Character of surrounding property (suburban, agriculture, wetlands) Suburban (village)



SITE PLAN APPLICATION

DETAILED PROJECT DESCRIPTION – Please detail the primary and secondary uses, including the ground floor area, height and number of stories for each building. For residential projects, please include the number of dwelling units and number of parking spaces. For commercial uses, please include the total floor area, total sales area and the number of automobile and truck parking spaces. Additional information can be attached.

The Cub Room: 9,400+/- SF; Starbucks: 2,500+/- SF

11 parking spaces will be constructed on the western side of the two buildings, adjacent to the existing municipal parking lot

A patio will be constructed between the buildings, with seating under a covered portion adjacent to the coffee shop.



Board Member Site Visits

As part of their responsibilities for reviewing your application, Board Members and Village Staff conduct site visits of the subject property to enable them to observe the property and the context of the neighborhood and adjacent properties. Some applications involve a project that is not visible from the public right-of-way and it may be necessary for Board Members and Village Staff to access your property to observe portions of the exterior of the property not visible from the right of way.

Please note that if you do not authorize Board Members and Village Staff to access your property, you must provide additional photographic evidence of the area of your property that is not visible from the public right-of-way.

I, Angelo Ingrassia

(owner of property),

located at 58 S Main St, Fairport

(subject property address) hereby grant

permission to members of the Fairport Planning Board, Zoning Board of Appeals, Historic Preservation Commission and Village Staff to enter upon and review my premises in connection with the application submitted for the review.

Signature of Property Owner

Tombison - as Agent

Date 7/24/23



Statement of Applicant and Owner with Respect to Reimbursement of Professional and Consulting Fees

In conjunction with an application made to the Village of Fairport, the undersigned states, represents and warrants the following:

- 1. I/We am/are the applicant and/or owner with respect to an application to the Village of Fairport.
- 2. I/We have been advised of, are aware of and understand the obligation to reimburse the Village of Fairport for consulting and professional fees incurred in relation to my/our application(s), all in accordance with the Village of Fairport Consultant Fee Reimbursement Law.
- 3. I/We understand that this obligation shall not be dependent upon the approval or success of the application.

Owner	Angelo Ingrassia	
Signature	Matt Toulisson . as	Agent
Dated	7/24/23	
Applican	t (if different from Owner)	

Dated

Signature

Engineer's Memorandum FOR

Proposed Restaurant Building and Starbucks

58 South Main Street
Village of Fairport
Monroe County, New York
7/24/2023

Prepared By:

Prepared For:



58 S Main Fairport, LLC



1.0 Introduction

This project proposes subdividing the existing lot at 58 South Main Street into two lots and constructing improvements on each. On Lot 1, a 1-story building addition will be added to the rear of the existing structure. On Lot 2, a new 1-story building will be constructed. Between the two buildings a walkway, landscaping, and patios will be constructed.

2.0 Utilities

Lot 1 will be served by existing utility connections. On the existing sanitary sewer lateral, a grease trap will be installed to allow a restaurant to occupy the building. No other utility modifications will be made.

Lot 2 will be served by a new 6" PVC sewer lateral with grease trap and a new 1" domestic water service. Fire sprinklers are not required to be installed as part of this project; therefore, no fire service line is proposed.

Runoff from the proposed site will generally follow the flow pattern of existing runoff. Existing conditions runoff is collected by roof drains on the existing building and two catch basins. Proposed conditions runoff will be collected by 6-yard drains, two catch basins, and roof drains on both buildings. In both the existing and proposed conditions, runoff from the upslope private and municipal parking will be collected by on-site catch basins. All inlets will convey runoff to an existing 12-inch storm pipe that connects to the municipal stormwater system.

2.0 Parking

Per Village code § 550-49 B.(9) one space is required per four occupants and per four outdoor seats. The following table summarizes occupancy and outdoor seating for both structures.

	Restaurant Building	Starbucks
Indoor occupancy	120	28
Outdoor Seating	40	32
Total of indoor occupancy and outdoor seating	160	60



Based on these values, 55 parking spaces are required for the two lots. Though 55 spaces are required by code, it is not anticipated that these businesses will require this much parking at any one time, as their peak hours do not overlap. The peak hours for Starbucks are in the morning, and the restaurant will not be open during these hours. Additionally, Starbucks parking spaces have a high turnover rate that is not accounted for in the demand calculation within the code.

Parking on site will consist of 9 spaces marked as reserved for the new Lot 2 structure, and two unreserved accessible spaces. The remaining 44 parking spaces required will be provided by the adjacent municipal parking lots. To ensure these lots have capacity to accommodate parking for the proposed project, a representative of the landlord counted available municipal spaces at peak weekend morning and afternoon times on several days in May and July 2023. Average available space counts from those days are included in the following table.

Location		Day an	d Time		
	Saturday Morning	Saturday Afternoon	Weekday Morning	Weekday Afternoon	
Village Landing South of Main Street entrance (Immediately adjacent to site)	0 (Farmers Market occupying this space)	45	45	45	
Village Landing North of Main Street entrance	12-20 (quick turnover)	180+	160+	100+	

Additionally, the adjacent lot to the South, 70 South Main Street, has indicated in correspondence that their parking may be used by 58 South Main Street during hours when the business at 70 South Main Street is closed. A copy of this correspondence is attached.

Based on these counts, and the select availability of parking at 70 South Main Street, there is sufficient parking to accommodate the proposed Lot 1 and Lot 2 tenants.



3.0 **Code Review**

The following project statistics table compares the proposed site against zoning regulations for the business commercial district. Rows highlighted in yellow vary from requirements. See site plan sheet C3.0 for additional information.

PROJECT STATISTICS

1. GENERAL:

1.1 PROPERTY ADDRESS -58 S. MAIN STREET 1.2 TAX ACCOUNT -153.13-1-16.1 0.381 ACRES 1.3 PARCEL SIZE -

2. ZONING REGULATIONS:

2.1 ZONING DISTRICT -B-1 COMMERCIAL BUSINESS (ARTICLE VII.550-32) DESIGN OVERLAY DISTRICT (ARTICLE IX)

2.2 PROPOSED USES -

RESTAURANTS ARE PERMITTED USES WITHIN THE ZONING DISTRICT

2.3	CODE REQUIREMENTS -	REQUIRED	PROPOSED LOT 1	PROPOSED LOT 2
	MAXIMUM BUILDING COVERAGE	80%	44%	32%
	MAXIMUM PARKING/ LANE COVERAGE	20%	16.7%	15.7%
	MINIMUM LOT AREA	5000 SF	8,697 SF	7,892
	MINIMUM LOT WIDTH	40'	62'	56'
	MINIMUM LOT DEPTH	125'	140'	140'
	FRONT SETBACK	0'	6.7'(EXIST.)**	16'**
	SIDE SETBACK (MINMAX)	0-10'	8.7'(EXIST.)	6.5'
	REAR SETBACK	30'	36.4'	47.7'
	MIN. BUILDING HEIGHT	24-45'	EXISTING	22'
	PARKING LOCATION *	SIDE OR REAR	REAR	REAR

4.0 **Hours of Operation**

Cub Room, the tenant on Lot 1, is anticipated to operate on the following schedule.

Monday	Tuesday	Wednesday	Thursday	Friday	Saturday	Sunday
Closed	Closed	5 PM – 9 PM	5 PM – 9 PM	5 PM – 10:30 PM	5 PM – 10:30 PM	10 AM – 2 PM

Starbucks, the tenant on Lot 2, is anticipated to operate on the following schedule.

Monday	Tuesday	Wednesday	Thursday	Friday	Saturday	Sunday
5 AM – 8:30 PM	5 AM – 7 PM	5 AM – 7 PM				

^{*}MUNICIPAL LOT WITHIN 500' OF PROJECT
*** PLANNING BOARD CAN INCREASE FOR OUTDOOR EATING/ SEMIPUBLIC USES



August 30, 2023

Mr. Angelo Ingrassia 550 Latona Rd, Bldg E Suite 501 Rochester, New York 14625

RE: 58 South Main St Development, Village of Fairport, NY

Trip Generation & Distribution Assessment

Dear Mr. Ingrassia:

The purpose of this technical letter is to provide a trip generation and distribution assessment, and to understand the possible traffic impacts resulting from the proposed project located at 58 South Main St in the Village of Fairport, NY. **Figure 1** illustrates the project site location and study area. This letter details the current traffic conditions at the site driveway and South Main St, projected trip generation estimates, and future trip distribution at the site driveway and South Main St. The scope of work for this project was reviewed and approved by the Village of Fairport. All supporting materials are included in the attachments.

EXISTING HIGHWAY SYSTEM

The project is located to the west of South Main St, and along the south of the Fairport Village Landing property in the Village of Fairport, NY. **Table 1** provides a description of the roadway characteristics for the adjacent highway: South Main St. **Figure 2** depicts the lane geometry and traffic control at the study intersections and the Annual Average Daily Traffic (AADT) volumes on South Main St.

Table 1: Existing Highway System

ROADWAY	CLASS1	AGENCY ²	SPEED LIMIT ³	TRAVEL LANES ⁴	TRAVEL PATTERN/ DIRECTION	EST. AADT & SOURCE ⁵
South Main Street (NY-250)	14	NYSDOT	30	2	Two-way/ North-South	11,216 NYSDOT (2018)

Notes:

- 1. State Functional Classification of Roadway: 14 = Urban Principal Arterial
- 2. Jurisdictional Agency of Roadway. "NYSDOT" = New York State Department of Transportation
- 3. Posted or Statewide Limit in Miles per Hour (mph).
- 4. Number of travel lanes. Excludes turning/auxiliary lanes developed at intersections.
- 5. Estimated AADT in Vehicles per Day (vpd). AADT Source (Year).

<u>Urban Principal Arterial (Class 14)</u>

An urban principal arterial serves major activity centers, can interconnect, and augment higher level arterials, serve trips of moderate length, and serve demand for intra-area travel between the central business district and outlying residential areas. Unlike access-controlled arterials, abutting land uses can be served directly.

PROJECT DESCRIPTION

The proposed project consists of a stand-alone $\pm 2,500$ square foot (SF) Starbucks Coffee Shop (without a drive thru) and a second/new location for "The Cub Room" restaurant. The new restaurant





will be housed in the existing/renovated $\pm 3,883$ square foot (SF) two story building on the site; a ± 750 SF one story addition will be constructed along the west side of the building. Access is provided via the existing Fairport Village Landing driveway along South Main St directly north of the proposed project and the existing Fairport Village Landing driveway along Perrin St.

Eleven parking spaces will be constructed along the west side of the proposed project and will be reserved for the proposed project. There is additional public parking in the Fairport Village Landing, and Packett's Landing Municipal parking lot, which are both walking distance from the proposed project. Additionally, the property owner at 70 South Main St has indicated that their parking lot may be used for the proposed project when the business at 70 South Main St is closed.

TRIP GENERATION

The volume of traffic generated by a site is dependent on the intended land use and size of the development. Trip generation is an estimate of the number of trips generated by a specific building or land use. These trips represent the volume of traffic entering and exiting the development. <u>Trip Generation Manual (11th Edition)</u> published by the Institute of Transportation Engineers (ITE) is used as a reference for this information. The trip rate for the peak hour of the generator may or may not coincide in time or volume with the trip rate for the peak hour of adjacent street traffic. Volumes generated during the peak hour of the adjacent street traffic and proposed land use, in this case, the weekday AM and PM peak hours represent a more critical volume when analyzing the capacity of the system; those intervals will provide the basis of this analysis.

According to the ITE, the following steps are recommended when determining trip generation for proposed land uses:

- i. Check for the availability of local trip generation rates for comparable uses.
- If local trip data for similar developments are not available and time and funding permit, conduct trip generation studies at sites with characteristics similar to those of the proposed development.

Trip generation data for the proposed Starbucks was derived from count data collected at a similar site at 1806 Penfield Rd, Penfield, NY given the similar services provided at the proxy site and that both the proposed South Main St site and the Penfield site do not have a drive thru. Trip generation data was collected at the Penfield location on Friday, August 11, 2023 between 6:30-9:00 AM. The Penfield site is located in the walkable "four corners" area of Penfield. Given that the AADT of Penfield Rd adjacent to the proxy site is significantly greater than the AADT of South Main St in Fairport, a ratio of the two AADTs was applied to the collected trip generation data to determine the site generated trips for the proposed project. Additionally, the proposed site is located in the center of the Village of Fairport. As such, the proposed project is likely to get more pedestrian traffic from the offices and residential areas nearby and less vehicular traffic, unlike the Penfield Rd site which exhibited greater vehicular traffic. Trip generation data was not collected during the PM peak hour as Starbucks does not generate a significant volume of traffic during that time period.

Additionally, historical trip generation data was obtained for two former stand-alone Starbucks locations along Route 31 in Pittsford, NY and West Ridge Rd in Greece, NY. Neither of these locations had a drive thru when they were operational. Trip generation data was collected at these locations on Wednesday, December 13, 2000 between 7:00-9:00 AM. These trip generations volumes are used solely for comparison in **Table 2**. It should be noted that the ITE trip generation database contains data from all time periods dating back to the 1990s. Considering that the data for the Pittsford and Greece locations is 23 years old, using this historical data for comparison purposes remains applicable.





Similar to the Penfield location mentioned above, the proposed location is likely to generate more pedestrian traffic compared to the historical Pittsford and Greece locations, which were located along more heavily trafficked corridors and weren't as pedestrian friendly as the proposed site.

Trip generation data for the proposed "The Cub Room" restaurant was derived from count data collected at the existing location at 739 South Clinton Ave, Rochester, NY. Trip generation data was collected at The Cub Room on Thursday, August 10, 2023 between 5:00-7:00 PM. Data was not collected during the AM peak hour as the restaurant does not operate during the weekday AM peak hour.

Table 2 shows historical trip generation data taken from the Route 31, Pittsford NY and West Ridge Rd, Greece, NY former Starbucks locations, trip generation data collected at the Starbucks at 1806 Penfield Rd, Penfield, NY, and the estimated site generated trips that will be added to the existing roadway system under full project development. All trip generation information is included in the Appendices.

DECODIDATION	CIZE	AADT1	AM PEA	K HOUR	PM PEAK HOUR			
DESCRIPTION	SIZE	AADT ¹	ENTER	EXIT	ENTER	EXIT		
Route 31 Pittsford Starbucks		16,000 NYSDOT (1997)	56	52	N/A	N/A		
West Ridge Road Greece Starbucks		39,600 NYSDOT (2000)	47	51	N/A	N/A		
1806 Penfield Road Starbucks		32,539 NYSDOT (2018)	78	78	N/A	N/A		
Proposed Starbucks	±2,500 SF	11,216 NYSDOT (2018)	27	27	N/A	N/A		
Proposed "The Cub Room"	±4,633	-	0	0	22	0		
Total Site Generated Trips			27	27	22	0		
Note: 1. Estimated AADT in Vehicles per Day (vpd). AADT Source (Year).								

Table 2: Site Generated Trips

The proposed project is expected to generate approximately 27 entering/27 exiting vehicle trips during the AM peak hour and 22 entering/0 exiting vehicle trips during the PM peak hour.

TRIP DISTRIBUTION

The cumulative effect of site-generated traffic on the transportation network is dependent on the origins and destinations of that traffic. The proposed arrival/departure distribution of traffic generated by the proposed project is considered a function of several parameters, including:

- Residential and commercial centers in the area using US Census Data (e.g., OnTheMap).
- Site access location.
- Existing traffic patterns.

Figure 3 depicts the anticipated trip distribution pattern percentages for the traffic from the proposed project and **Figure 4** illustrates the peak hour site generated traffic based on those percentages for the project's site generated trips.



THRESHOLDS FOR THE REQUIREMENT OF A TRAFFIC IMPACT STUDY

Many reviewing agencies, including the NYSDOT and Monroe County Department of Transportation (MCDOT), use a guideline in determining whether a project warrants the preparation of a Traffic Impact Study (TIS). The applicable guideline is that if a proposed project is projected to add 100 or more site generated vehicles per hour (vph) to an adjacent intersection during either peak study period, then that intersection should be studied for potential traffic impacts.

Based upon the projected trip generation data and the resulting traffic assignment estimates shown in **Figure 4**, 54 or fewer peak hour trips are added to a single intersection during the peak hours studied. Therefore, the proposed project does not warrant a TIS.

CONCLUSIONS AND RECOMMENDATIONS

Given the projected site generated traffic, the anticipated site traffic distribution (54 or fewer peak hour trips added to a single adjacent intersection during the peak hours studied), the thresholds for completing a TIS, and the roadway characteristics previously described, a full TIS report is not warranted for the development proposed at this site. The proposed development is not expected to have a significant adverse impact on traffic operations at the site driveway or adjacent roadway.

If you have any questions or require additional information, please do not hesitate to contact our office.

Sincerely,

SRF Associates

A Passero Associates Company

Amy C. Dake, P.E., PTOE

Senior Managing Traffic Engineer

Attachments

 $Y: \label{thm:local_condition} Y: \label{thm:local_condition$

ATTACHMENT

August 30, 2023

Letter to Mr. Angelo Ingrassia

58 South Main Street Development


Trip Generation and Distribution Assessment

Village of Fairport Monroe County, New York





242 West Main Street, Suite 100 Rochester, NY 14614 T 585.325.1000 | www.srfa.net | www.passero.com

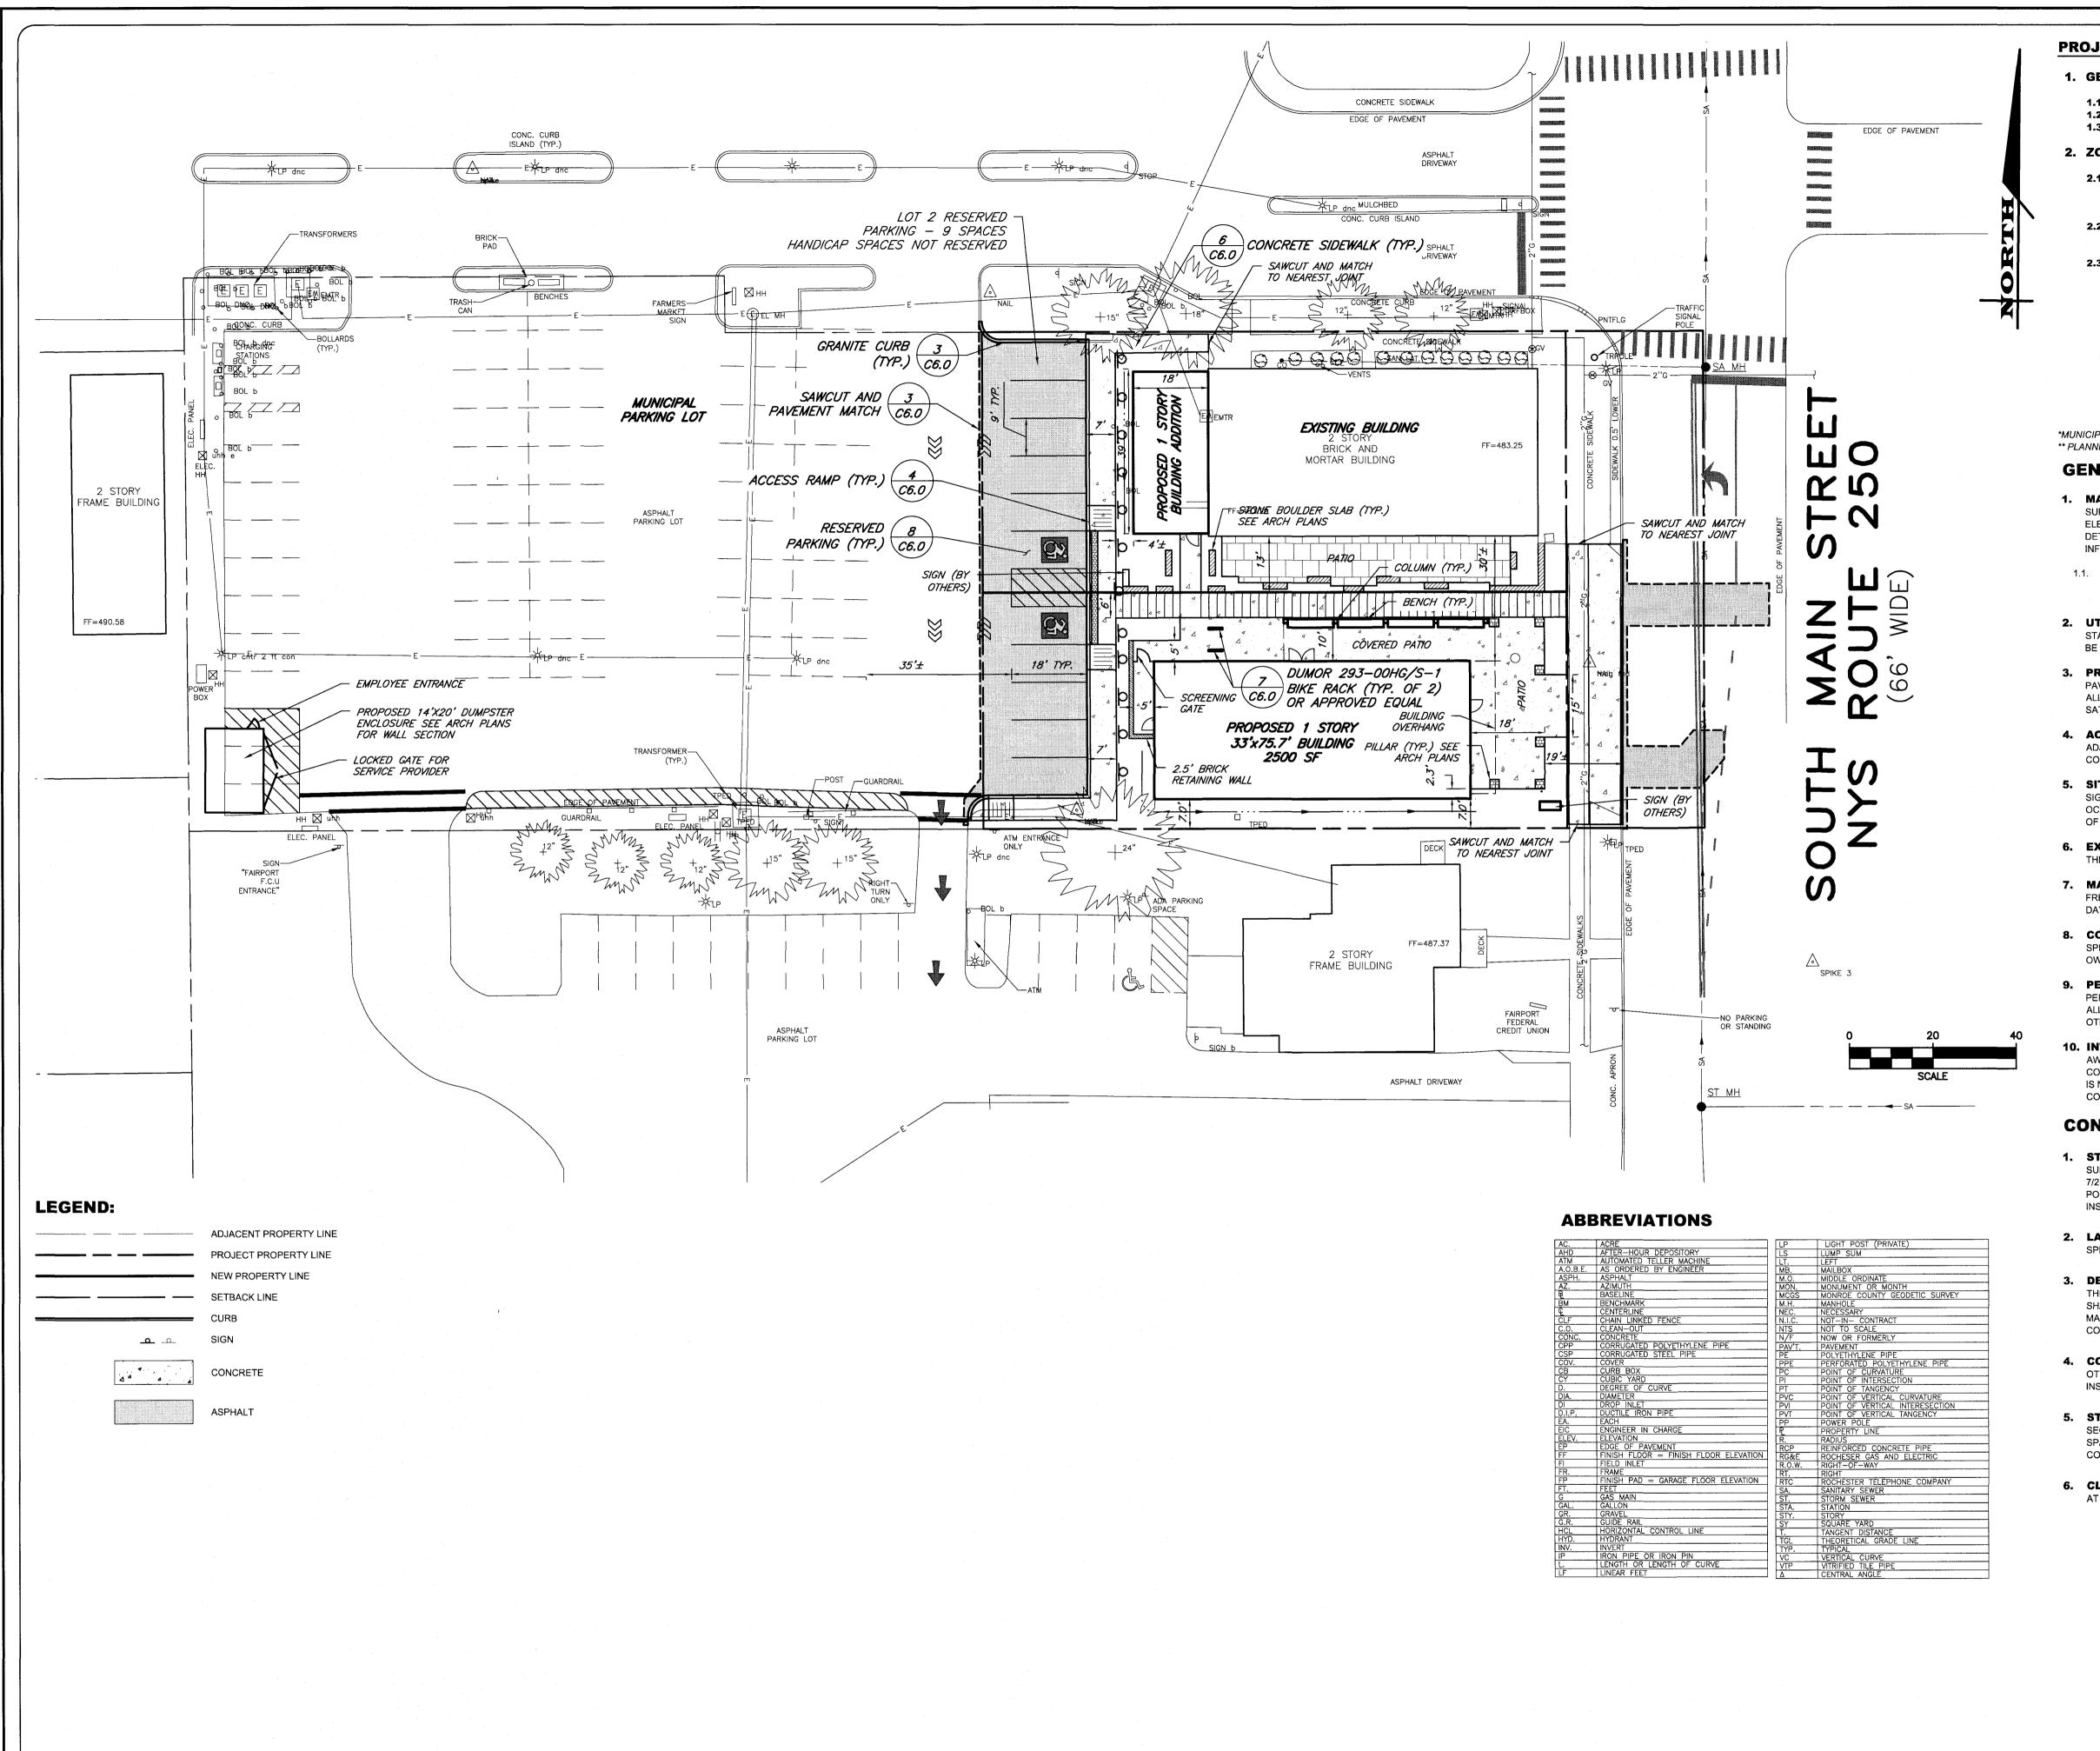

PROJECT STATISTICS

1. GENERAL:

1.1 PROPERTY ADDRESS - 58 S. MAIN STREET 1.2 TAX ACCOUNT -153.13-1-16.1 1.3 PARCEL SIZE -0.381 ACRES

2. ZONING REGULATIONS:

2.1 ZONING DISTRICT

B-1 COMMERCIAL BUSINESS (ARTICLE VII.550-32) DESIGN OVERLAY DISTRICT (ARTICLE IX)

2.2 PROPOSED USES -

RESTAURANTS ARE PERMITTED USES WITHIN THE ZONING DISTRICT

2.3 CODE REQUIREMENTS -

PROPOSED LOT 1 PROPOSED LOT 2 REQUIRED MAXIMUM BUILDING COVERAGE 16.7% 15.7% 8,697 SF 7,892 5000 SF

MAXIMUM PARKING/ LANE COVERAGE MINIMUM LOT AREA MINIMUM LOT WIDTH MINIMUM LOT DEPTH FRONT SETBACK 16'** 6.7'(EXIST.)* SIDE SETBACK (MIN.-MAX) 0-10' 8.7'(EXIST.) 6.5' REAR SETBACK 47.7' 36.4' MIN. BUILDING HEIGHT **EXISTING** PARKING LOCATION* SIDE OR REAR REAR REAR

*MUNICIPAL LOT WITHIN 500' OF PROJECT

** PLANNING BOARD CAN INCREASE FOR OUTDOOR EATING/ SEMIPUBLIC USES

GENERAL NOTES

- 1. MAPPING THE EXISTING UNDERGROUND UTILITIES WERE PLOTTED BASED ON RECORD MAPPING SUPPLIED BY OTHERS. THE ENGINEER MAKES NO WARRANTY AS TO THE LOCATION, SIZE, TYPE, ELEVATION, AND/OR NUMBER OF EXISTING UTILITIES. THE CONTRACTOR SHALL BE RESPONSIBLE FOR DETERMINING THE HORIZONTAL AND VERTICAL LOCATION OF UTILITIES IN THE VICINITY OF THE NEW INFRASTRUCTURE.
- 1.1. ALL UTILITY LOCATIONS SHOWN ARE APPROXIMATE. CONTRACTOR SHALL VERIFY ALL LOCATIONS BEFORE BEGINNING WORK AS REQUIRED BY APPLICABLE LAWS AND
- 2. UTILITY STAKEOUT THE CONTRACTOR SHALL NOTIFY UDIG NY (1-800-962-7962) FOR A UTILITY STAKEOUT 48 HOURS IN ADVANCE OF COMMENCING WORK. STAKEOUT OF PRIVATE UTILITIES SHALL BE COORDINATED WITH THE OWNER.
- 3. PROPERTY PROTECTION THE CONTRACTOR IS RESPONSIBLE FOR DAMAGE TO EXISTING PAVEMENT, CURBS, WALKS, LAWNS, TREES, ETC. CAUSED BY THEIR CONSTRUCTION OPERATIONS. ALL DAMAGE SHALL BE REPAIRED OR REPLACED BY THE CONTRACTOR TO THE OWNER'S SATISFACTION AT NO ADDITIONAL EXPENSE.
- 4. ACCESS THE CONTRACTOR SHALL PROVIDE SATISFACTORY VEHICULAR ACCESS TO ALL ADJOINING PROPERTIES, PRIVATE ROADWAYS, PARKING FACILITIES, AND PUBLIC STREETS DURING
- 5. SITE SAFETY PRIOR TO AND THROUGHOUT CONSTRUCTION, THE CONTRACTOR SHALL POST SIGNAGE IN CONFORMANCE WITH THE REQUIREMENTS OF THE LOCAL MUNICIPALITY AND OCCUPATIONAL HEALTH AND SAFETY ACT (OHSA). JOB SAFETY AND MAINTENANCE AND PROTECTION OF TRAFFIC IS THE RESPONSIBILITY OF THE CONTRACTOR.
- 6. **EXCAVATIONS** ALL EXCAVATIONS SHALL BE BACKFILLED/BARRICADED TO THE SATISFACTION OF THE OWNER'S REPRESENTATIVE AT THE CONCLUSION OF EACH WORKING DAY.
- 7. MAINTENANCE PUBLIC STREETS, PRIVATE DRIVES AND PARKING FACILITIES SHALL BE KEPT FREE OF FOREIGN MATERIALS. ALL AREAS SHALL BE SWEPT CLEAN AT THE END OF EACH WORKING DAY AND/OR AS DIRECTED BY THE OWNER'S ON-SITE REPRESENTATIVE.
- 8. CONSTRUCTION STORAGE STORAGE OF EQUIPMENT AND MATERIALS SHALL BE WITHIN A SPECIFIED AND SECURED AREA AS DETERMINED IN CONTRACT DOCUMENTS OR AS SPECIFIED BY THE OWNER'S ON-SITE REPRESENTATIVE.
- 9. PERMIT(S) PRIOR TO CONSTRUCTION, THE CONTRACTOR SHALL OBTAIN THE NECESSARY PERMITS FROM THE APPLICABLE MUNICIPALITY OR AGENCY. THE CONTRACTOR IS RESPONSIBLE FOR ALL BONDS AND INSURANCES AND THE OWNER IS RESPONSIBLE FOR PERMIT FEES UNLESS OTHERWISE STATED IN THE OWNER/ CONTRACTOR AGREEMENT
- 10. INTERIM CONDITIONS THE CONTRACTOR IS RESPONSIBLE TO MAINTAIN POSITIVE DRAINAGE AWAY FROM BUILDINGS AND WITHIN PROJECT AREA TO A STABILIZED OUTLET THROUGHOUT THE CONSTRUCTION PERIOD. THIS MAY REQUIRE INTERIM GRADING, SHIMMING OF PAVEMENT ETC. THAT IS NOT SPECIFICALLY SHOWN ON THE PLANS AND SHALL BE THE RESPONSIBILITY OF THE

CONSTRUCTION

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- 2. LAYOUT DIMENSIONS SHOWN, WHERE APPLICABLE, SHALL BE FROM THE FACE OF CURB UNLESS SPECIFICALLY CALLED OUT OTHERWISE.
- 3. **DEMOLITION** CLEARING AND GRUBBING SHALL BE LIMITED TO THE SITE BOUNDARIES OR WITHIN THE "WORK LIMIT LINE" AS DEFINED ON THE PLAN. TREES AND OBJECTS DESIGNATED FOR REMOVAL SHALL BE COORDINATED AND FIELD VERIFIED WITH PROJECT ON-SITE REPRESENTATIVE. ALL MATERIALS SHALL BE LEGALLY DISPOSED OF OFF-SITE OR RETURNED TO OWNER AS DIRECTED BY CONTRACT DOCUMENTS. ALL ITEMS NOT SPECIFICALLY CALLED OUT TO BE REMOVED SHALL REMAIN.
- 4. COORDINATION THE CONTRACTOR SHALL COORDINATE INSTALLATION OF UTILITY WORK WITH OTHER SITE UTILITIES (I.E. GAS, ELECTRIC, LIGHTING, COMMUNICATIONS) TO AVOID POTENTIAL INSTALLATION CONFLICTS.
- 5. STAGING AS DEFINED BY THE CONTRACT DOCUMENTS THE CONTRACTOR SHALL CONSTRUCT A SECURE STAGING AREA FOR STORAGE OF EQUIPMENT, MATERIALS, EMPLOYEE PARKING AND OFFICE SPACE. IF THE AREA/METHOD IS NOT SPECIFICALLY DEFINED ON THE DOCUMENTS THEN IT SHALL BE COORDINATED WITH THE OWNER'S ON-SITE REPRESENTATIVE.
- 6. CLOSE-OUT THE CONTRACTOR'S WORK SCOPE INCLUDES BUT IS NOT LIMITED TO THE FOLLOWING AT PROJECT CLOSE-OUT TO THE SATISFACTION OF OWNER'S ON-SITE REPRESENTATIVE:
 - REMOVAL OF ANY CONSTRUCTION DEBRIS.
 - CLEANING PAVEMENT AND WALKWAY SURFACES.
 - RESTORATION OF ALL DISTURBED GRASS AND LANDSCAPED AREAS.
 - PROVIDING BONDS, GUARANTEES, CERTIFICATIONS, ETC. AS REQUIRED BY CONTRACT DOCUMENTS.
 - PROVIDING REDLINES FOR RECORD DRAWING.
 - COMPLETION OF FINAL PUNCH LIST ITEMS.

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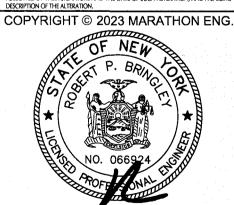
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JOB NO: 1454-22 SCALE: 1"=20" DRAWN: JWS DESIGNED: MPT DATE: 7/24/2023 **REVISIONS**

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DRAWING TITLE:

4 of 9 SHEET No:

DRAWING No:

LAYOUT PLAN

1454-22 JOB No:





Site Location and Study Area

Study Intersection

Study Area



Figure 2


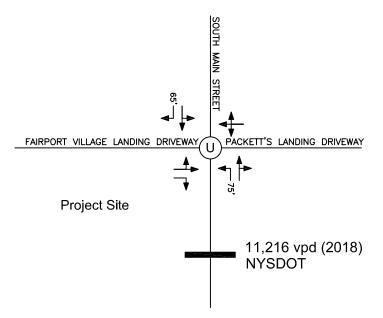


Figure 3



Lane Geometry and Average Daily Traffic


Trip Distribution

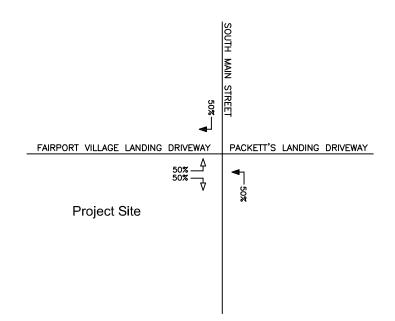

KEY:



Figure 4

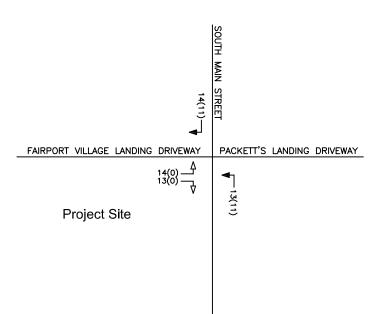

Site Generated Trips

N NOT TO SCALE

58 South Street Development | Village of Fairport, NY

00(00) = AM(PM)

Entering TripExiting Trip

KEY:

--- Proposed Access

8/10/2023 5-7pm Cub Room, 739 S Clinton Avenue, Rochester

	Right/Main Lot	# people from vehicles entering restaurant	# people exiting restaurant into vehicles	# of pedestrians entering restaurant	# of pedestrians exiting restaurant	<u>Left Parking</u> <u>Lot</u>	# people from vehicles entering restaurant	# people exiting restaurant into vehicles	# of pedestrians entering restaurant	# of pedestrians exiting restaurant	Rideshare Pick- Ups/Drop-Offs in front
5:00-5:15		-	-	1	1		1	-	-	=	=
5:15-5:30		0	1	-	-		-	-	-	-	-
5:30-5:45		1	-	-	-		1	-	-	-	-
5:45-6:00		7	-	1	-		-	-	-	-	-
6:00-6:15		-	-	2	-		-	-	-	-	-
6:15-6:30		-	-	-	-		8	-	6	-	-
6:30-6:45		5	-	-	-		3	-	-	=	=
6:45-7:00		4	=	2	2		2	=	2	=	=
		9	0	4	2		13	0	8	0	

8/11/2023 6:30-9am Starbucks, 1806 Penfield Road, Penfield

	<u>Front Lot</u>	# people from vehicles entering SB	# people exiting SB into vehicles	# of pedestrians entering SB	# of pedestrians exiting SB	<u>Rear Lot</u>	# people from vehicles entering SB	# people exiting SB into vehicles	# of pedestrians entering SB	# of pedestrians exiting SB		
6:30-6:45		6	6	1	1		2	2	1	1	16	
6:45-7:00		7	6	1	1		3	3	-	1	19	
7:00-7:15		7	3	2	1		2	2	-	-	14	
7:15-7:30		12	8	-	-		3	2	-	-	25	74
7:30-7:45		17	12	-	-		5	8	-	-	42	100
7:45-8:00		7	12	-	-		2	4	1	-	25	106
8:00-8:15		11	16	-	-		7	5	-	-	39	131
8:15-8:30		11	9	-	-		6	4	-	1	30	136
8:30-8:45		17	9	-	-		5	13	-	-	44	138
8:45-9:00		19	16	-	-		2	6	-	-	43	156
		58	50	0	0		20	28	0	1		


PRELIM/FINAL SITE AND SUBDIVISION PLANS for

PROPOSED RESTAURANT BUILDING AND STARBUCKS

58 SOUTH MAIN STREET

SITUATE IN:

VILLAGE OF FAIRPORT - MONROE COUNTY - STATE OF NEW YORK

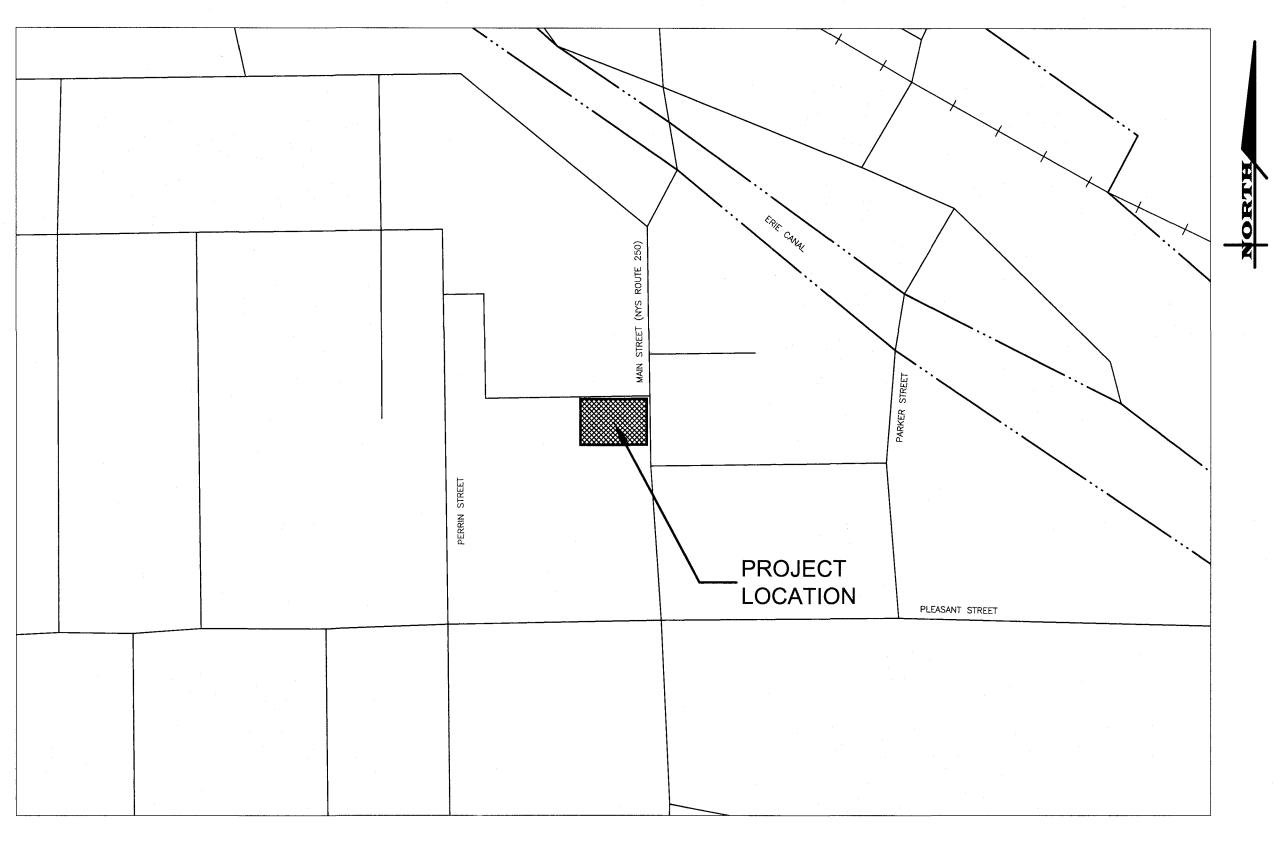

LOCATION MAP

NOT TO SCALE



ROCHESTER LOCATION


3 9 CASCADE DRIVE
ROCHESTER, NY 14614
5 8 5 - 4 5 8 - 7 7 7 0

ITHACA LOCATION

840 HANSHAW RD, STE 6
ITHACA, NY 14850
6 0 7 - 2 4 1 - 2 9 1 7

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		LIST OF DRAWINGS
No.	DWG. No.	Description
1	CO.0	COVER SHEET
2	C1.0	EXISTING CONDITIONS AND DEMOLITION PLAN
3	C2.0	SUBDIVISION PLAT
4	C3.0	LAYOUT PLAN
5	C4.0	UTILITY PLAN
6	C5.0	GRADING AND EROSION CONTROL PLAN
7	C6.0	CONSTRUCTION DETAILS
8	C6.1	CONSTRUCTION DETAILS
9	C6.2	CONSTRUCTION DETAILS

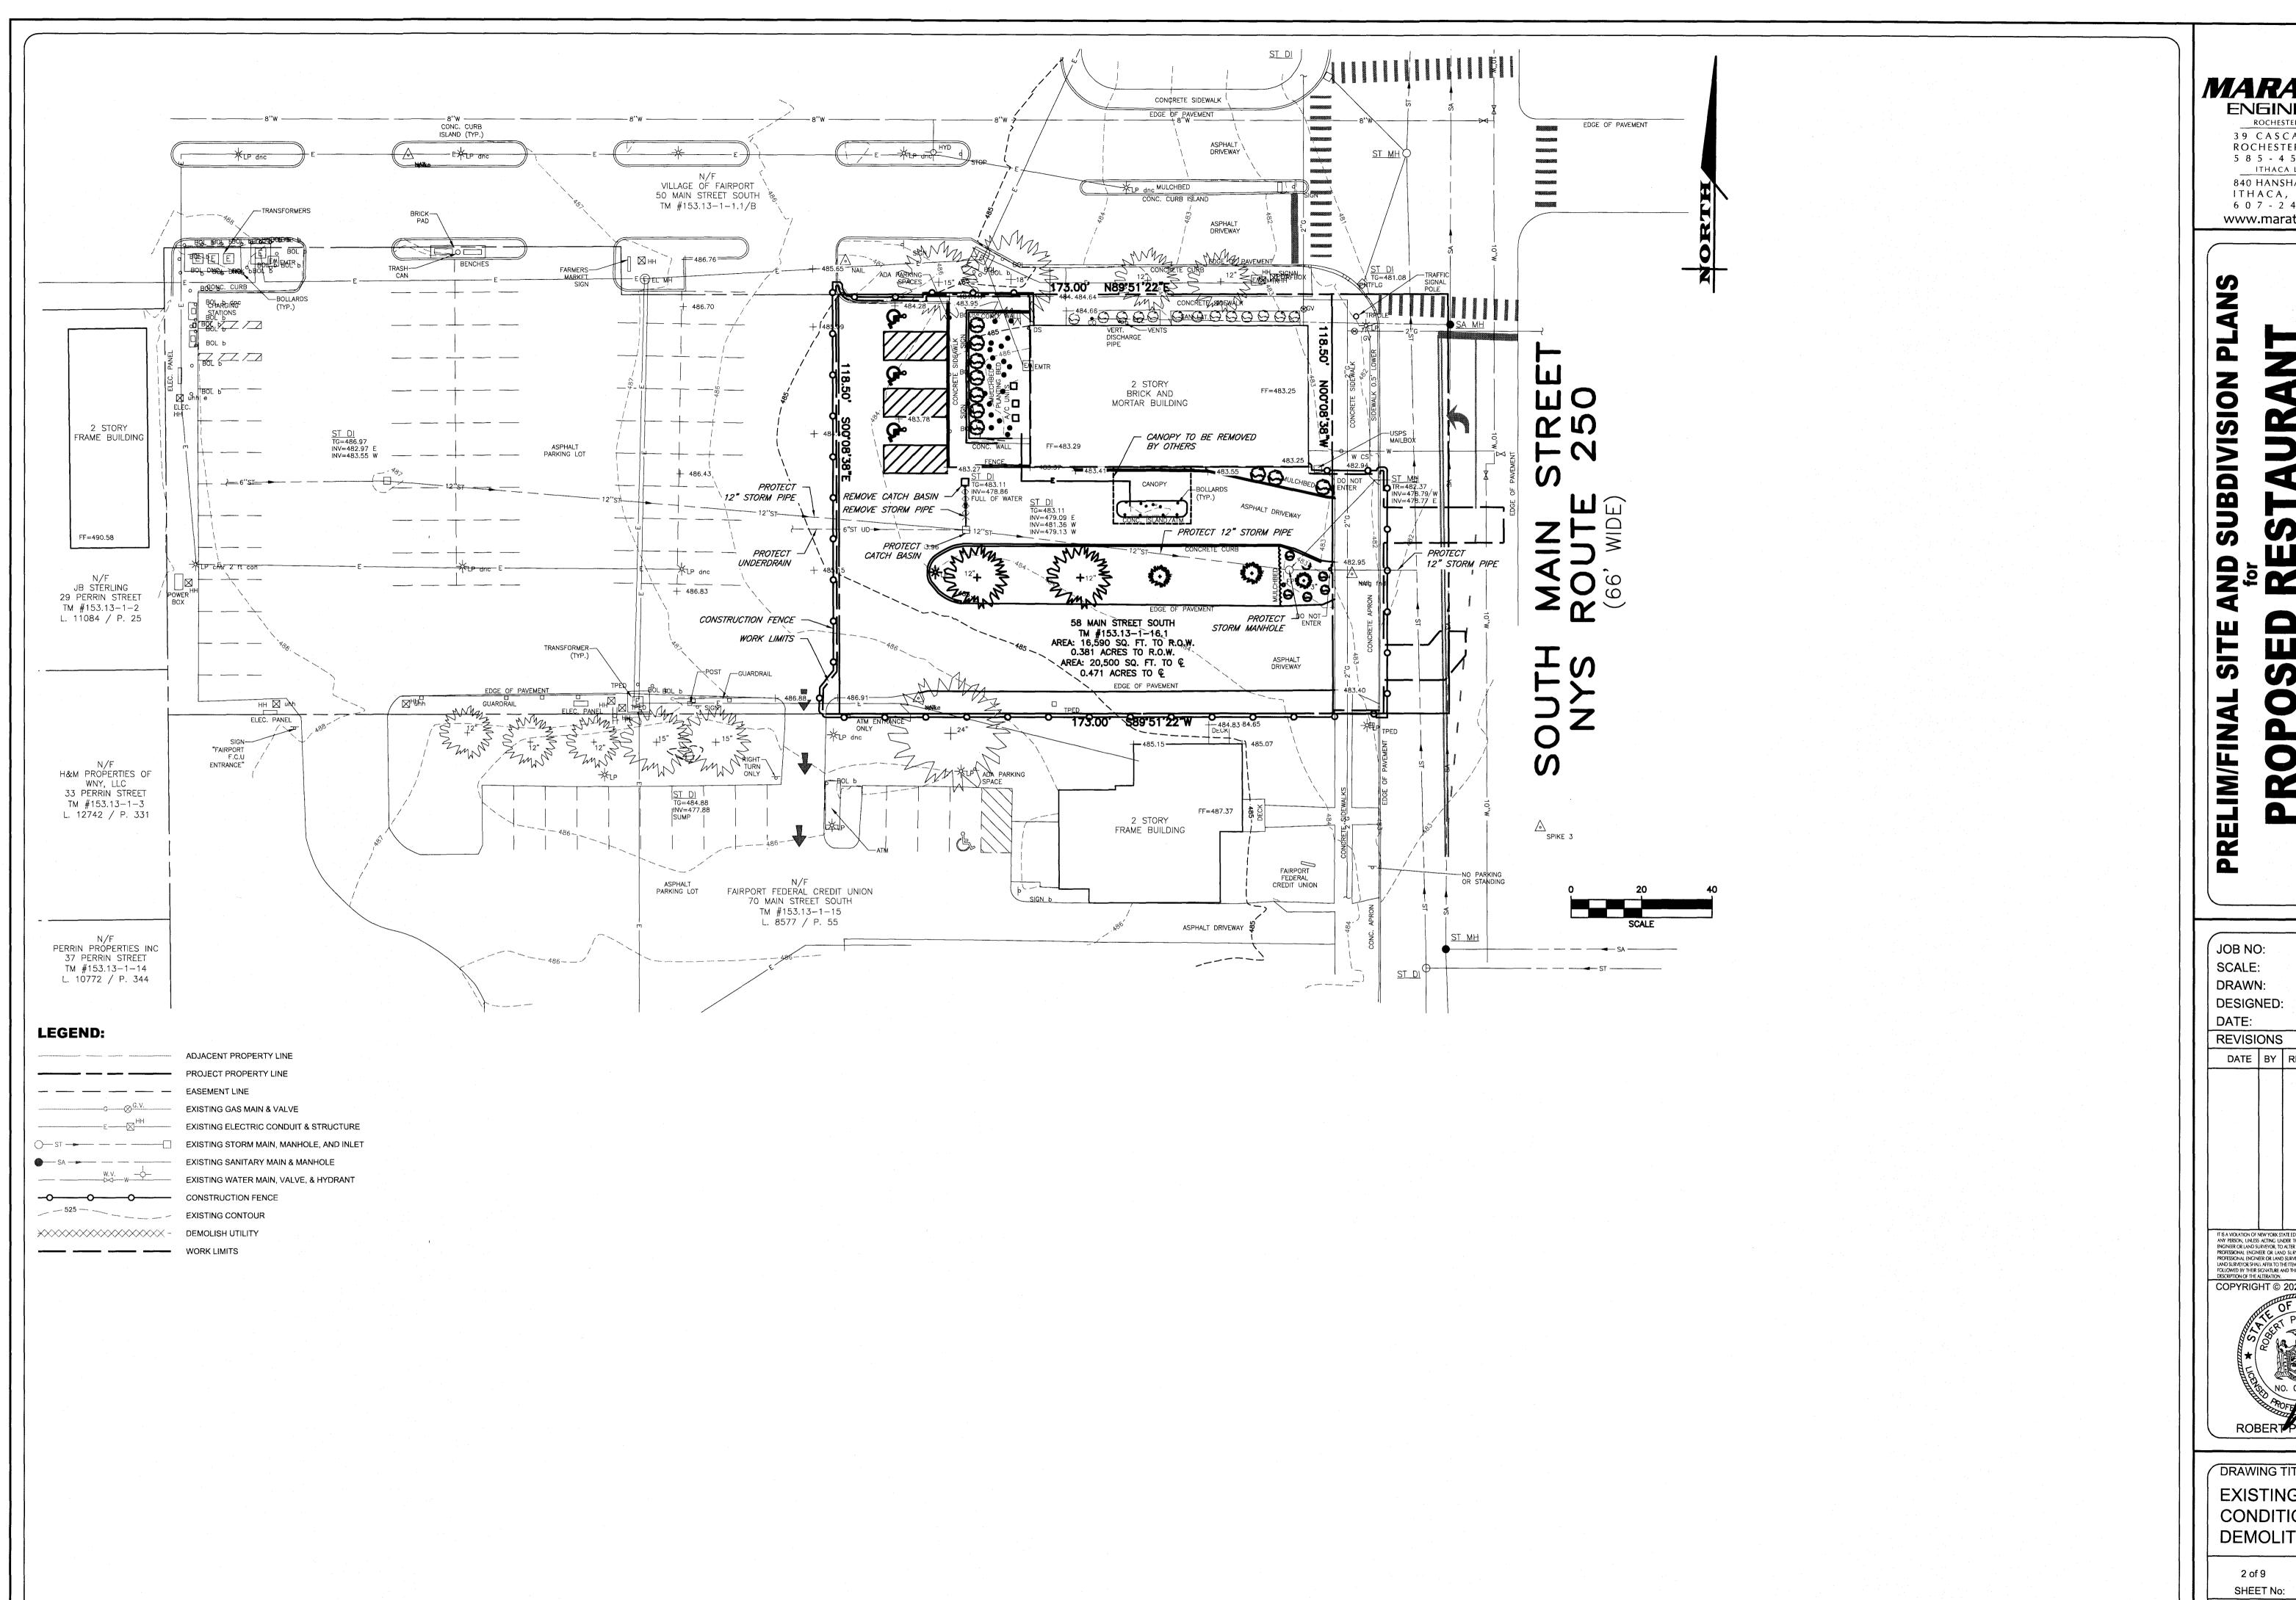

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7/24/2023

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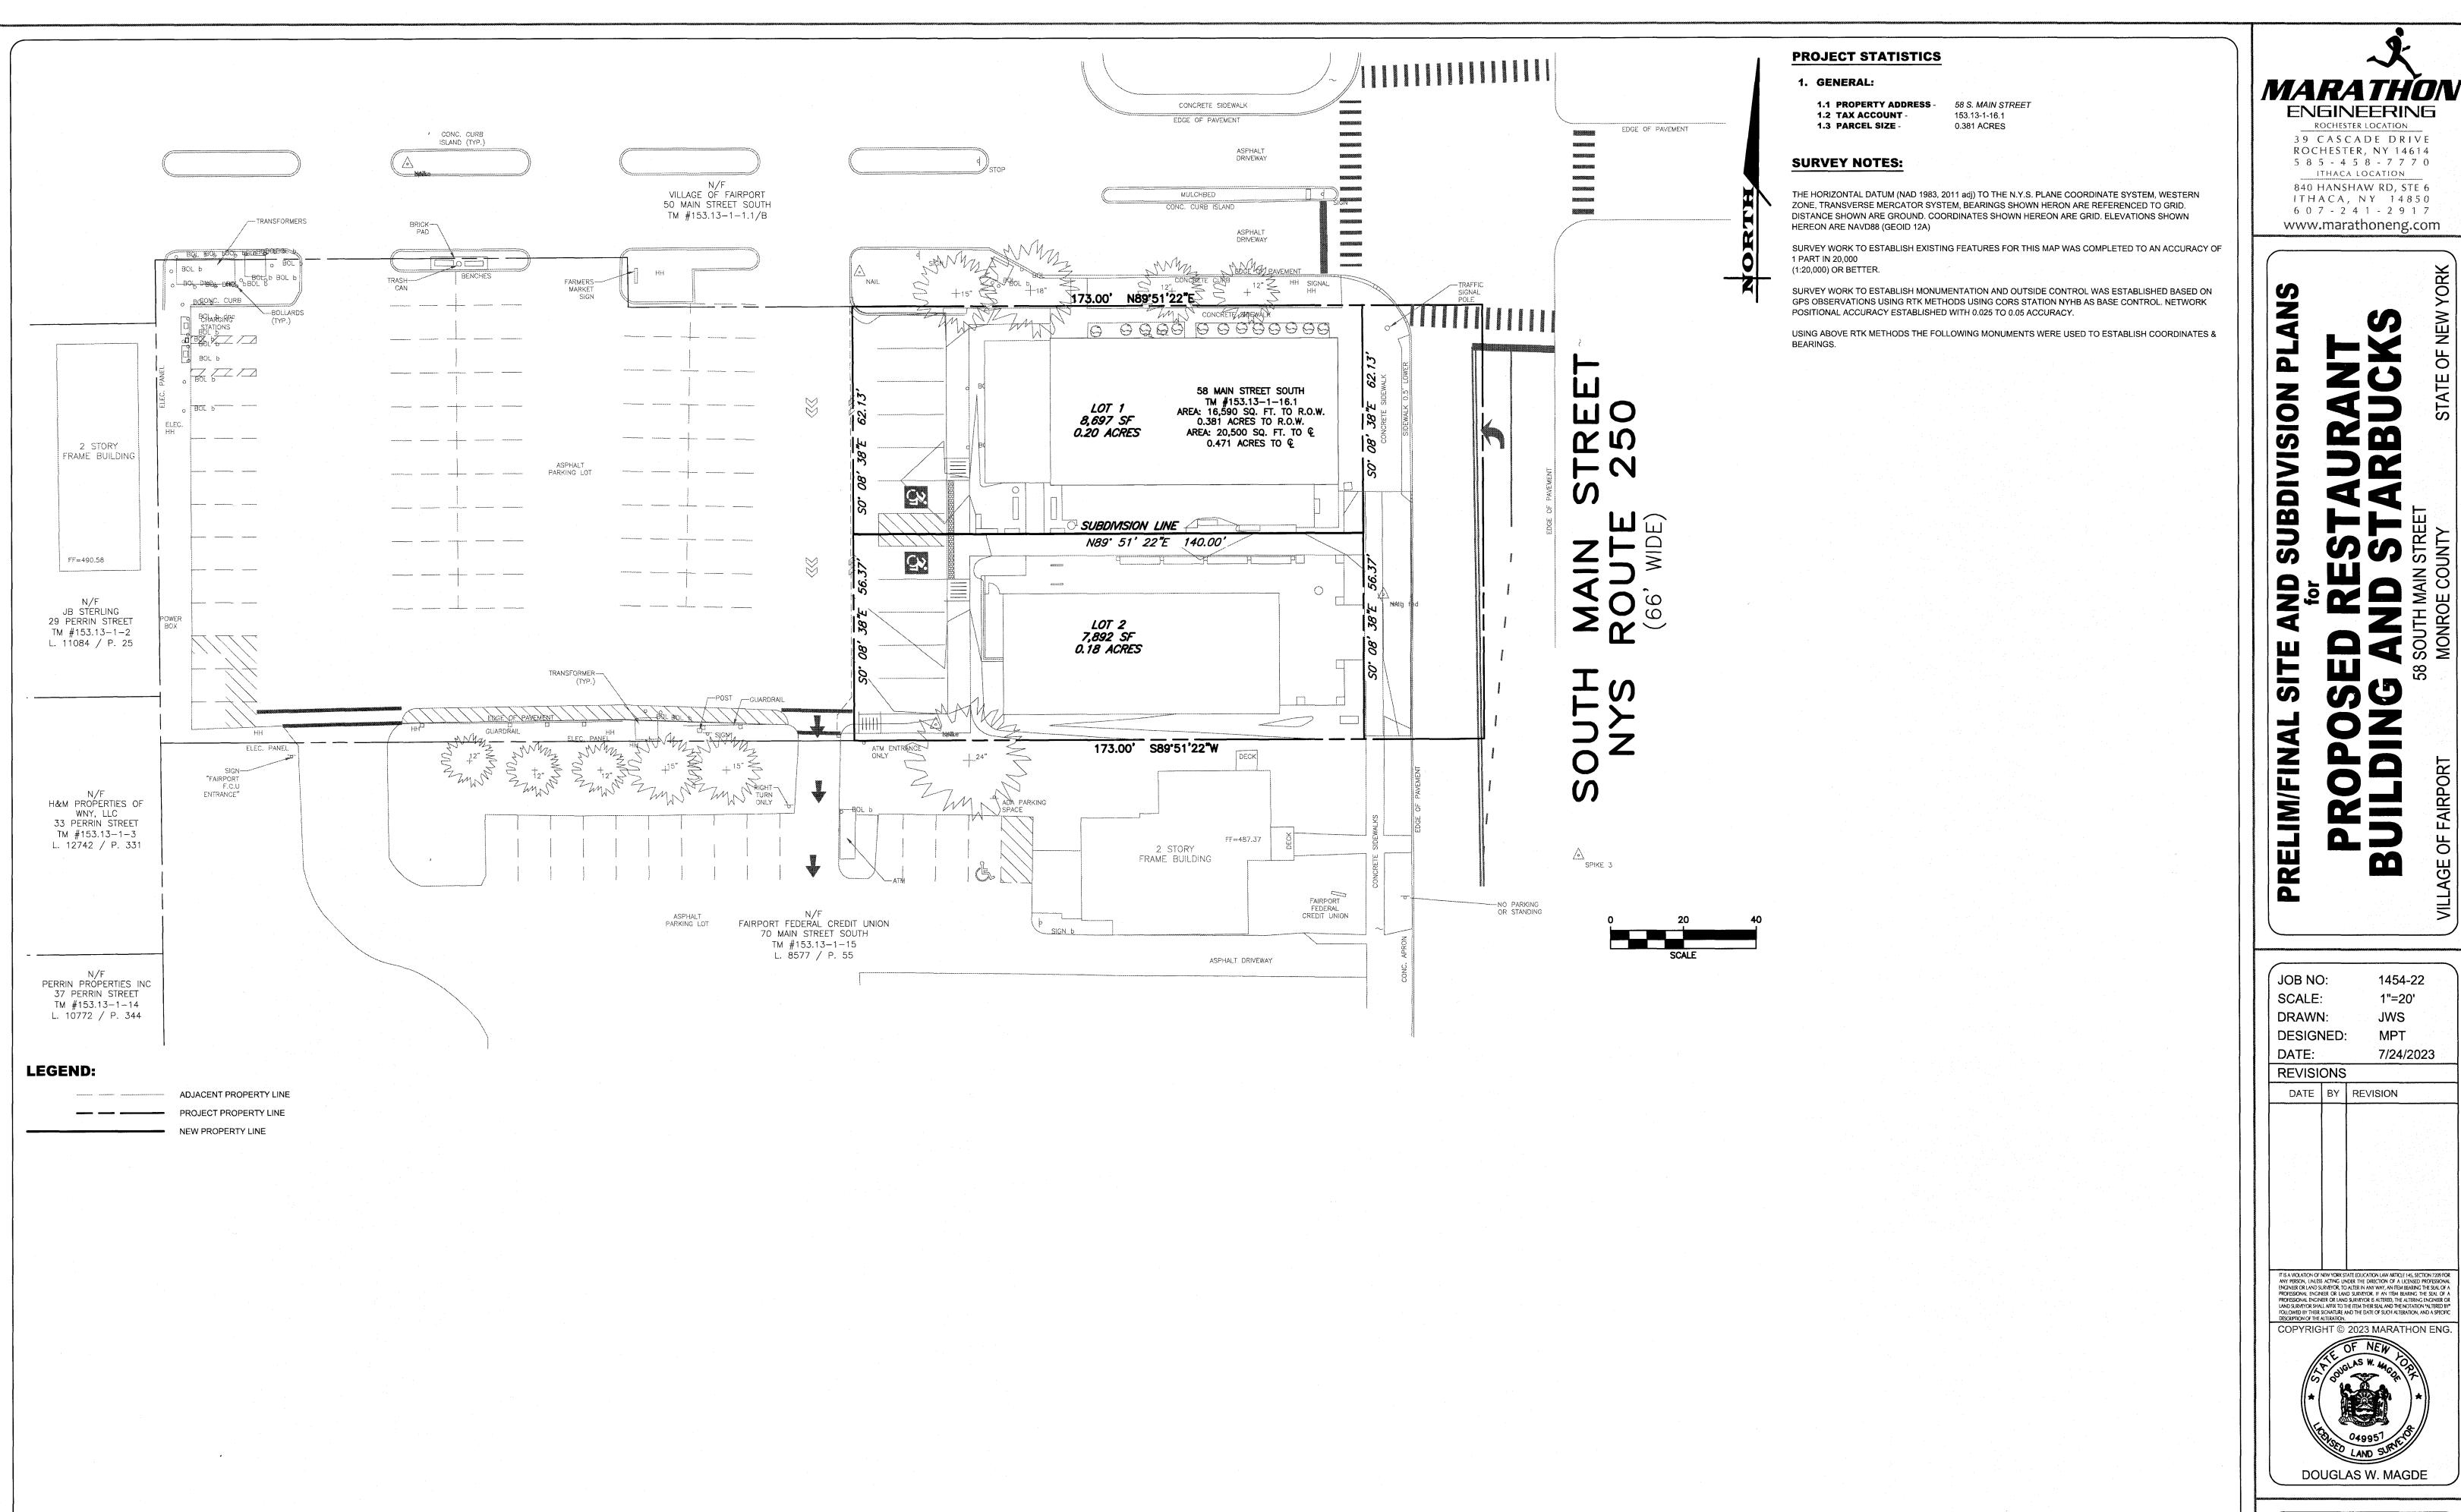
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DRAWING TITLE: **EXISTING CONDITIONS AND DEMOLITION PLAN**

1454-22

JOB No: DRAWING No:



ROCHESTER LOCATION

39 CASCADE DRIVE ROCHESTER, NY 14614

5 8 5 - 4 5 8 - 7 7 7 0 ITHACA LOCATION 840 HANSHAW RD, STE 6

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DOUGLAS W. MAGDE

DRAWING TITLE: SUBDIVISION PLAT

WE, MARATHON ENGINEERING, HEREBY CERTIFY THAT THIS


MAP WAS PREPARED FROM NOTES OF A FIELD SURVEY COMPLETED ON 07/07/22 AND FROM THE REFERENCES LISTED HEREON. SUBJECT TO ANY FACTS AN UPDATED

ABSTRACT OF TITLE MAY REVEAL.

DOUGLAS W. MAGDE, L.S. LIC. #049957

3 of 9 SHEET No: 1454-22

JOB No: DRAWING No:

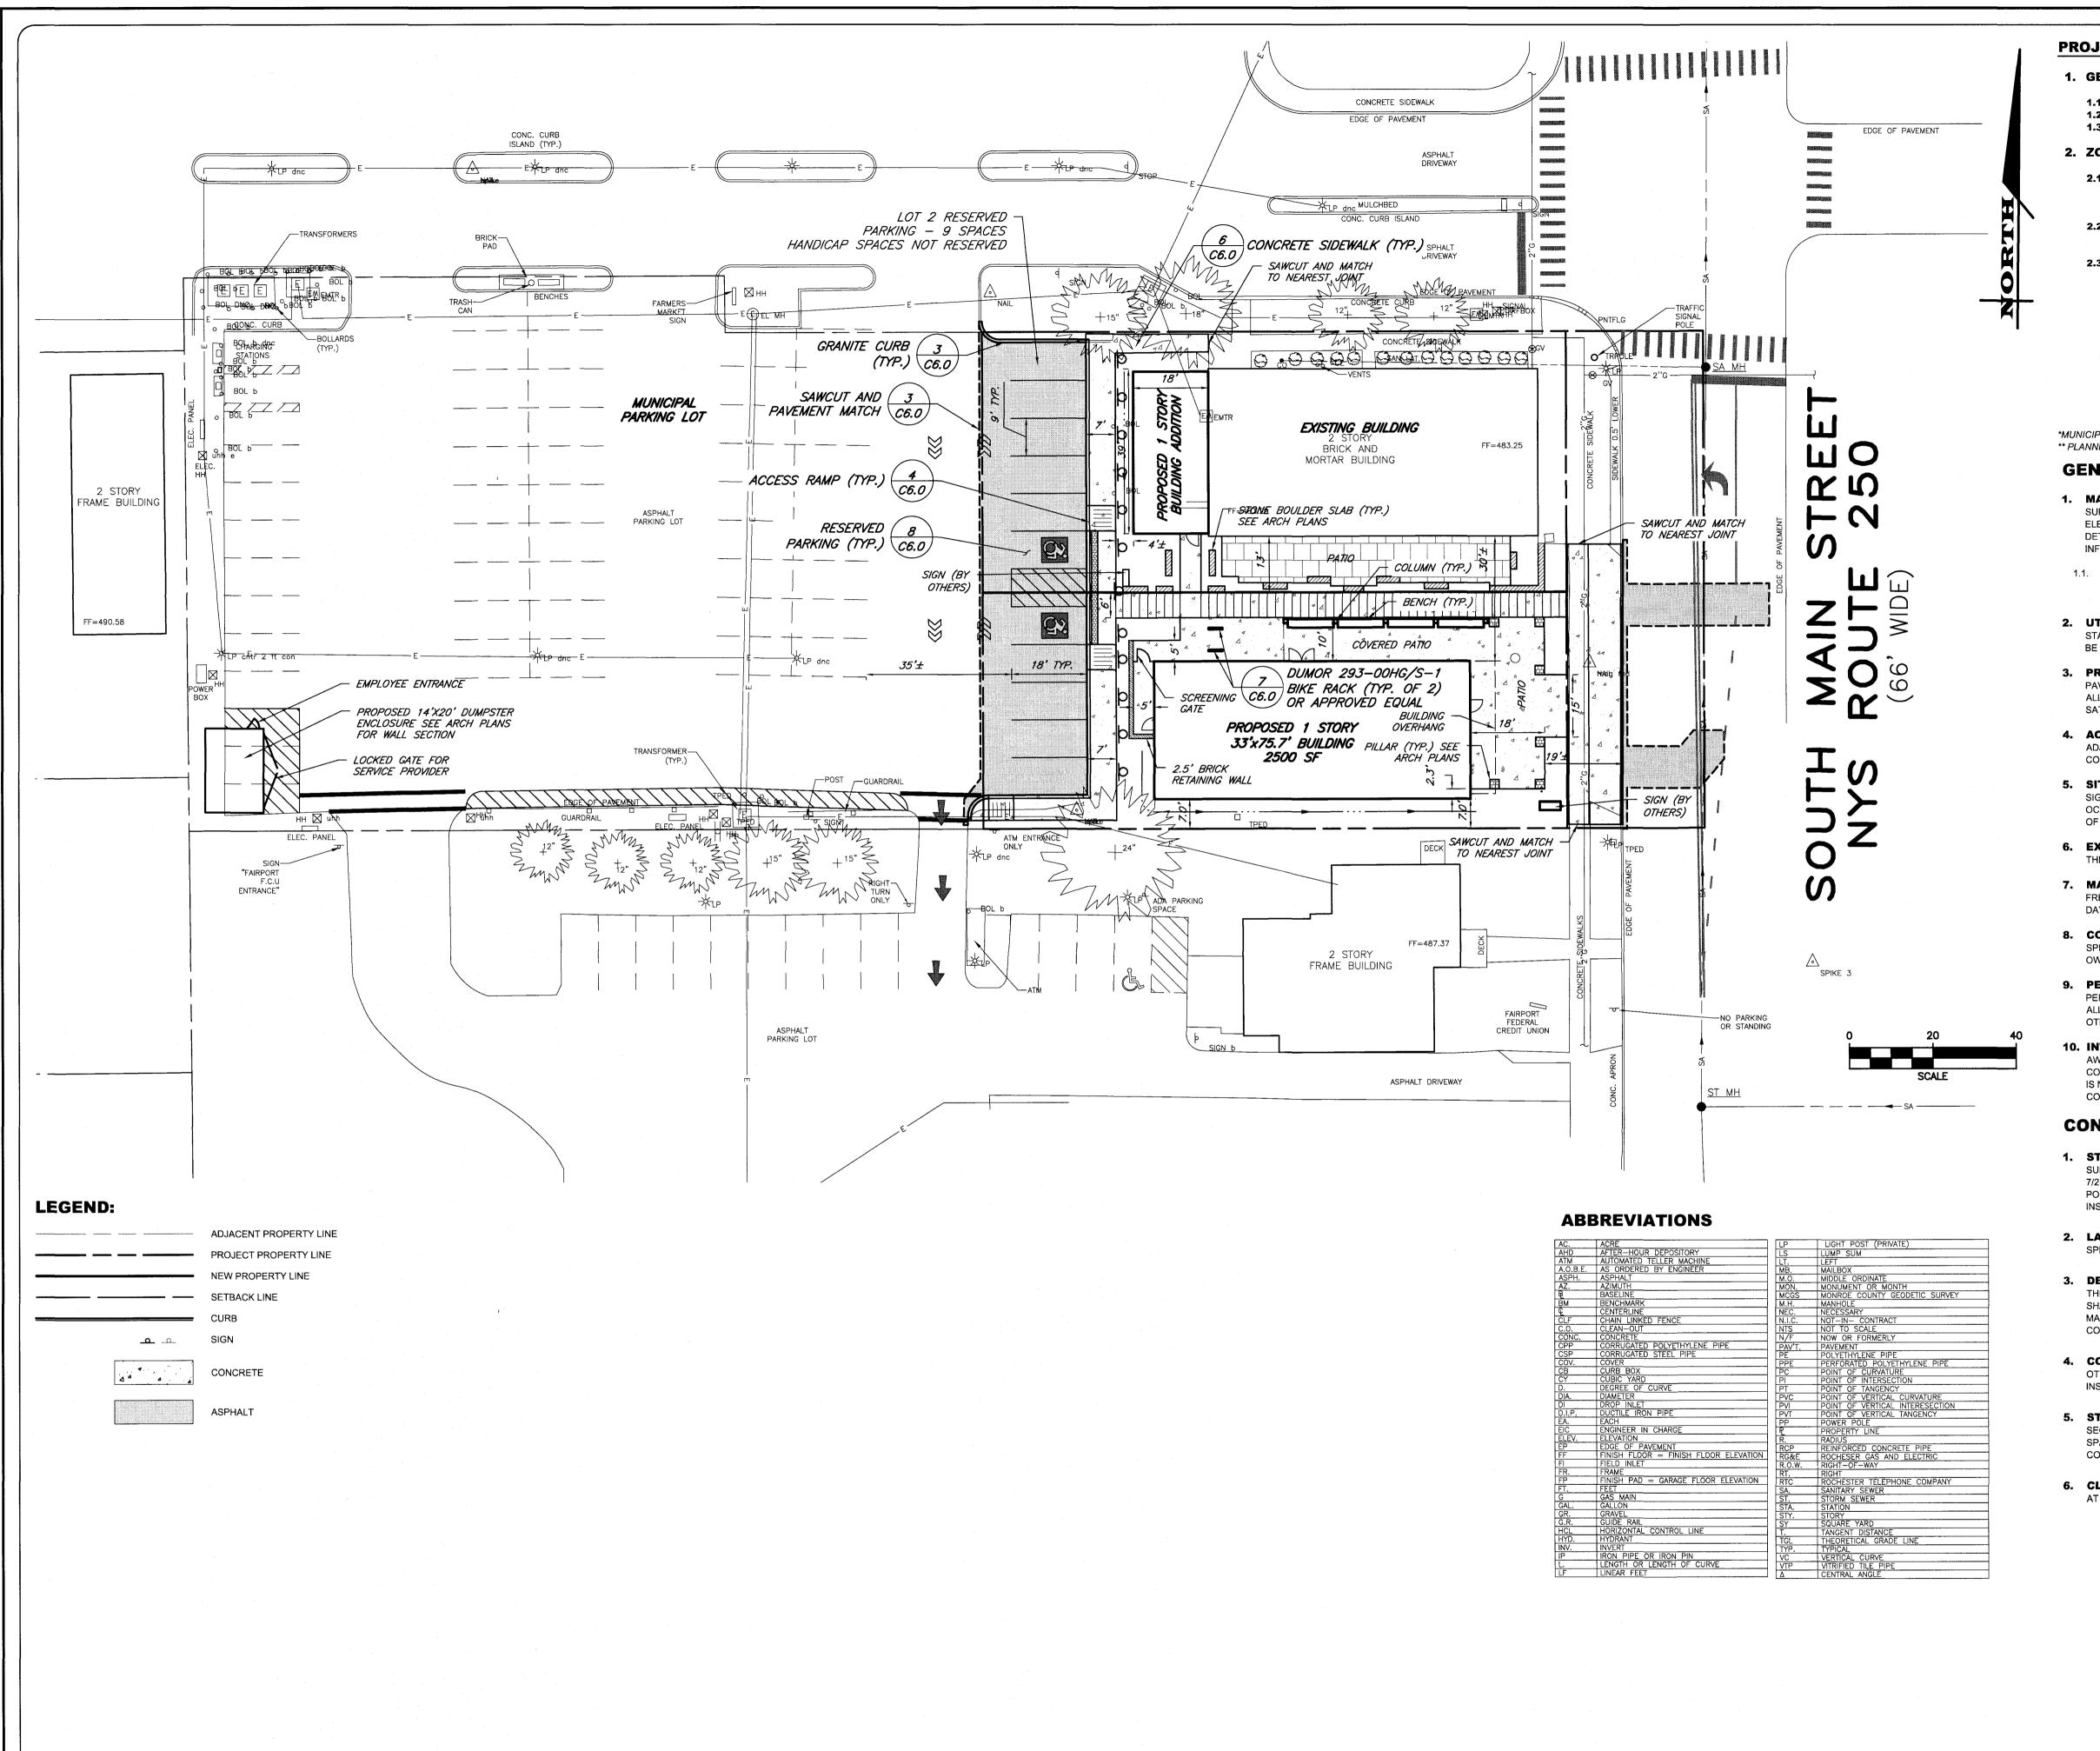

PROJECT STATISTICS

1. GENERAL:

1.1 PROPERTY ADDRESS - 58 S. MAIN STREET 1.2 TAX ACCOUNT -153.13-1-16.1 1.3 PARCEL SIZE -0.381 ACRES

2. ZONING REGULATIONS:

2.1 ZONING DISTRICT

B-1 COMMERCIAL BUSINESS (ARTICLE VII.550-32) DESIGN OVERLAY DISTRICT (ARTICLE IX)

2.2 PROPOSED USES -

RESTAURANTS ARE PERMITTED USES WITHIN THE ZONING DISTRICT

2.3 CODE REQUIREMENTS -

PROPOSED LOT 1 PROPOSED LOT 2 REQUIRED MAXIMUM BUILDING COVERAGE 16.7% 15.7% 8,697 SF 7,892 5000 SF

MAXIMUM PARKING/ LANE COVERAGE MINIMUM LOT AREA MINIMUM LOT WIDTH MINIMUM LOT DEPTH FRONT SETBACK 16'** 6.7'(EXIST.)* SIDE SETBACK (MIN.-MAX) 0-10' 8.7'(EXIST.) 6.5' REAR SETBACK 47.7' 36.4' MIN. BUILDING HEIGHT **EXISTING** PARKING LOCATION* SIDE OR REAR REAR REAR

*MUNICIPAL LOT WITHIN 500' OF PROJECT

** PLANNING BOARD CAN INCREASE FOR OUTDOOR EATING/ SEMIPUBLIC USES

GENERAL NOTES

- 1. MAPPING THE EXISTING UNDERGROUND UTILITIES WERE PLOTTED BASED ON RECORD MAPPING SUPPLIED BY OTHERS. THE ENGINEER MAKES NO WARRANTY AS TO THE LOCATION, SIZE, TYPE, ELEVATION, AND/OR NUMBER OF EXISTING UTILITIES. THE CONTRACTOR SHALL BE RESPONSIBLE FOR DETERMINING THE HORIZONTAL AND VERTICAL LOCATION OF UTILITIES IN THE VICINITY OF THE NEW INFRASTRUCTURE.
- 1.1. ALL UTILITY LOCATIONS SHOWN ARE APPROXIMATE. CONTRACTOR SHALL VERIFY ALL LOCATIONS BEFORE BEGINNING WORK AS REQUIRED BY APPLICABLE LAWS AND
- 2. UTILITY STAKEOUT THE CONTRACTOR SHALL NOTIFY UDIG NY (1-800-962-7962) FOR A UTILITY STAKEOUT 48 HOURS IN ADVANCE OF COMMENCING WORK. STAKEOUT OF PRIVATE UTILITIES SHALL BE COORDINATED WITH THE OWNER.
- 3. PROPERTY PROTECTION THE CONTRACTOR IS RESPONSIBLE FOR DAMAGE TO EXISTING PAVEMENT, CURBS, WALKS, LAWNS, TREES, ETC. CAUSED BY THEIR CONSTRUCTION OPERATIONS. ALL DAMAGE SHALL BE REPAIRED OR REPLACED BY THE CONTRACTOR TO THE OWNER'S SATISFACTION AT NO ADDITIONAL EXPENSE.
- 4. ACCESS THE CONTRACTOR SHALL PROVIDE SATISFACTORY VEHICULAR ACCESS TO ALL ADJOINING PROPERTIES, PRIVATE ROADWAYS, PARKING FACILITIES, AND PUBLIC STREETS DURING
- 5. SITE SAFETY PRIOR TO AND THROUGHOUT CONSTRUCTION, THE CONTRACTOR SHALL POST SIGNAGE IN CONFORMANCE WITH THE REQUIREMENTS OF THE LOCAL MUNICIPALITY AND OCCUPATIONAL HEALTH AND SAFETY ACT (OHSA). JOB SAFETY AND MAINTENANCE AND PROTECTION OF TRAFFIC IS THE RESPONSIBILITY OF THE CONTRACTOR.
- 6. **EXCAVATIONS** ALL EXCAVATIONS SHALL BE BACKFILLED/BARRICADED TO THE SATISFACTION OF THE OWNER'S REPRESENTATIVE AT THE CONCLUSION OF EACH WORKING DAY.
- 7. MAINTENANCE PUBLIC STREETS, PRIVATE DRIVES AND PARKING FACILITIES SHALL BE KEPT FREE OF FOREIGN MATERIALS. ALL AREAS SHALL BE SWEPT CLEAN AT THE END OF EACH WORKING DAY AND/OR AS DIRECTED BY THE OWNER'S ON-SITE REPRESENTATIVE.
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 - COMPLETION OF FINAL PUNCH LIST ITEMS.

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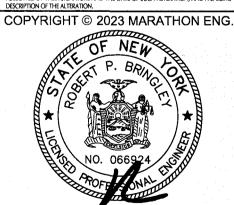
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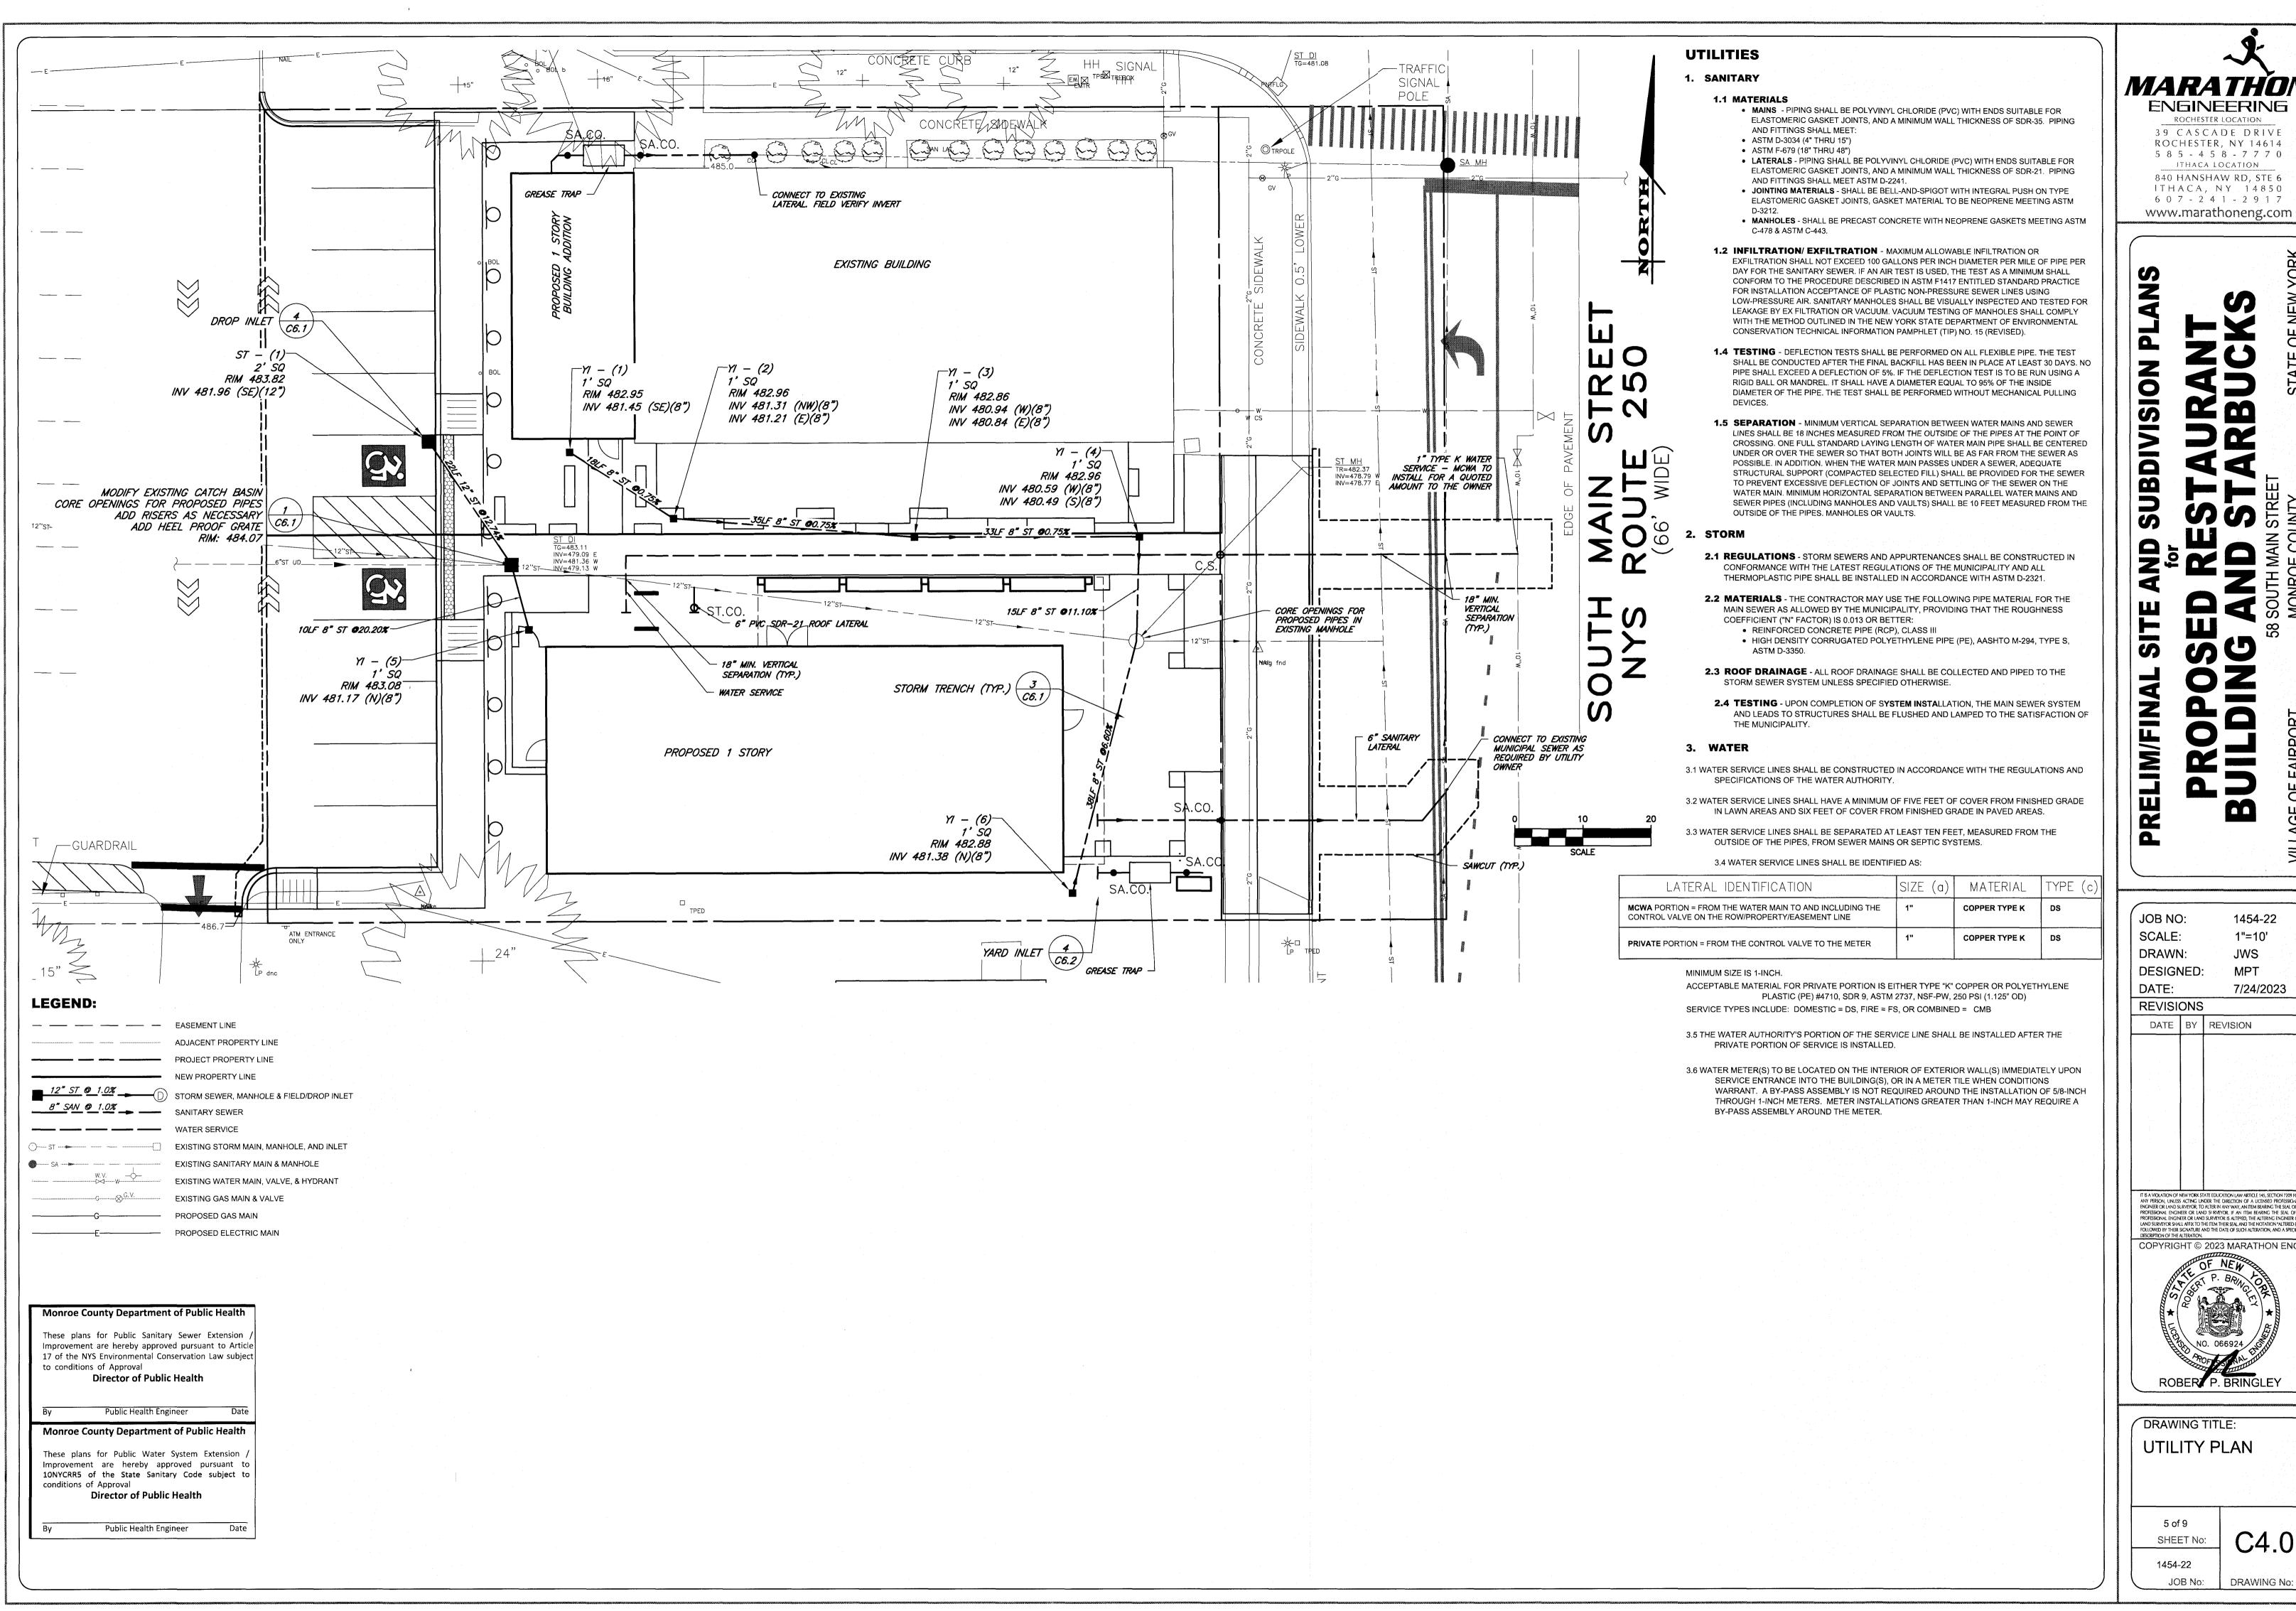


DRAWING TITLE:

4 of 9 SHEET No:

1454-22 JOB No: DRAWING No:

LAYOUT PLAN



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ITHACA, NY 14850 6 0 7 - 2 4 1 - 2 9 1 7

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1454-22 1"=10'

JWS MPT 7/24/2023


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DRAWING TITLE: UTILITY PLAN

SHEET No:

C4.0



- PREPARATION PRIOR TO START OF EARTHWORK OPERATIONS THE CONTRACTOR SHALL COMPLETE THE FOLLOWING APPLICABLE ITEMS AS DEFINED BY CONTRACT DOCUMENTS: • SITE DEMOLITION - REMOVAL AND DISPOSAL OFF-SITE IN A LEGAL MANNER; STRUCTURES,
 - CLEARING AND GRUBBING REMOVAL AND DISPOSAL OFF-SITE IN A LEGAL MANNER;
 - TOPSOIL STRIPPING STRIP AND STOCKPILE TOPSOIL FOR REUSE. EXCESS TOPSOIL MAY BE
 - REMOVED FROM SITE WITH APPROVAL BY OWNER AND MUNICIPALITY.
 - ESTIMATE COMPLETION OF A QUANTITY TAKEOFF TO DETERMINE THE VOLUME OF CUT, FILL,
 - AND TOPSOIL. COMPARE AND COORDINATE WITH INFORMATION PROVIDED BY THE DESIGN
 - GRADE TOLERANCES ESTABLISHING DESIGN SUBGRADE ELEVATIONS TO WITHIN ONE TENTH OF ONE FOOT (0.10') IN PAVEMENT AREAS (INCLUDING WALKS) AND TO WITHIN
 - THIRTY-THREE HUNDREDTHS OF ONE FOOT (0.33') FOR ALL REMAINING AREAS. • COMPACTION - ACHIEVING THE SPECIFIED MINIMUM COMPACTION VALUES FOR
 - CUTS ONCE EXCAVATIONS ARE SHAPED TO THE DESIGN GRADES THE AREAS SHALL BE PROTECTED TO ASSURE THAT THE INTEGRITY OF MATERIAL IS NOT COMPROMISED BY CONSTRUCTION VEHICLES AND/OR IMPROPER DRAINAGE. AREAS DETERMINED BY CONTRACTOR TO BE **NOT** SUITABLE FOR SUBGRADE PLACEMENT SHALL BE IMMEDIATELY REPORTED WHEN THE SUBGRADE IS ESTABLISHED TO OWNER'S REPRESENTATIVE. STABILIZATION MEASURES FOR CUT AREAS MAY BE CONSIDERED BY OWNER'S
- 3. TESTING THE FOLLOWING MAXIMUM DRY DENSITIES SHALL BE ACHIEVED AS MEASURED BY THE
 - 95% UNDER PAVEMENTS, WALKS, AND IN STRUCTURAL FILL AREAS

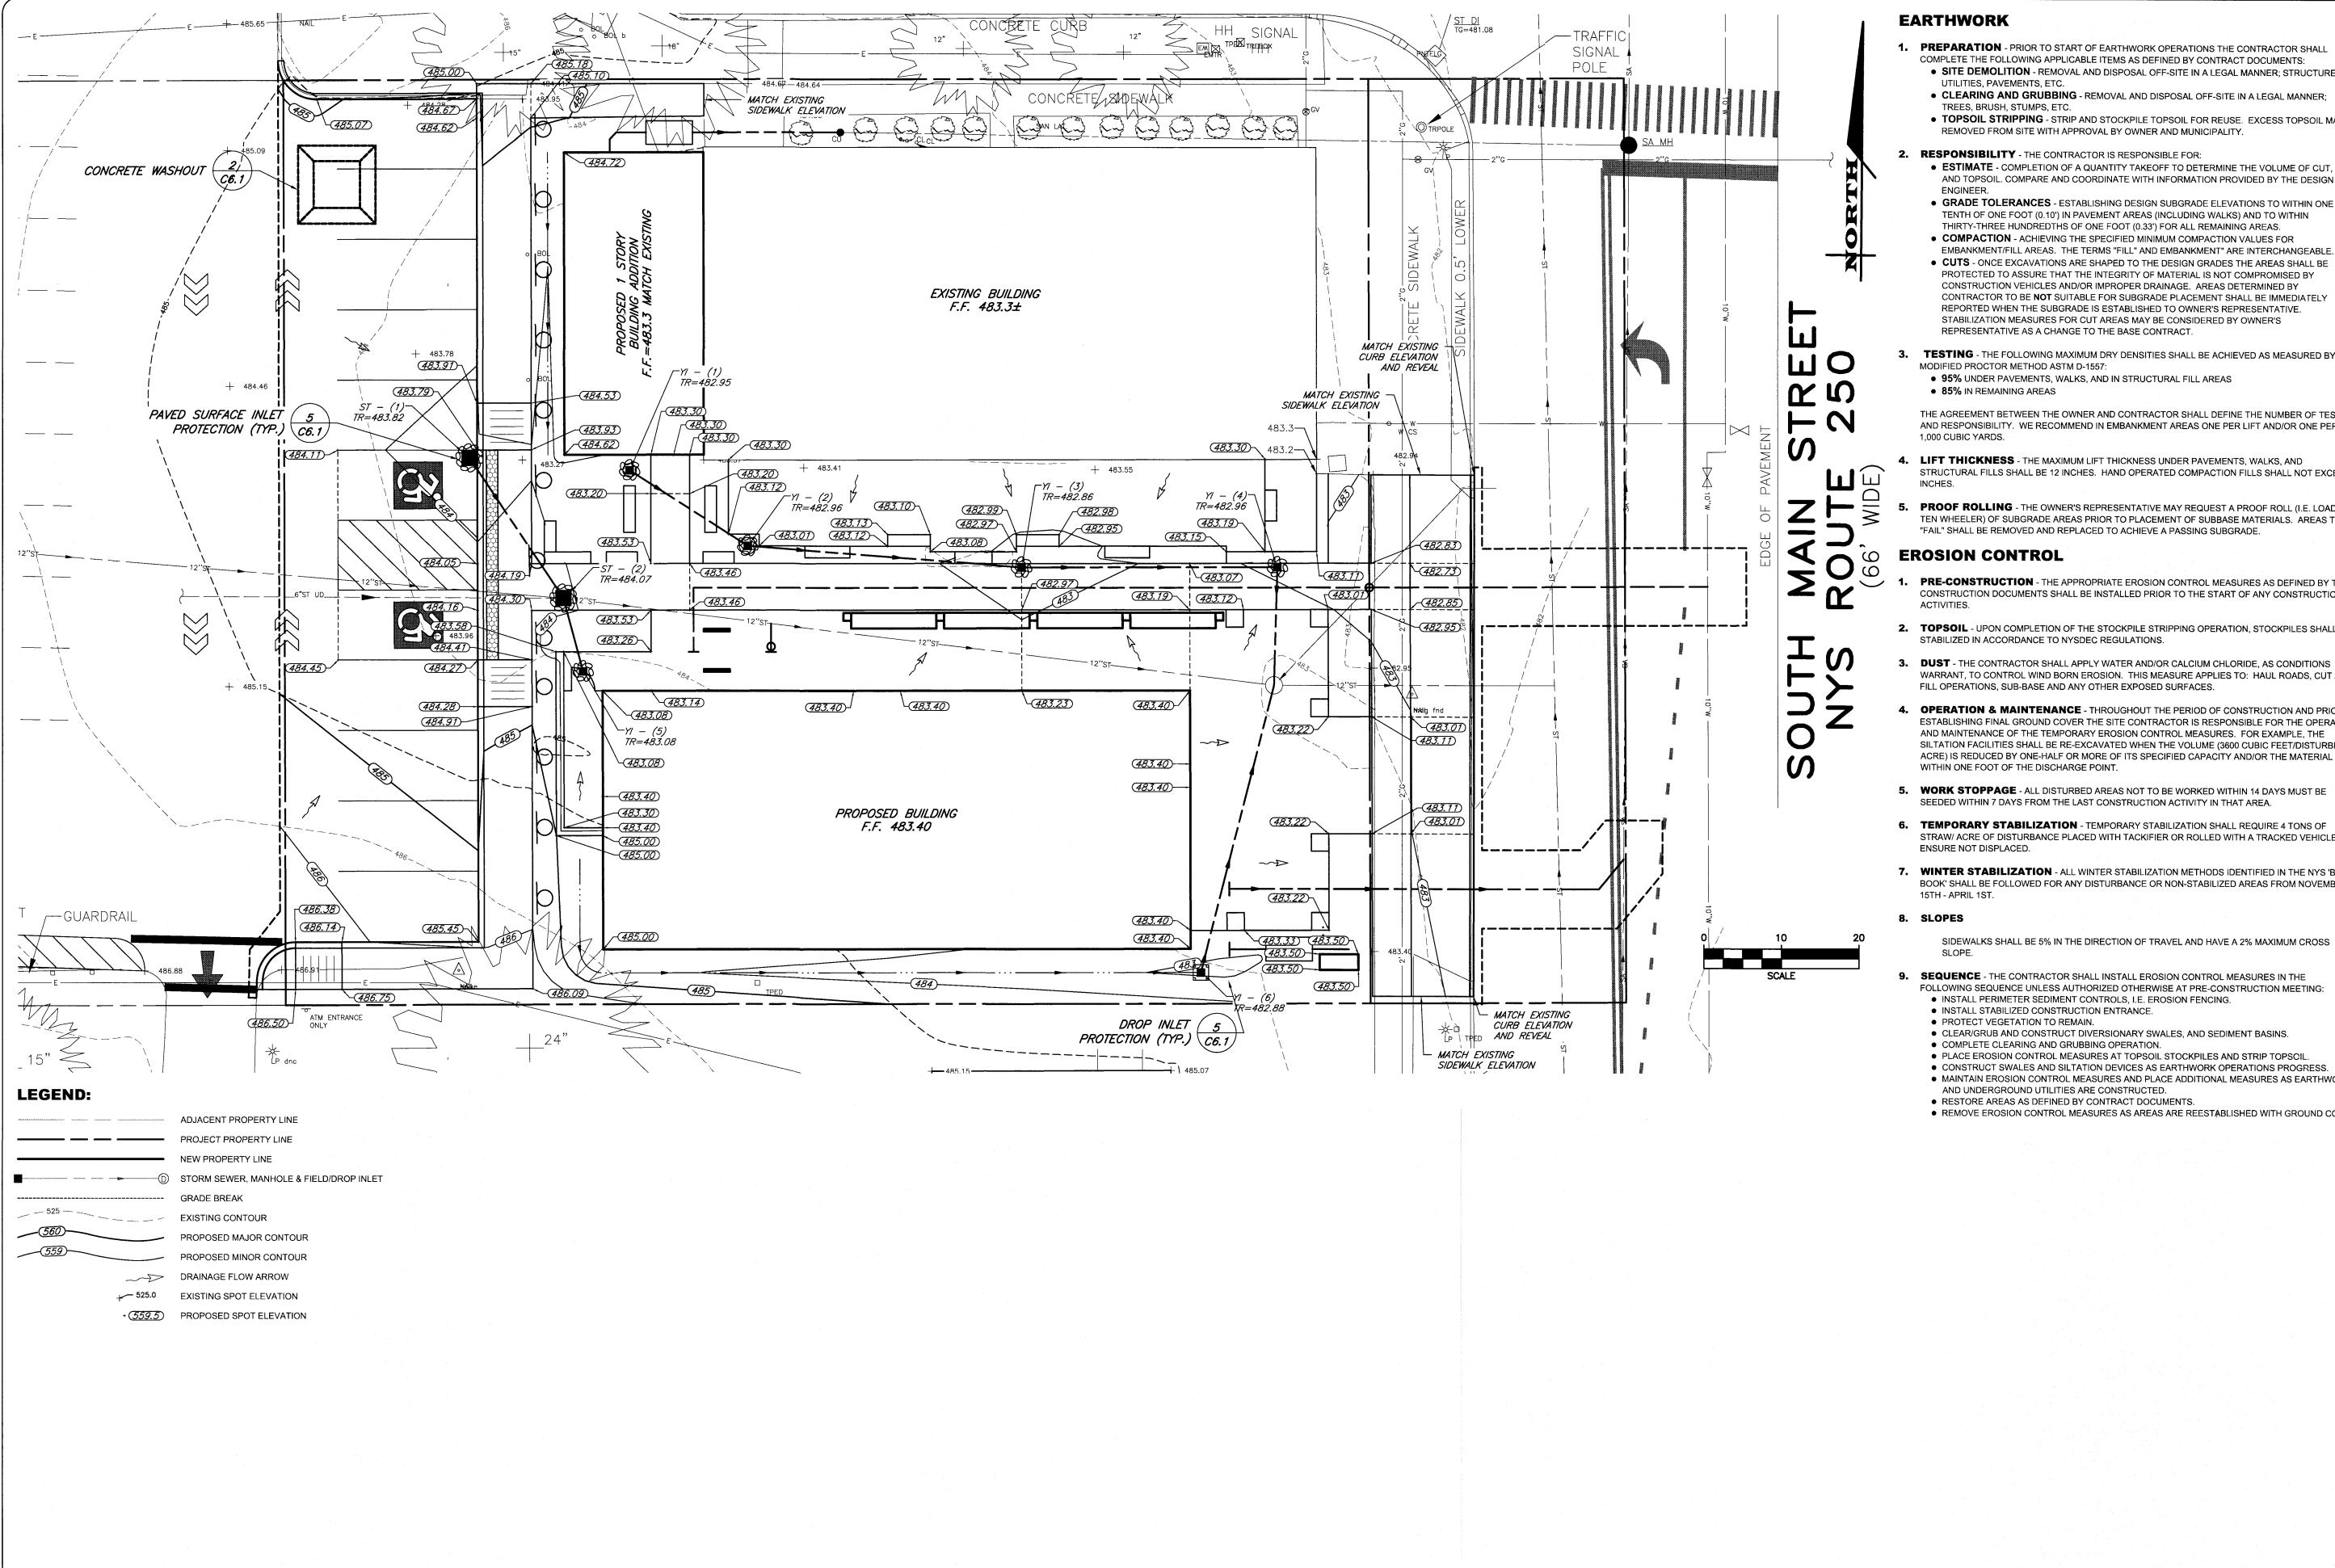THE AGREEMENT BETWEEN THE OWNER AND CONTRACTOR SHALL DEFINE THE NUMBER OF TESTS AND RESPONSIBILITY. WE RECOMMEND IN EMBANKMENT AREAS ONE PER LIFT AND/OR ONE PER

- STRUCTURAL FILLS SHALL BE 12 INCHES. HAND OPERATED COMPACTION FILLS SHALL NOT EXCEED 6
- PROOF ROLLING THE OWNER'S REPRESENTATIVE MAY REQUEST A PROOF ROLL (I.E. LOADED TEN WHEELER) OF SUBGRADE AREAS PRIOR TO PLACEMENT OF SUBBASE MATERIALS. AREAS THAT "FAIL" SHALL BE REMOVED AND REPLACED TO ACHIEVE A PASSING SUBGRADE.
- PRE-CONSTRUCTION THE APPROPRIATE EROSION CONTROL MEASURES AS DEFINED BY THE CONSTRUCTION DOCUMENTS SHALL BE INSTALLED PRIOR TO THE START OF ANY CONSTRUCTION
- 2. TOPSOIL UPON COMPLETION OF THE STOCKPILE STRIPPING OPERATION, STOCKPILES SHALL BE
- 3. **DUST** THE CONTRACTOR SHALL APPLY WATER AND/OR CALCIUM CHLORIDE, AS CONDITIONS WARRANT, TO CONTROL WIND BORN EROSION. THIS MEASURE APPLIES TO: HAUL ROADS, CUT AND
- **OPERATION & MAINTENANCE** THROUGHOUT THE PERIOD OF CONSTRUCTION AND PRIOR TO ESTABLISHING FINAL GROUND COVER THE SITE CONTRACTOR IS RESPONSIBLE FOR THE OPERATION AND MAINTENANCE OF THE TEMPORARY EROSION CONTROL MEASURES. FOR EXAMPLE, THE SILTATION FACILITIES SHALL BE RE-EXCAVATED WHEN THE VOLUME (3600 CUBIC FEET/DISTURBED ACRE) IS REDUCED BY ONE-HALF OR MORE OF ITS SPECIFIED CAPACITY AND/OR THE MATERIAL IS
- 5. WORK STOPPAGE ALL DISTURBED AREAS NOT TO BE WORKED WITHIN 14 DAYS MUST BE
- 6. TEMPORARY STABILIZATION TEMPORARY STABILIZATION SHALL REQUIRE 4 TONS OF STRAW/ ACRE OF DISTURBANCE PLACED WITH TACKIFIER OR ROLLED WITH A TRACKED VEHICLE TO
- 7. WINTER STABILIZATION ALL WINTER STABILIZATION METHODS IDENTIFIED IN THE NYS 'BLUE BOOK' SHALL BE FOLLOWED FOR ANY DISTURBANCE OR NON-STABILIZED AREAS FROM NOVEMBER

SIDEWALKS SHALL BE 5% IN THE DIRECTION OF TRAVEL AND HAVE A 2% MAXIMUM CROSS

- 9. SEQUENCE THE CONTRACTOR SHALL INSTALL EROSION CONTROL MEASURES IN THE

 - CLEAR/GRUB AND CONSTRUCT DIVERSIONARY SWALES, AND SEDIMENT BASINS.
- CONSTRUCT SWALES AND SILTATION DEVICES AS EARTHWORK OPERATIONS PROGRESS.
- MAINTAIN EROSION CONTROL MEASURES AND PLACE ADDITIONAL MEASURES AS EARTHWORK
- RESTORE AREAS AS DEFINED BY CONTRACT DOCUMENTS.
- REMOVE EROSION CONTROL MEASURES AS AREAS ARE REESTABLISHED WITH GROUND COVER.

ENGINEERING

ROCHESTER LOCATION

39 CASCADE DRIVE

ROCHESTER, NY 14614 5 8 5 - 4 5 8 - 7 7 7 0 ITHACA LOCATION 840 HANSHAW RD, STE 6 ITHACA, NY 14850

607-241-2917

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JOB NO: 1454-22 SCALE: 1"=10' DRAWN: JWS

DESIGNED: MPT 7/24/2023

DATE:

REVISIONS DATE BY REVISION


IT IS A MOLATION OF NEW YORK STATE EDUCATION LAW ARTICLE 145, SECTION 7209 FOR ANY PERSON, UNLESS ACTING UNDER THE DIRECTION OF A LICENSED PROFESSIONAL ENGINEER OR LAND SURVEYOR, TO ALTER IN ANY WAY, AN ITEM BEARING THE SEAL OF A PROFESSIONAL ENGINEER OR LAND SURVEYOR IF AN ITEM BEARING THE SEAL OF A PROFESSIONAL ENGINEER OR LAND SURVEYOR IS ALTERED, THE ALTERING ENGINEER OR LAND SURVEYOR IS ALTERED, THE ALTERING ENGINEER OR LAND SURVEYOR SHALL AFIX TO THE ITEM THEIR SEAL AND THE NOTATION "ALTERED BY" FOLLOWED BY THEIR SIGNATURE AND THE DATE OF SUCH ALTERATION, AND A SPECIFIC DESCRIPTION OF THE ALTERATION.





DRAWING TITLE:

GRADING AND EROSION CONTROL PLAN


6 of 9 SHEET No: 1454-22 JOB No:

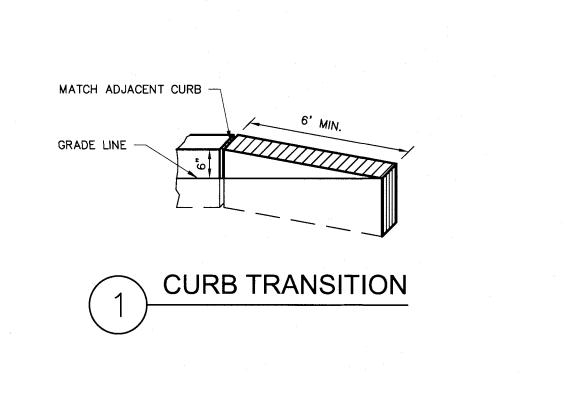

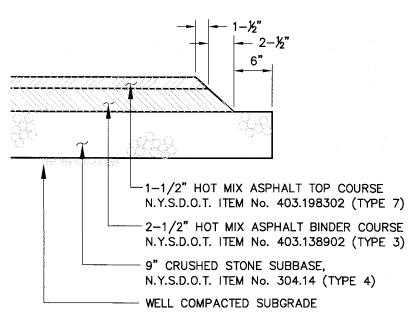


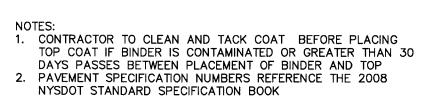


PAVEMENT SECTION

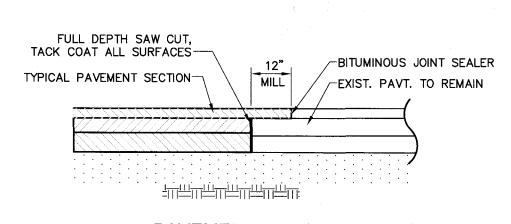




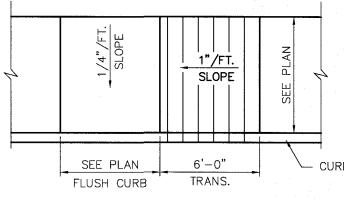


1. SURFACE TEXTURE OF RAMP SHALL BE COARSE BROOM FINISHED TRANSVERSE TO RAMP.

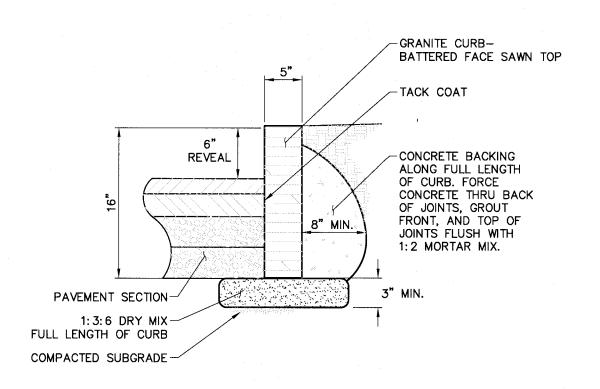




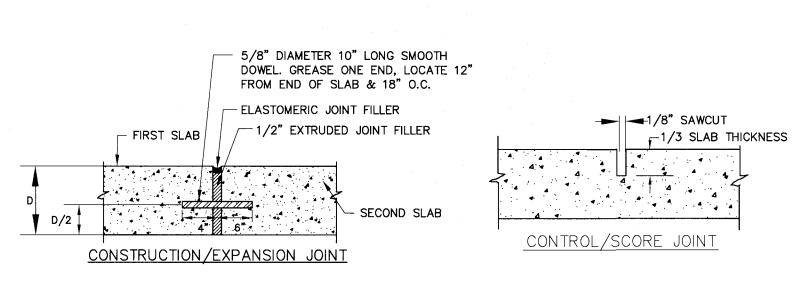


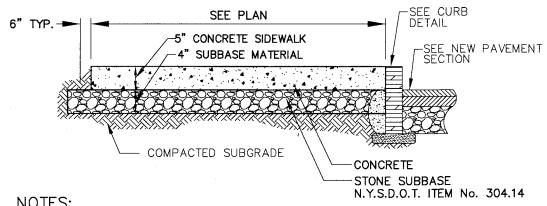


- 1. CONCRETE SHALL BE 4000 PSI AIR-ENTRAINED MIX. 2. CONCRETE SURFACE SHALL RECEIVE A BROOM FINISH (IF NOT SPECIFIED AS EXPOSED AGGREGATE CONCRETE) AND TWO COATS OF A MEMBRANE FORMING SEALER AT RATES SPECIFIED BY PRODUCT MANUFACTURER.
- 3. EXPANSION JOINTS SHALL BE PROVIDED AT FIXED STRUCTURES AND AT LEAST EVERY 50' ALONG THE SIDEWALK.
 4. CONSTRUCTION JOINTS WITH DOWELS SHALL BE PROVIDED AT SUBSEQUENT
- POURS AND CONCRETE CURBS 5. CONTROL JOINTS SHALL BE LOCATED AS SHOWN ON PLAN AND IN ACCORDANCE WITH ACI 330-R92. THESE JOINTS SHALL BE COMPLETED WITHIN 24 HOURS OF CONCRETE PLACEMENT.
- 6. SCORE PATTERN SCORING PATTERN SHALL BE 5' X 5' SQUARE, MAY VARY IN CERTAIN AREAS—COORDNIATE WITH OWNERS ONSITE REP PRIOR TO SCORING 7. SIDEWALKS SHALL HAVE A MINIMUM 0.5% AND MAXIMUM 2.0% CROSS SLOPE TO
- PROVIDE POSITIVE DRAINAGE. CROSS SLOPE SHALL PROVIDE POSITIVE DRAINAGE AWAY FROM BUILDINGS AND ENTRANCES. 8. 'SNAP-CAP' OR EQUAL SHALL BE USED FOR SHAPING EXPANSION JOINTS.



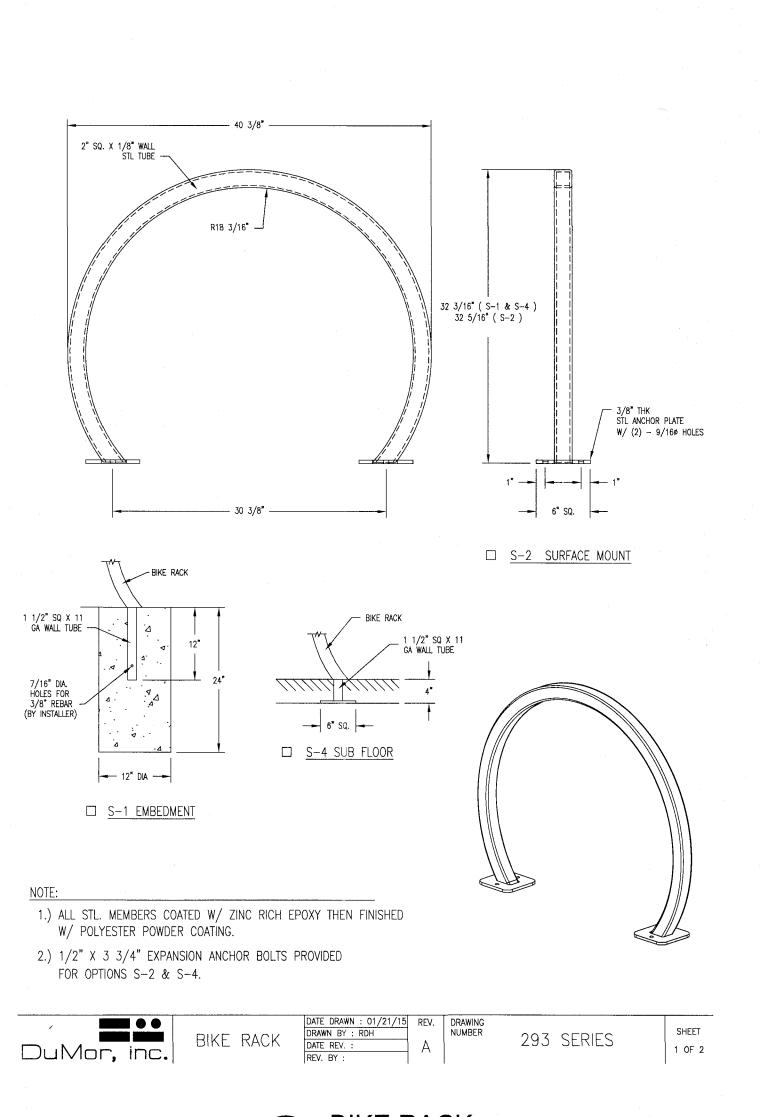

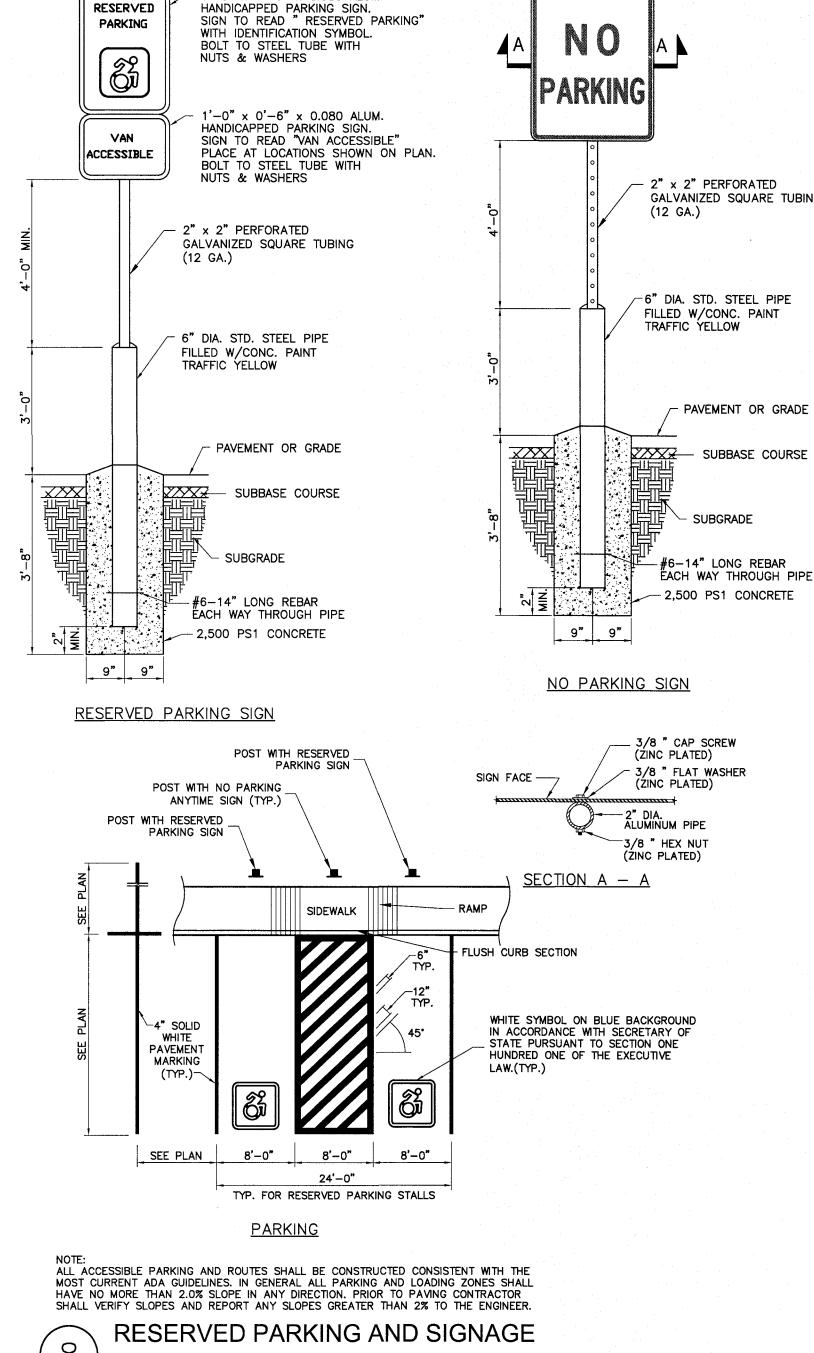

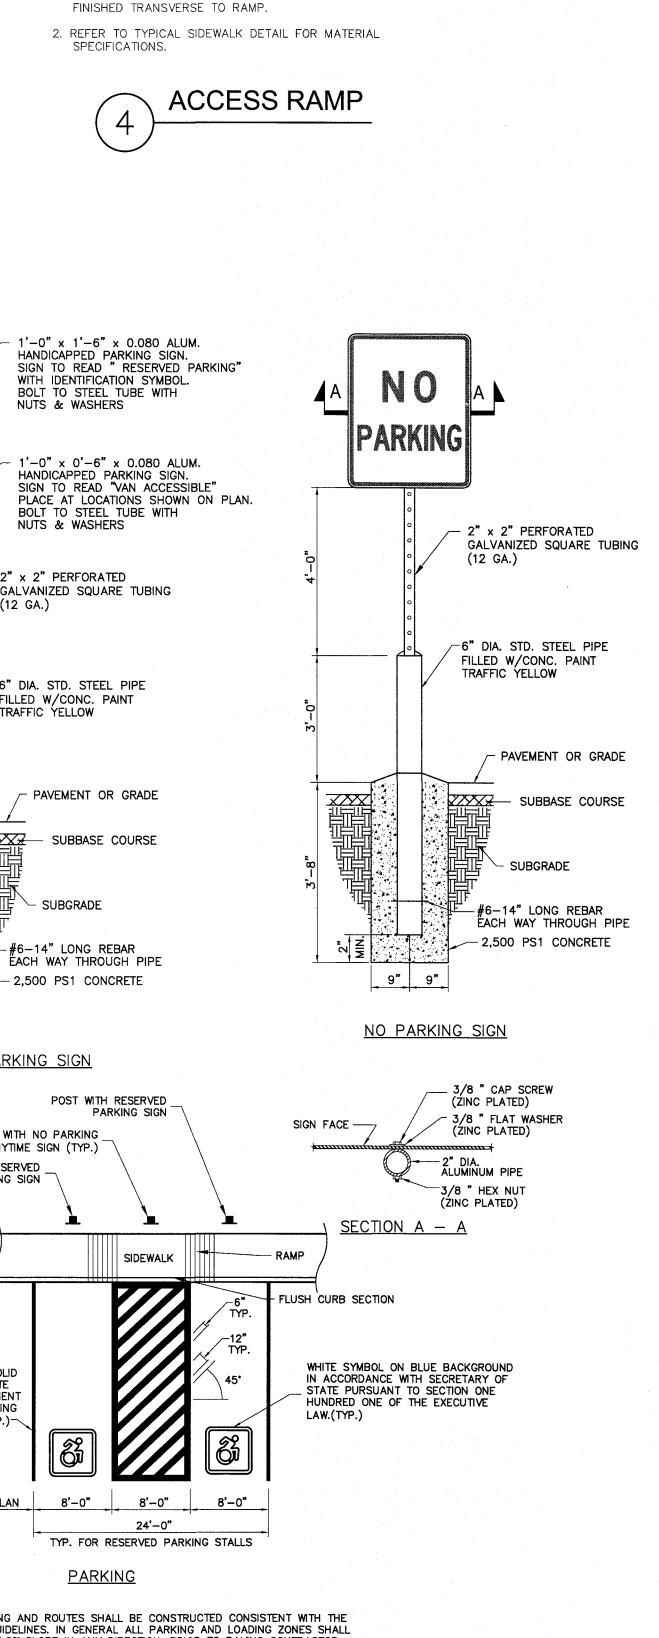

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ITHACA, NY 14850

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SUBDIVISION

SITE

9

JOB NO:

SCALE:

DRAWN:

DATE:

DESIGNED:

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DATE BY REVISION

1454-22

07/24/2023


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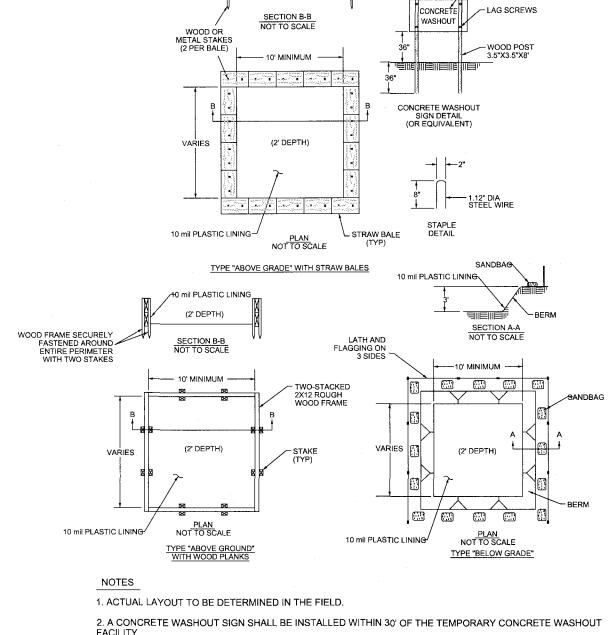
MPT

DRAWING TITLE: CONSTRUCTION **DETAILS**

> 7 of 9 SHEET No: 1454-22 JOB No:



STORM STRUCTURE

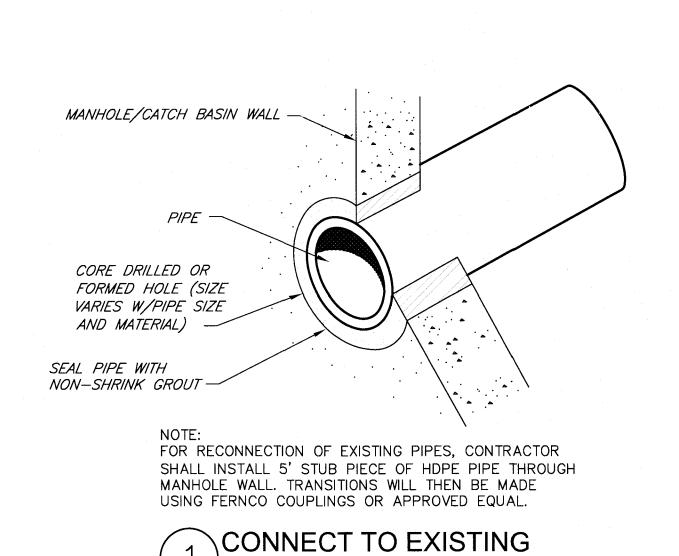

_ STRAW BALE BINDER WIRE -


_10 mil PLASTIC LINING

3. MATERIALS USED TO CONSTRUCT TEMPORARY CONCRETE WASHOUT FACILITIES SHALL BE REMOVED FROM THE SITE OF THE WORK AND DISPOSED OF OR RECYCLED. 4. HOLES, DEPRESSIONS OR OTHER GROUND DISTURBANCE CAUSED BY THE REMOVAL OF THE TEMPORARY CONCRETE WASHOUT FACILITIES SHALL BE BACKFILLED, REPAIRED, AND STABILIZED TO PREVENT EROSION.

CONCRETE WASHOUT AREA

SEE "TYPICAL PAVEMENT SECTION" BACKFILL BACKFILL WITH R.O.B. GRAVEL IN 12" LIFTS SLOPED EXCAVATION AT-CONTRACTORS OPTION PROVIDE SHEETING AS
NECESSARY TO MEET OSHA
STANDARDS & REQUIREMENTS. UNIFORM MIXTURE OF NO. 1 AND NO. 2 CRUSHED STONE

STORM TRENCH

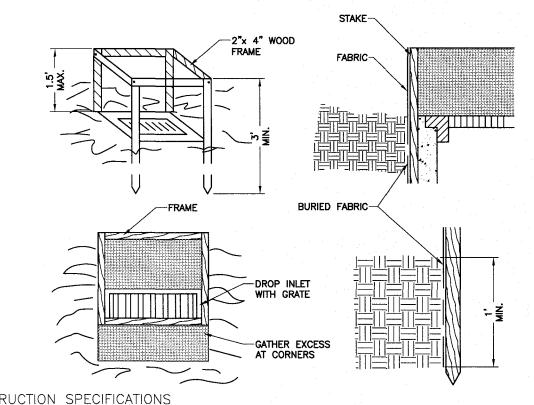


CONSTRUCTION SPECIFICATIONS


. FILTER FABRIC SHALL HAVE AN EOS OF 40—85. BURLAP MAY BE USED FOR SHORT TERM APPLICATIONS. . CUT FABRIC FROM A CONTINUOUS ROLL TO ELIMINATE JOINTS. IF JOINTS ARE NEEDED THEY WILL BE OVERLAPPED TO THE NEXT STAKE. 3. STAKE MATERIALS WILL BE STANDARD 2" x 4" WOOD OR EQUIVALENT METAL WITH A MINIMUM LENGTH OF 3 FEET.

4. SPACE STAKES EVENLY AROUND INLET 3 FEET APART AND DRIVE A MINIMUM OF 18 INCHES DEEP. SPANS GREATER THAN 3 FEET MAY BE BRIDGED WITH THE USE OF WIRE MESH BEHIND THE FILTER FABRIC FOR SUPPORT.

5. FABRIC SHALL BE EMBEDDED 1 FOOT MINIMUM BELOW GROUND AND BACKFILLED. IT SHALL BE SECURELY FASTENED TO THE STAKES AND FRAME. 6. A 2" x 4" WOOD FRAME SHALL BE COMPLETED AROUND THE CREST OF THE FABRIC FOR OVER LOW STABILITY.


> DROP INLET PROTECTION SCALE: N.T.S

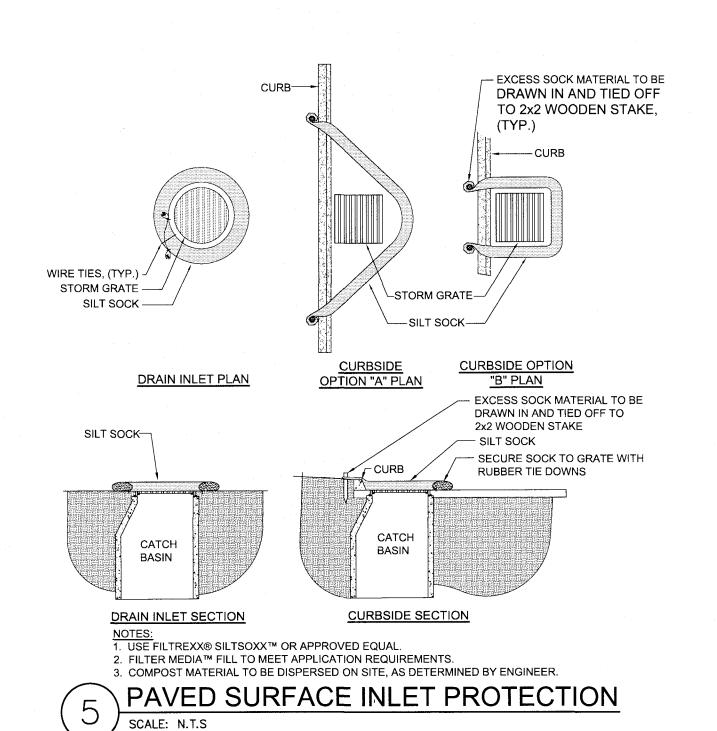

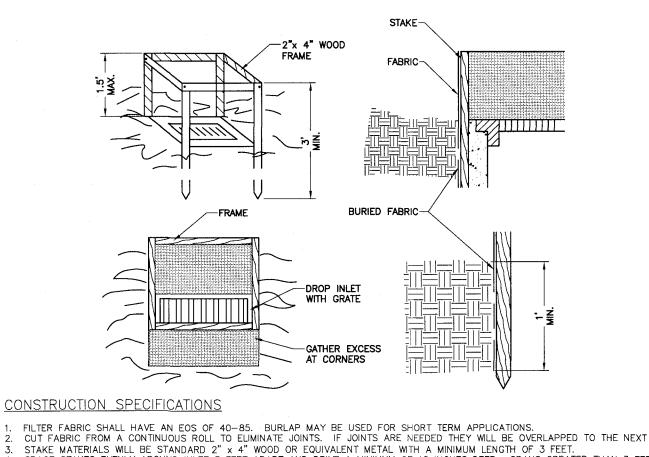

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> DROP INLET PROTECTION SCALE: N.T.S



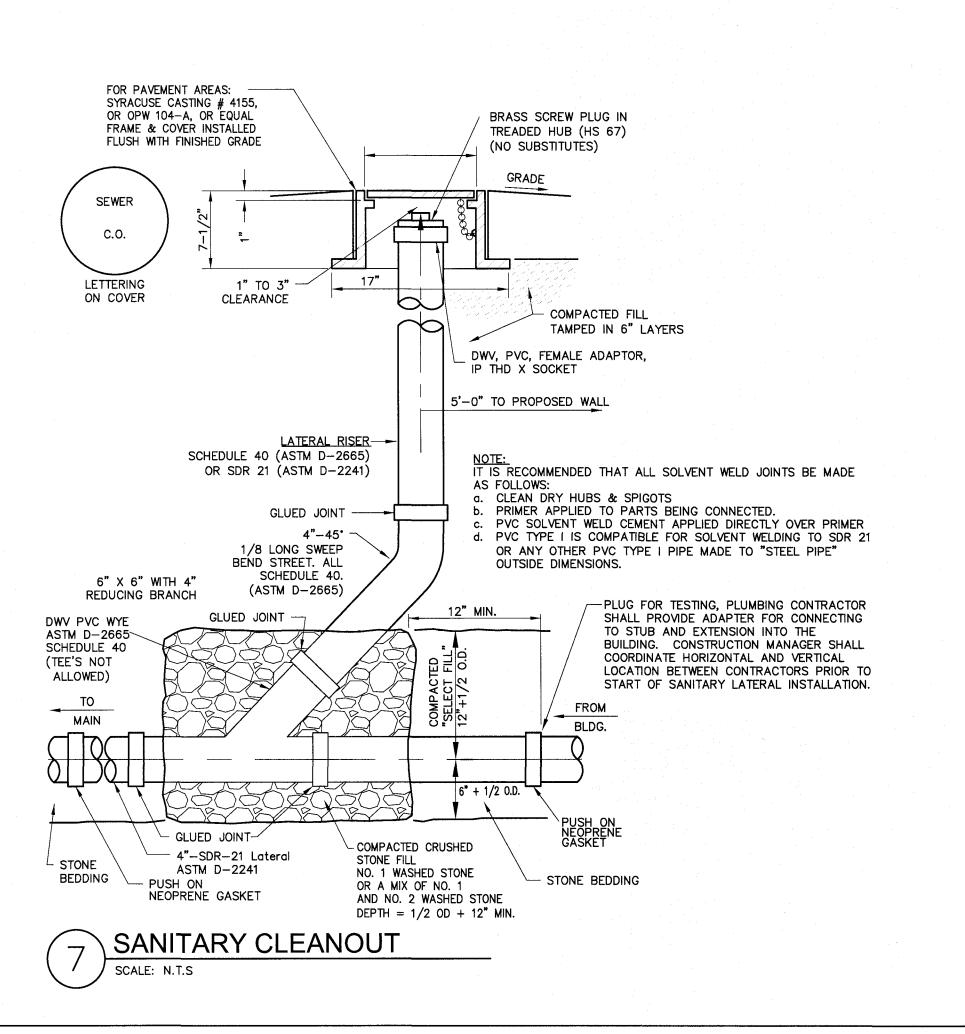

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JOB NO: 1454-22 SCALE: NTS DRAWN: DESIGNED: MPT


DATE: 7/24/2023 REVISIONS DATE BY REVISION


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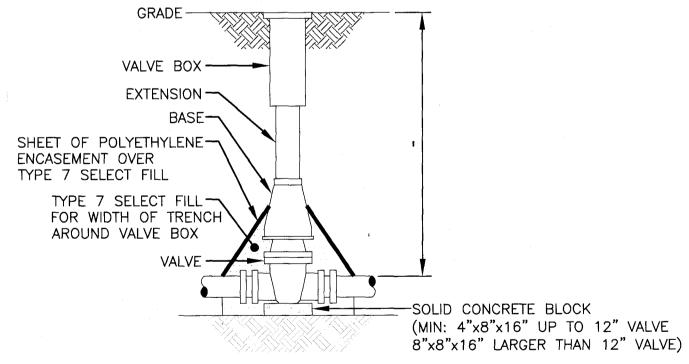
DRAWING TITLE: CONSTRUCTION DETAILS

> 8 of 9 SHEET No: 1454-22



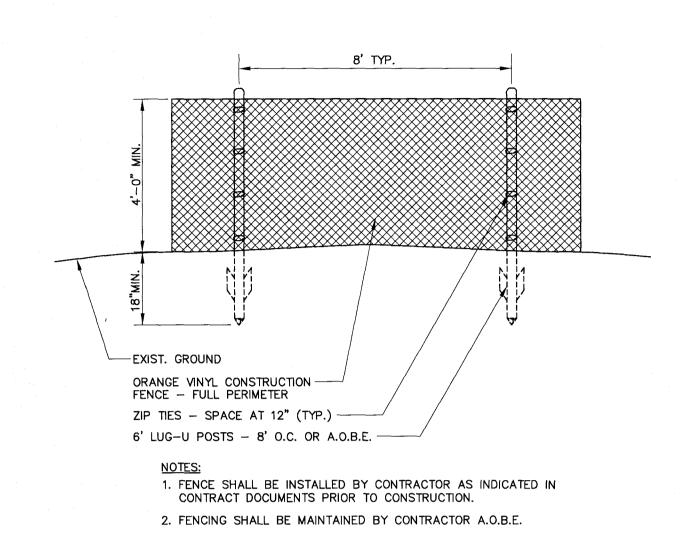


CONSTRUCTION FENCE

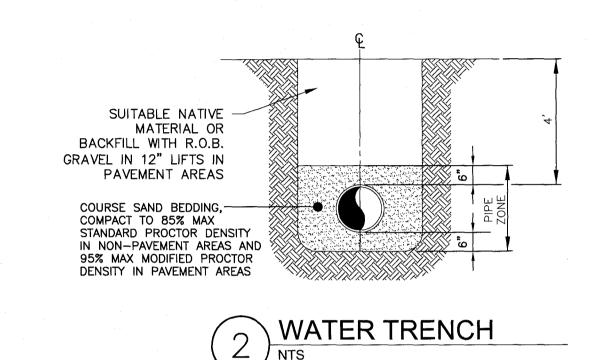


NOTES:

- 1. VALVE BOX SHALL BE CENTERED ON VALVE AND SET ON COMPACTED BACKFILL.
- 2. VALVE SHALL NOT SUPPORT VALVE BOX.
- 3. ALL VALVES SHALL BE OPEN LEFT EXCEPT: TOWN OF WEBSTER - VALVES 12" AND SMALLER SHALL OPEN RIGHT. TOWN OF HENRIETTA - SHALL OPEN RIGHT



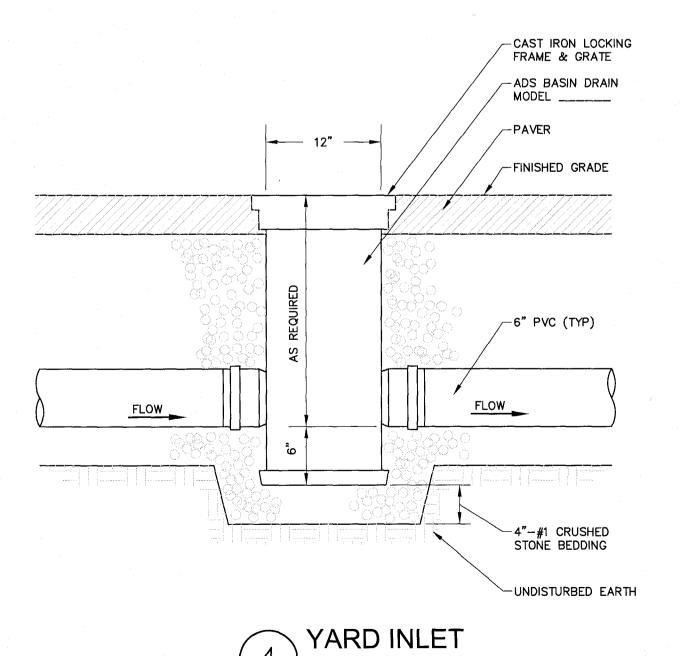

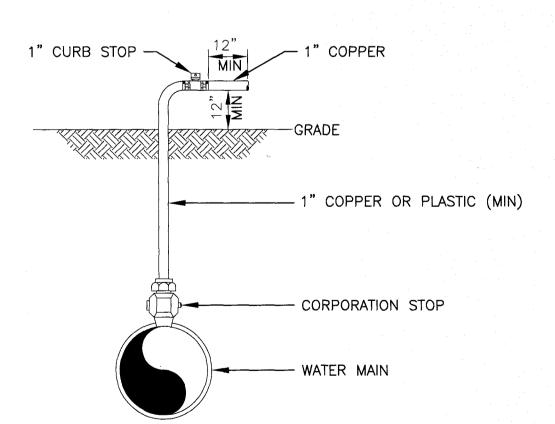

NOTE: IN THE PRESENCE OF A WATER AUTHORITY REPRESENTATIVE REMOVE ALL CORPORATIONS ASSOCIATED WITH TEMPORARY DISINFECTION/SAMPLE TAPS AND REPLACE WITH THREADED BRASS PLUGS.

DISINFECTION/BLOW-OFF/SAMPLING TAP (TEMPORARY) NOT TO SCALE



39 CASCADE DRIVE ROCHESTER, NY 14614 5 8 5 - 4 5 8 - 7 7 7 0 ITHACA LOCATION 840 HANSHAW RD, STE 6 ITHACA, NY 14850 6 0 7 - 2 4 1 - 2 9 1 7

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JOB NO: 1454-22 SCALE: DRAWN: JWS DESIGNED: MPT DATE: 7/24/2023 REVISIONS DATE BY REVISION IT IS A VIOLATION OF NEW YORK STATE EDUCATION LAW ARTICLE 145, SECTION 7209 FOR ANY PRESON, UNLESS ACTING UNDER THE DIRECTION OF A LICENSED PROFESSIONAL ENGINEER OR LAND SURVEYOR, TO ALTER IN ANY WAY, AN ITEM BEARING THE SEAL OF A PROFESSIONAL ENGINEER OR LAND SURVEYOR. IF AN ITEM BEARING THE SEAL OF A PROFESSIONAL ENGINEER OR LAND SURVEYOR IS ALTERED, THE ALTERNO ENGINEER OR LAND SURVEYOR SHALL FRITT OT THE ITEM THEIR SEAL AND THE NOTATION ALTERED BY FOLLOWED BY THEIR SIGNATURE AND THE DATE OF SUCH ALTERATION, AND A SPECIFIC DESCRIPTION OF THE ALTERATION. COPYRIGHT © 2023 MARATHON ENG.

DRAWING TITLE: CONSTRUCTION **DETAILS**

SHEET No:

1454-22 JOB No: DRAWING No:

ROBERT P. BRINGLEY







SCALE: 3/16"=1'-0"

CHANNEL LETTER SIGNAGE LIGHT FIXTURES-METAL COPING & CORNICE T.O. COPING +22'-3" STARBUCKS BRICK SOLDIER COURSE ROOF HEIGHT +16'-8" - CANOPY BRICK VENEER CANOPY -BEYOND PROJECTED BRICK ACCENTS CANOPY COLUMN BEYOND FINISH FLOOR DELIVERY DOOR -LIGHT FIXTURE

SOUTH ELEVATION SCALE: 3/16"=1'-0"

WEST ELEVATION

SCALE: 3/16"=1'-0"

7/24/2

STARBUCKS EXTERIOR

ELEVATIONS


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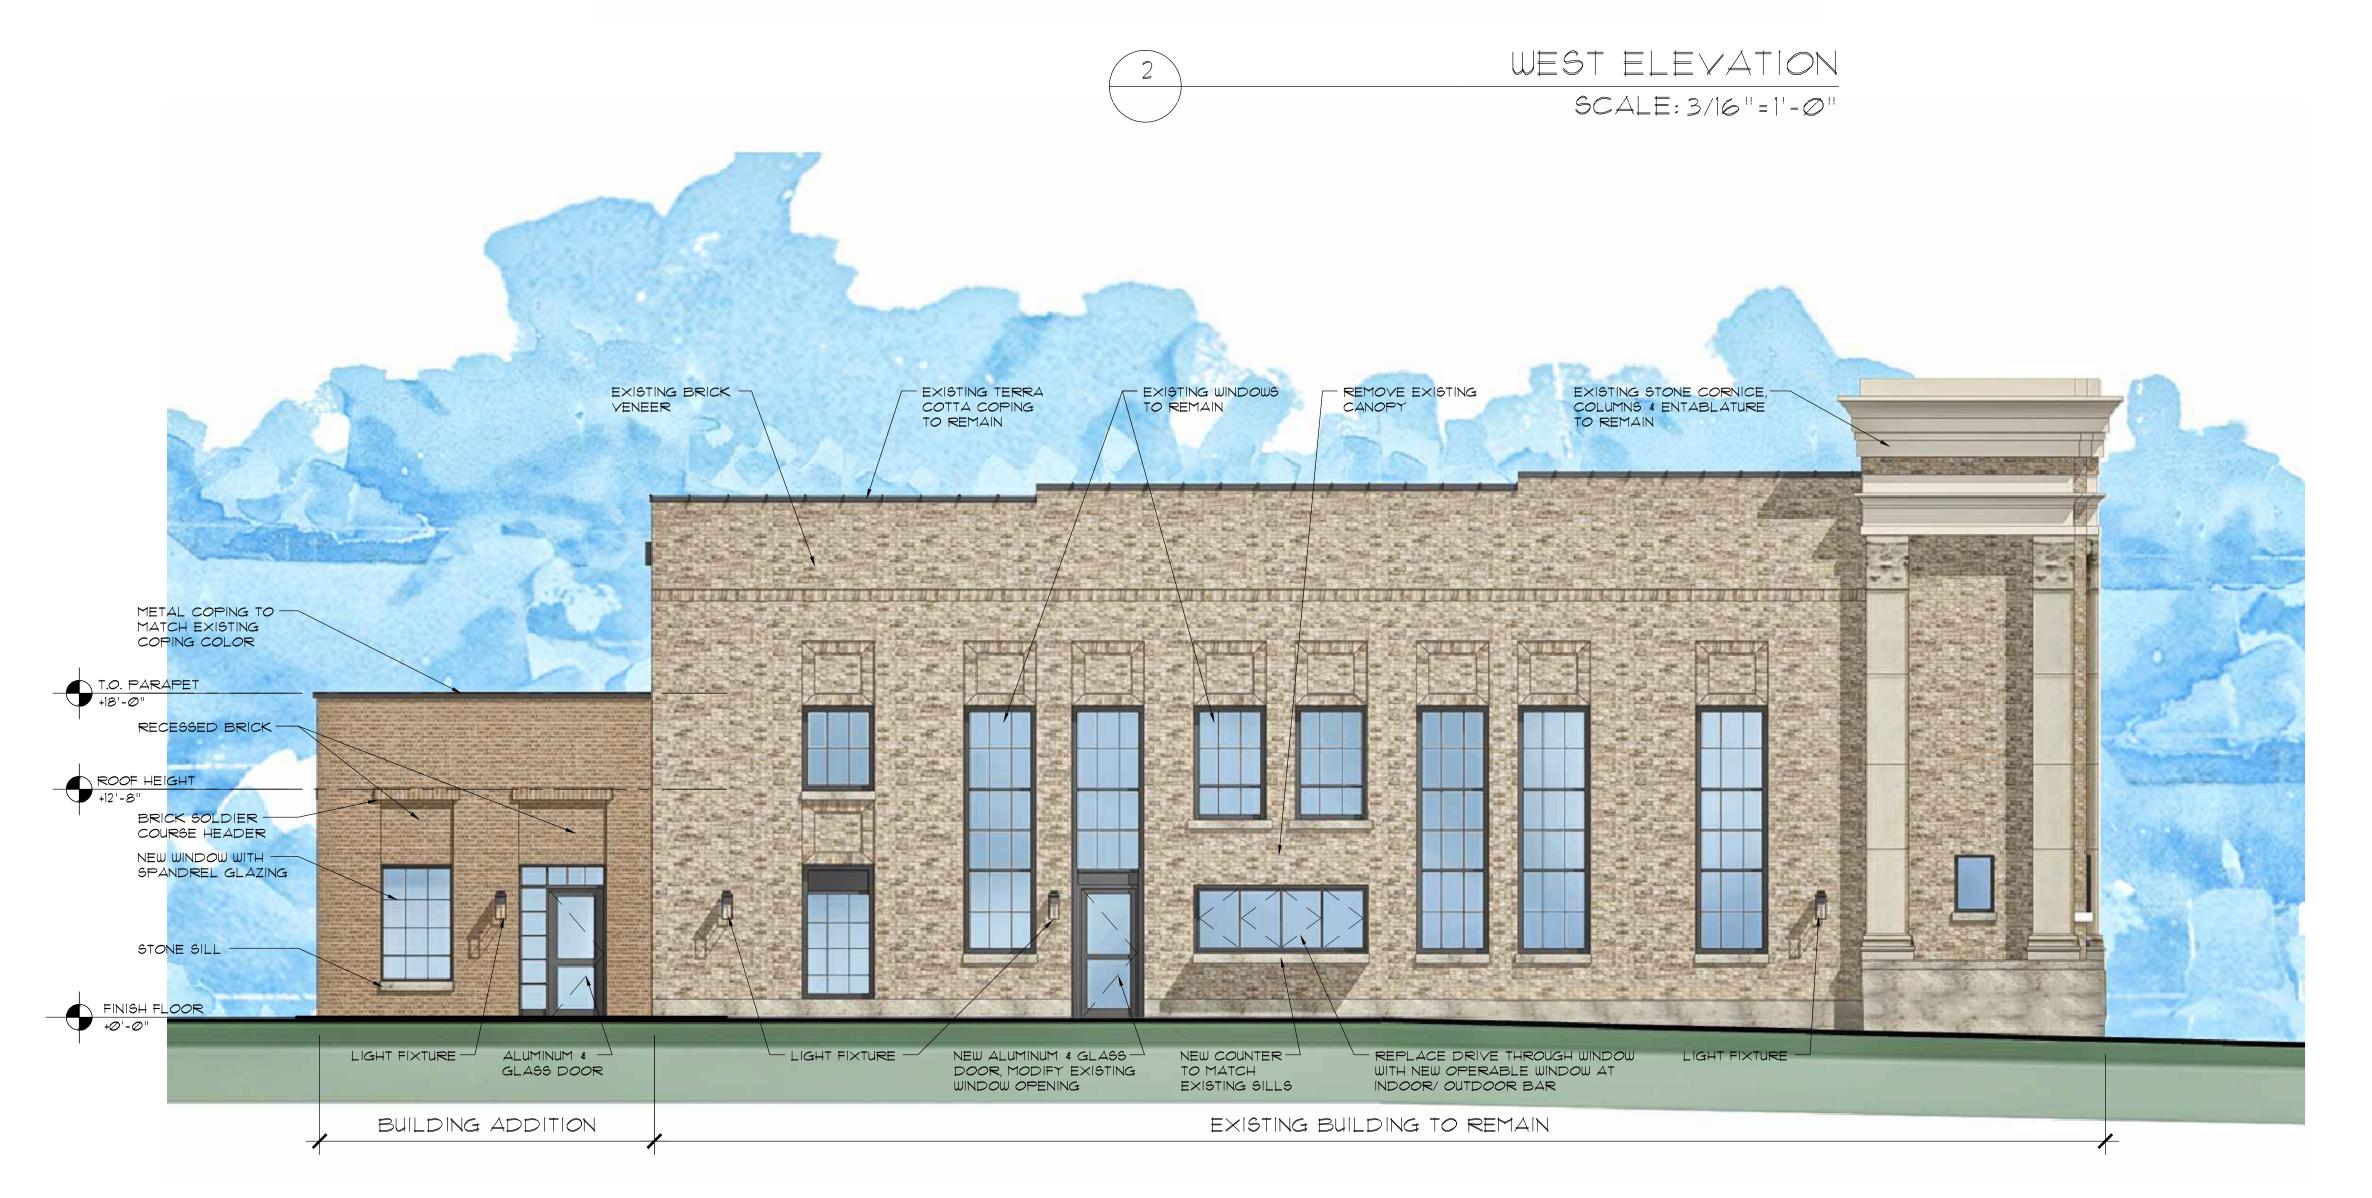
PROJECT NO: 22-166

SCALE: 3/16"=1'-0"







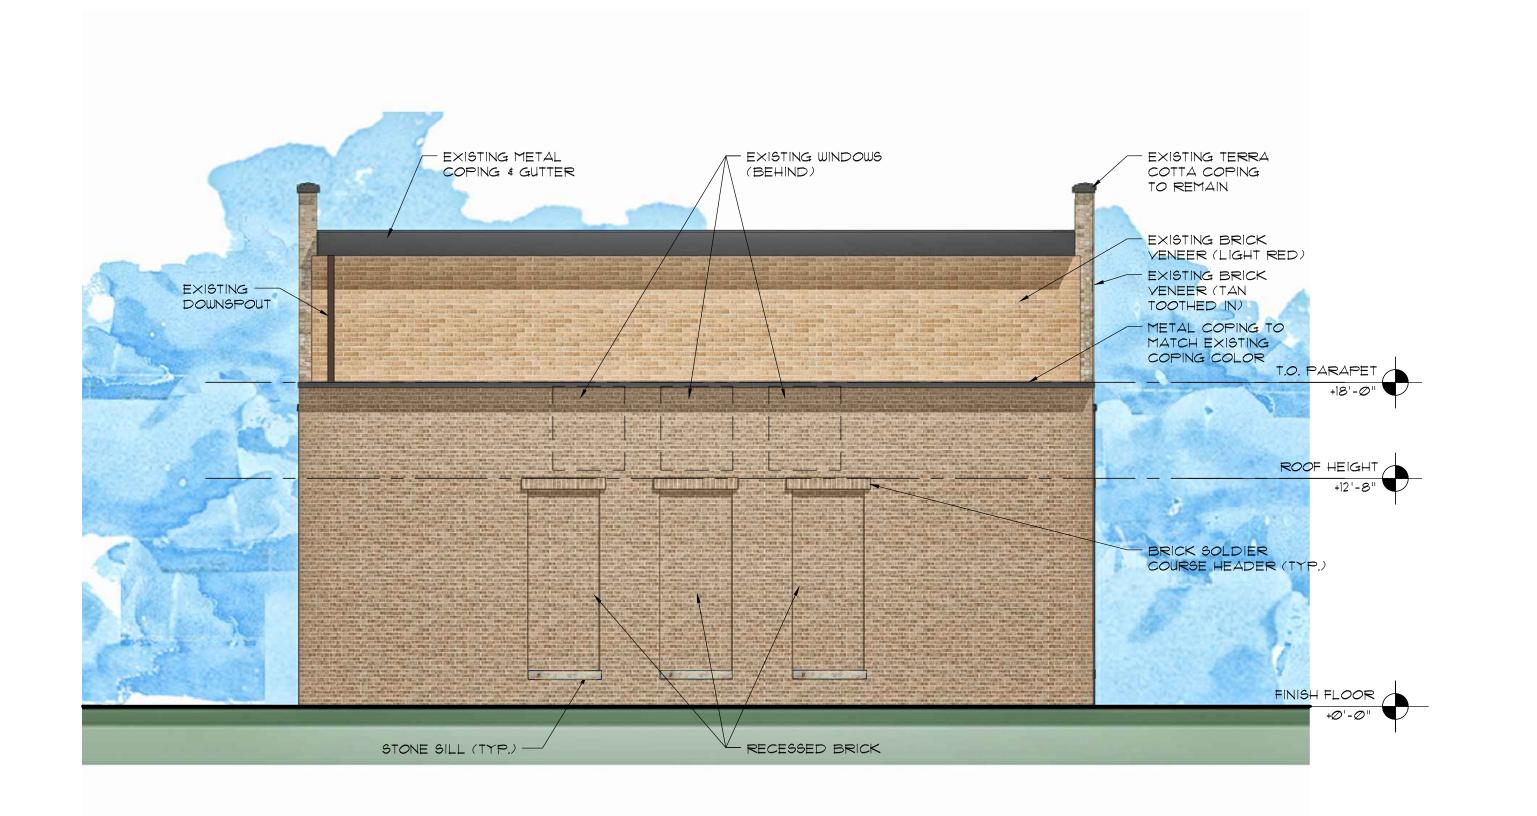

SOUTH ELEVATION

SCALE: 3/16"=1'-0"

HANLON ARCHITEC

INGRASSIA STARBUCKS SHELL

>

DATE: 7/24/23 EXISTING BANK

EXTERIOR
ELEVATIONS
DRAWING TITLE:

SHEET NO:

PROJECT NO: 22-166



INGRASSIA STARBUCKS SHELL

MAIN STREET ELEVATION

PRELIMINARY SIGNAGE

DRAWING TITLE:


SHEET NO:

PROJECT NO: 22-166

MAIN STREET ELEVATION SCALE: 1/8"=1'-0"

GENERAL NOTES:

- 1. THE CONTRACTOR SHALL FIELD VERIFY ALL AREAS WITHIN SCOPE OF WORK PRIOR TO START OF LANDSCAPE CONSTRUCTION. CONTACT THE LANDSCAPE ARCHITECT, THE OWNER, OR OWNER'S REPRESENTATIVE IMMEDIATELY TO REVIEW AND APPROVE ANY FIELD ISSUES DURING CONSTRUCTION.
- 2. THE CONTRACTOR SHALL BE RESPONSIBLE FOR ALL MATERIAL AND CONSTRUCTION QUALITY ASSURANCES AND WARRANTIES.
- 3. THE CONTRACTOR IS RESPONSIBLE FOR CONFIRMING THE LOCATION OF ALL EXISTING UNDERGROUND UTILITIES. ANY DAMAGE OCCURRING TO UTILITIES OR PROPERTY DURING EXCAVATION AND CONSTRUCTION WILL BE REPAIRED AT CONTRACTOR'S EXPENSE.
- 4. THE CONTRACTOR WILL SUBMIT PRODUCT DATA AND SHOP DRAWINGS TO LANDSCAPE ARCHITECT FOR APPROVAL PRIOR TO INSTALLATION.
- 5. THE CONTRACTOR SHALL BE RESPONSIBLE FOR OBTAINING DEMOLITION PERMITS FROM THE MUNICIPALITY AS NECESSARY. TO ALSO INCLUDE ANY NECESSARY PERMITTING FOR TRAFFIC REDIRECTION AND DISRUPTION.
- 6. THE CONTRACTOR SHALL MAINTAIN SAFE, CLEARLY MARKED PEDESTRIAN AND VEHICULAR ACCESS TO ALL ADJACENT PROPERTIES THROUGHOUT THE CONSTRUCTION PROCESS.

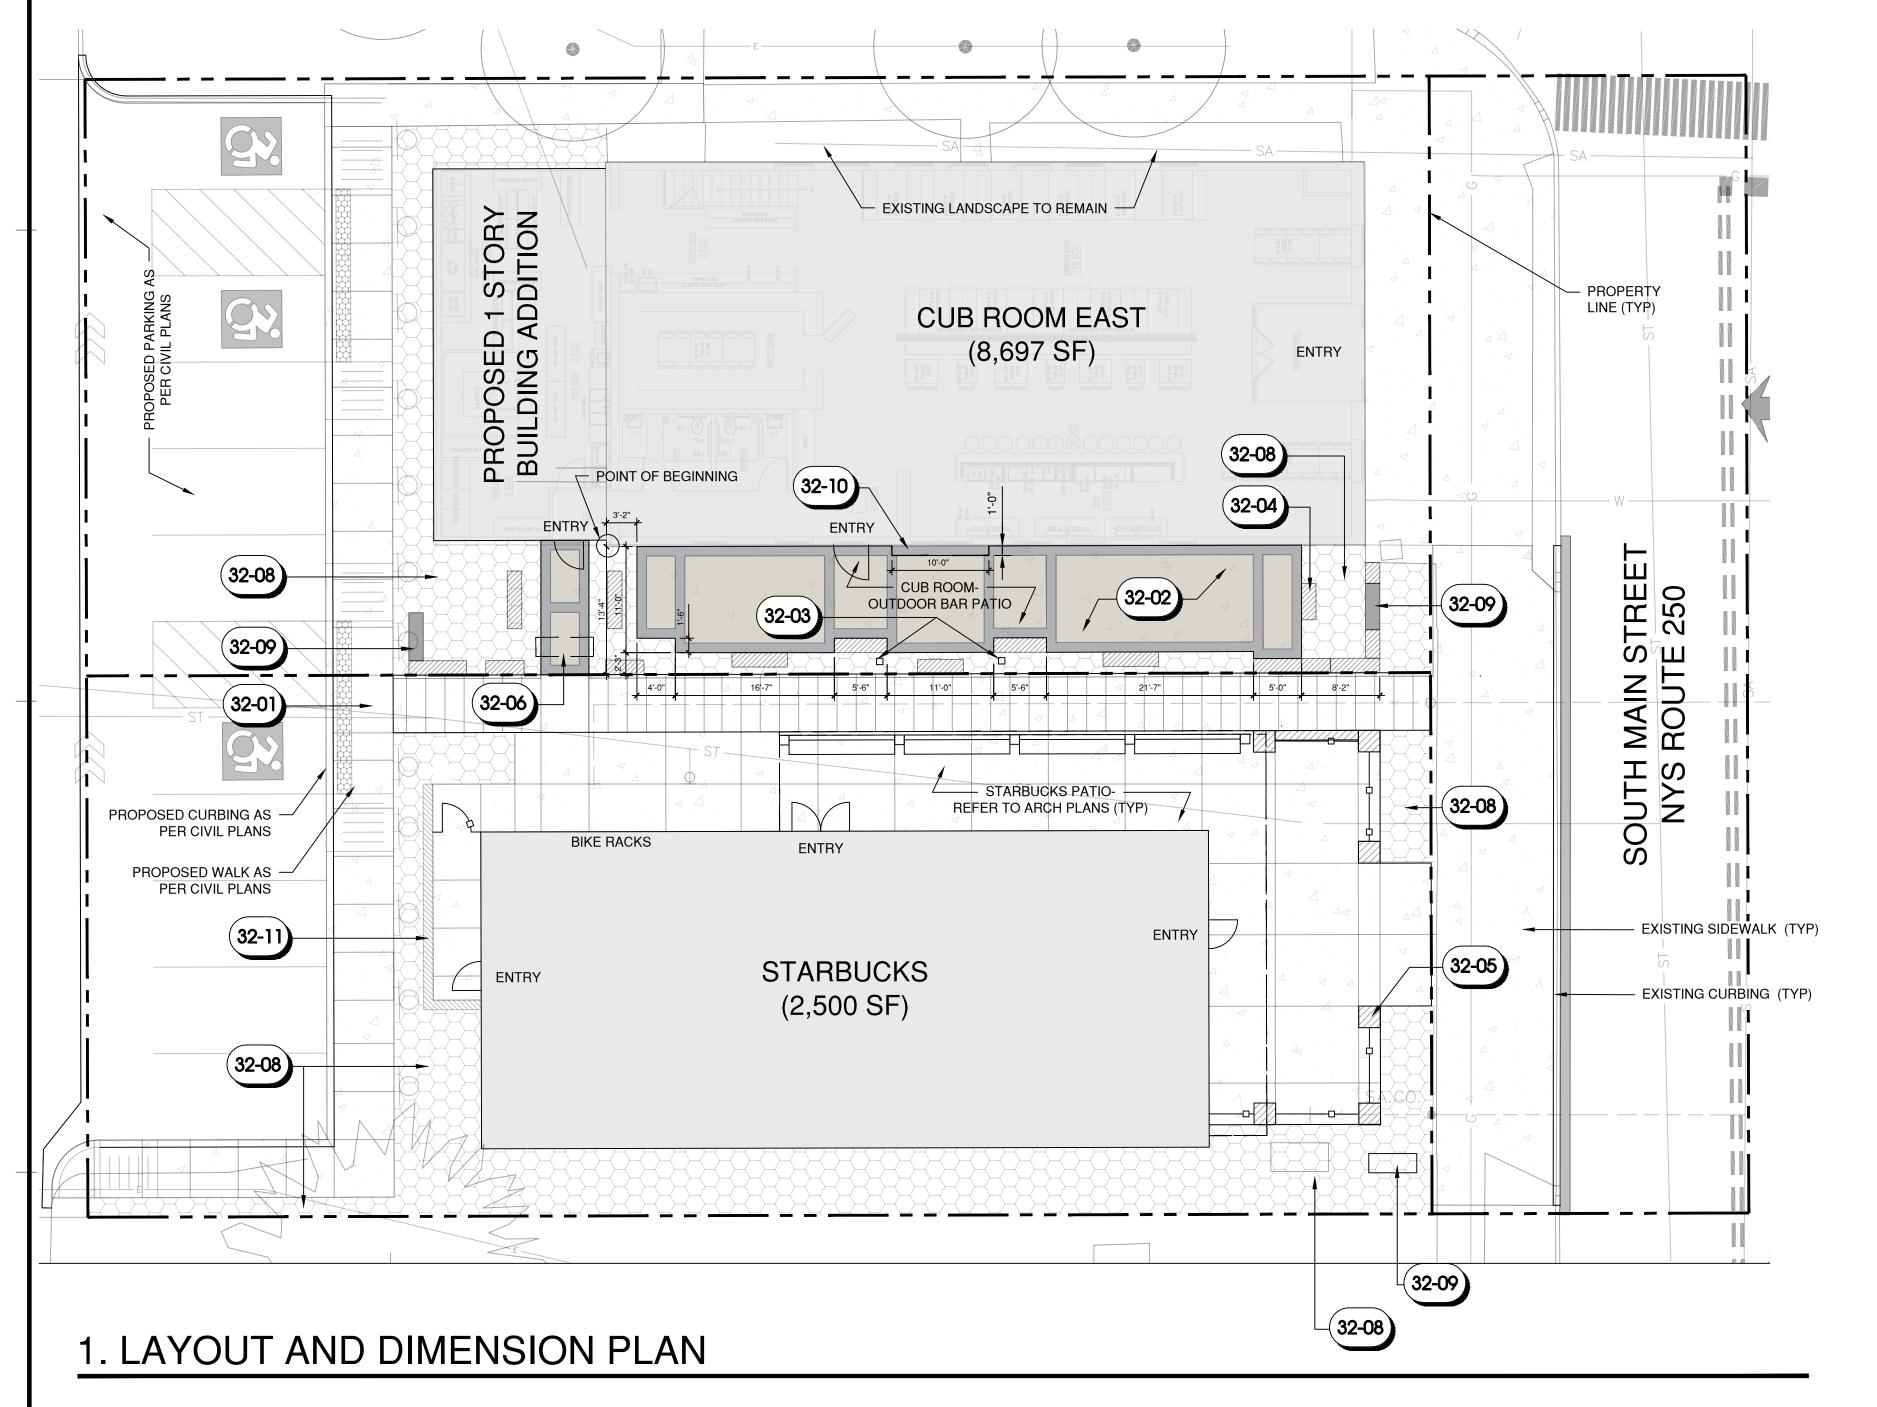

32 EXTERIO	OR IMPROVEMENTS SCHEDULE
CODE	DESCRIPTION
32-01	PROVIDE CONCRETE PAVING TO AREAS SHOWN (+/-3,200 SF)- MEDIUM BROOM FINISH, SCORING PATTERN REFLECTED ON PLAN
32-02	PROVIDE SPECIALTY PAVING TO AREAS SHOWN W/ 12-INCH BANDING (+/- 830 SF)-
	FIELD TO BE EXPOSED AGGREGATE CONCRETE W/ INTEGRAL COLOR SANDSTONE 5237 ON TH E DAVIS CHART,
	BANDING TO BE BRUSHED CONCRETE, LIGHT BROOM FINISH, WITH AN INTEGRAL COLOR GRAPHITE CARBON 8084 ON THE DAVIS COLOR CHART
32-03	PROVIDE TWO VERTICAL BLACK ALUMINUM POSTS- 8' X 8" W_9'-0" H. POSTS TO BE MOUNTED ON A FULL DEPTH FOOTING
32-04	PROVIDE RECLAIMED SANDSTONE THERMAL SLABS- LENGTHS VARY- 3',4', 5' AND 6' PIECES AS SHOWN, HEIGHTS AND THICKNESS TO BE +/-18"
32-05	PROVIDE (6) 42" HEIGHT BRICK PIER WITH PRECAST CAPPING
32-06	PROVIDE DECORATIVE ENTRY ARBOR- WROUGHT IRON, DIMENSIONS TO BE 6'-0" WIDE AND 7'-0" TALL, POSTS TO BE MOUNTED IN FULL DEPTH FOOTINGS
32-08	PROPOSED LANDSCAPE BED - REFER TO SPECIFICATIONS ON PLANTING PLAN
	CUB ROOM: 1,010 SF STARBUCKS: 1,620 SF
32-09	FREESTANDING SIGN- REFER TO L1.3
32-10	PROVIDE 4-INCH THICK THERMAL SANDSTONE SLAB COUNTERTOP W/ ROCK FACE TO MATCH BANK MATERIALS.
32-11	RETAINING WALL AS PER CIVIL PLANS- MATERIALS TO MATCH BRICK PIERS



RECLAIMED SANDSTONE SLABS W/ THERMAL FINISH TO MATCH BANK MATERIALS



EXPOSED AGGREGATE-COLOR SANDSTONE FOR CUBROOM PATIO FIELD AREAS



GRAPHITE CARBON COLOR
BANDING AROUND CUB ROOM PATIO




WROUGHT IRON ARBOR LOCATED AT CUBROOM ENTRY



BRICK PIER W/ BLACK RAIL FENCE LOCATED ON STARBUCKS PATIO




MEXICAN BEACH PEBBLE IN CUBROOM PATIO LANDSCAPE AREAS

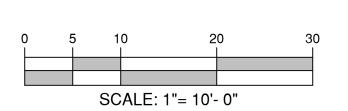

CALL DIG SAFE BEFORE YOU DIG IN NEW YORK


NORTH

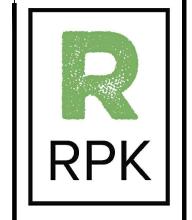

www.rpkla.com

(P) 585-502-7529 rkelly@rpkla.com

RPKI A

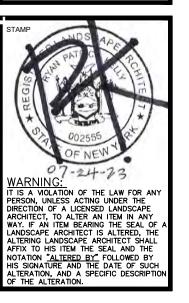

△ DATE DESCRIPTION

PROJECT NAME

PROPOSED RESTAURAN BUILDING & STARBUCK 58 SOUTH MAIN STREET FAIRPORT, NEW YORK

COB

CHECKED BY

RPK

ISSUE DATE

JULY 24, 2023

JOB NUMBER


SHEET NAME

LAYOUT & DIMENSIONS

L1.1

PLANTING NOTES:


- A. THE CONTRACTOR IS RESPONSIBLE FOR VERIFYING ALL PLANT AND MATERIAL QUANTITIES PRIOR TO BIDDING AND PROCUREMENT
- B. FIRST REPURPOSE ALL FILL FROM LANDSCAPE CONSTRUCTION FOR PLANTING OPERATIONS. ALL IMPORTED FILL FOR USE IN PLANTING BEDS WILL BE UNSCREENED TOPSOIL WITH COMPOST ADDED AT A RATE OF APPROX. 1.5 CU. FT. PER 1 CU. YD. OF TOPSOIL.
- C. LANDSCAPE ARCHITECT WILL APPROVE ALL PLANT MATERIALS PRIOR TO INSTALLATION.
- D. ALL WOODY PLANTS WILL BE OBTAINED FROM NURSERY SOURCE(S) WITH SIMILAR CLIMATE AND SOIL CONDITIONS AS THE PROJECT SITE.
- E. ALL MATERIALS WILL BE PLANTED AS PER DETAILS PROVIDED.
- F. BASE BID: ALL PLANT MATERIALS WILL BE PROVIDED WITH A 2-YEAR WARRANTY.
- BID ALTERNATE: ALL PLANT MATERIALS TO BE PROVIDED WITH A 3-YEAR WARRANTY.
- G. ALL PLANT MATERIALS WILL BE WATERED AT THE TIME OF INSTALLATION.
- H. PROVIDE 3" LAYER OF UNDYED, TRIPLE-GROUND HARDWOOD MULCH IN DARK BROWN COLOR TO ALL PLANTING BEDS, UNLESS OTHERWISE NOTED.
- . ALL PLANTS PROVIDED SHALL BE STRAIGHT SPECIES OR NON-STERILE CULTIVARS, UNLESS OTHERWISE NOTED ON PLANT SCHEDULE.
- J. CONTRACTOR SHALL PROVIDE A NATURAL SPADED-EDGE BED LINE TO ALL PLANTING AREAS, UNLESS OTHERWISE NOTED.
- K. WATERING BAGS: ALL NEWLY PLANTED TREES SHALL BE PROVIDED EACH WITH A 'TREEDIAPER36' MODEL #1036VA BY ZYNNOVATION LLC. OR APPROVED EQUAL. CONTRACTOR SHALL PRE-SOAK TREEDIAPERS TO FILL, UPON INSTALLATION. INSTALL TREEDIAPERS AS PER MANUFACTURER'S INSTRUCTIONS AND COVER WITH MULCH.
- L. THE CONTRACTOR IS RESPONSIBLE FOR FULLY MAINTAINING ALL PLANT MATERIALS (INCLUDING BUT NOT LIMITED TO WATERING, SPRAYING, MULCHING, FERTILIZING ETC.) AND LAWN AREAS UNTIL THE WORK IS ACCEPTED IN TOTAL BY THE OWNER OR OWNER'S REPRESENTATIVE.

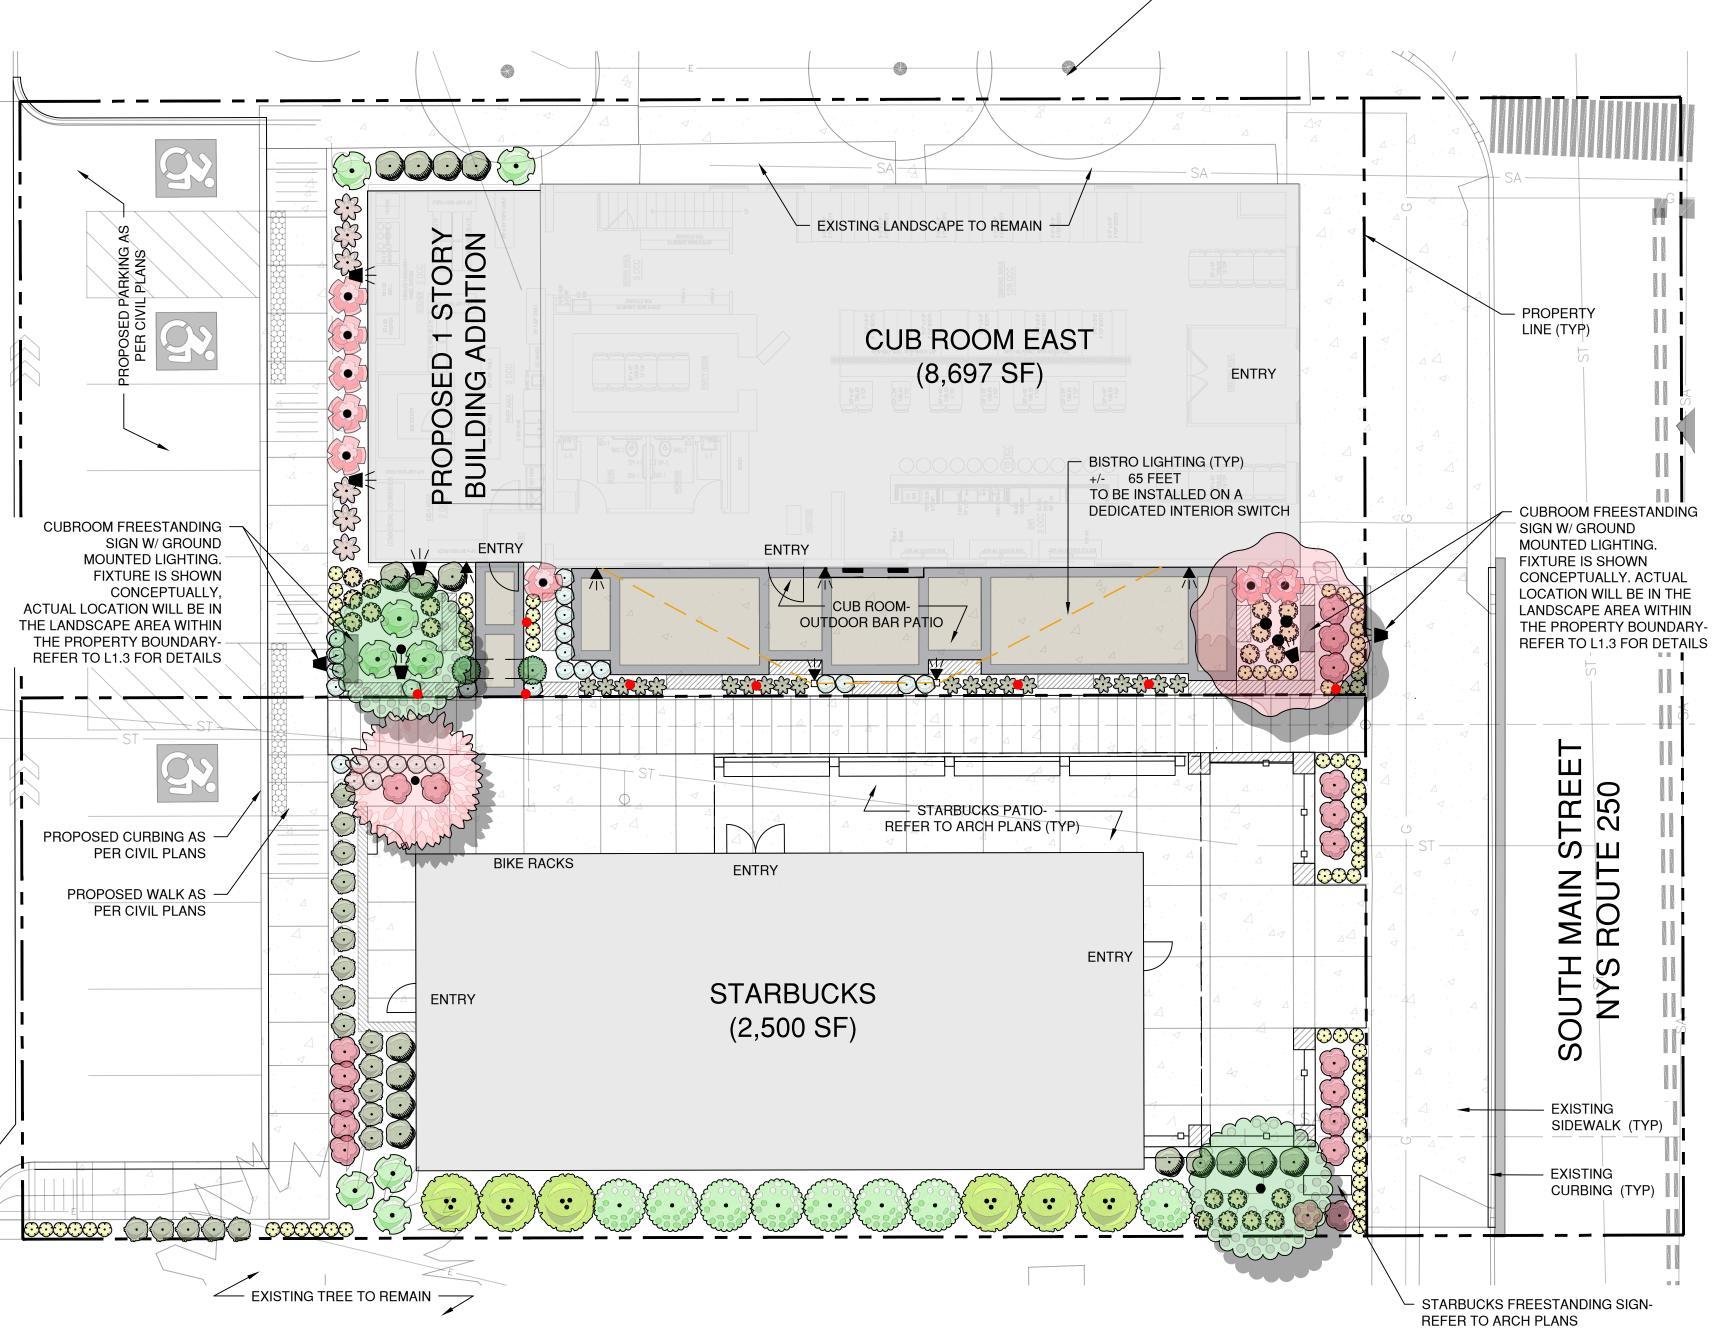

EXISTING TREES TO REMAIN

LIGHTING SCI	HEDULE	
SYMBOL	MANUFACTURER/MODEL/DESCRIPTION	QTY
•	FX LUMINAIRE PM MODERN PATH LIGHT WITH POWDER-COATED FINISH. 2.5IN. DIA X 14.0IN. H. PM-XT FOR EXTRA TALL 18.5IN ORDER CODE: PM, ALUMINUM ALLOY, (FB) FLAT BLACK, DECK MOUNT FOR PM LAMP: PM-1LED, 2.2W 2.2VA, 2700K, BEAMSPREAD: VERY WIDE FLOOD	8
4 €	FX LUMINAIRE QL DIE-CAST ALUMINUM DOWN LIGHT WITH POWDER COATED FINISH. 1.5IN. W X 2.3IN. H X 2.2IN. D. ORDER CODE: QL, ALUMINUM, (FB) FLAT BLACK, WALL PLATE, 1 GANG, QL SU LAMP: QL-1LED, 2W 2.4VA, 2700K, BEAMSPREAD: WIDE FLOOD	6
_	FX LUMINAIRE BP UNDER CAP, RAILING OR EXISTING CONSTRUCTION APPLICATIONS. 6.7IN. W X 0.9IN. H X 0.625IN. D. ORDER CODE: BP, ALUMINUM, (FB) FLAT BLACK, MOUNTING PLATE LAMP: 20W G4 LED, 1.6W 1.7VA, 2700K	2
4	FX LUMINAIRE XW-70 DIE-CAST ALUMINUM HIGH-OUTPUT WALL WASH LIGHT WITH ADJUSTABLE BODY. IP67 RATED. ORDER CODE: XW-70, ALUMINUM, (FB) FLAT BLACK, 3-PRONG SPIKE LAMP: XW-70-H1, 18W 23VA, 2700K, BEAMSPREAD: ULTRA WIDE FLOOD	7

REES	CODE	QTY	BOTANICAL NAME	COMMON NAME	CONT	CAL	SIZE
(10 mg)	JM	1	ACER PALMATUM `BLOODGOOD`	BLOODGOOD JAPANESE MAPLE	B & B	MULTI	8- 10` HT.
Exercise Services	CV	1	CRATAEGUS VIRIDIS 'WINTER KING'	`WINTER KING` HAWTHORN	B & B	1.75- 2"	8- 10` HT.
• • • •	SR	2	SYRINGA RETICULATA	JAPANESE TREE LILAC	B & B	2- 2.5"	10- 12` HT.
SHRUBS	CODE	QTY	BOTANICAL NAME	COMMON NAME	CONT	SIZE	
	CS	6	CORNUS STOLONIFERA 'ARCTIC FIRE'	ARCTIC FIRE DOGWOOD	#3 CONT.	18- 24" SP.	
	RN	8	HYDRANGEA PANICULATA 'RENSUN'	STRAWBERRY SUNDAE HYDRANGEA	#3 CONT.	18- 24" SP.	
(·	HF	8	HYDRANGEA QUERCIFOLIA `FLEMYGEA`	SNOW QUEEN OAKLEAF HYDRANGEA	#5 CONT.	24- 30" SP.	
	HQ	8	HYDRANGEA QUERCIFOLIA 'RUBY SLIPPERS'	RUBY SLIPPERS HYDRANGEA	#3 CONT.	18- 24" SP.	
	TAX	16	TAXUS X MEDIA `DENSIFORMIS`	DENSE YEW	B & B	18- 24" SP.	
	WE	19	WEIGELA FLORIDA `SPILLED WINE`	SPILLED WINE WEIGELA	#3 CONT.	18- 24" SP.	
ANNUALS/PERENNIALS	CODE	QTY	BOTANICAL NAME	COMMON NAME	CONT	SIZE	
\odot	OR	68	HEMEROCALLIS X `STELLA DE ORO`	STELLA DE ORO DAYLILY	#2 CONT.		
\odot	HB2	27	LAVANDULA ANGUSTIFOLIA `HIDCOTE BLUE`	HIDCOTE BLUE LAVENDER	#1 CONT.		
GRASSES	CODE	QTY	BOTANICAL NAME	COMMON NAME	CONT	SIZE	
	OVD	20	CALAMAGROSTIS X ACUTIFLORA 'OVERDAM'	OVERDAM FEATHER REED GRASS	#2 CONT.		
Ex. 3	DC2	20	DESCHAMPSIA CESPITOSA 'GOLDTAU'	GOLD DEW TUFTED HAIR GRASS	#1 CONT.		
£3	PVS	6	PANICUM VIRGATUM `SHENANDOAH`	SWITCH GRASS	#2 CONT.		
	SH2	19	SPOROBOLUS HETEROLEPIS	PRAIRIE DROPSEED	#3 CONT.		
VINE/ESPALIER	CODE	QTY	BOTANICAL NAME	COMMON NAME	CONT	SIZE	
\odot	ANO	2	HYDRANGEA ANOMALA PETIOLARIS	CLIMBING HYDRANGEA	#3 CONT.	2`-3`	

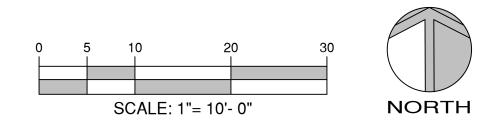

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△ DATE DESCRIPTION

PROJECT NAME

PROPOSED RESTAURAN
BUILDING & STARBUCKS
58 SOUTH MAIN STREET

COB
CHECKED BY
RPK
ISSUE DATE
JULY 24, 2023

JOB NUMBER
SHEET NAME
PLANTING PLAN

SHEET NUMBER

L1.2

1. PLANTING & LIGHTING PLAN

To: Planning Board

From: Jill M. Wiedrick, AICP, Village Planner

Date: September 13, 2023

Re: 58 South Main Street - Site Plan Review

The applicant proposes to change the use of the existing building located at 58 South Main Street (Lot 1) from a financial institution to a restaurant (a permitted use in the District), including an outdoor seating area on the south side of the building. An addition will also be constructed at the rear of the existing building. Exterior changes to the existing structure, such as removal of the drive-through from the existing structure are proposed. This building is currently vacant.

The applicant proposes to construct a 2,500 square foot building on Lot 2. This building is proposed to be used as a restaurant (a permitted use in the District). An outdoor seating area is proposed between the lot line and the building.

In between the two buildings will be outdoor seating and a walkway that connects the sidewalk on South Main Street to the parking spaces on site and ultimately, the public parking lot. A total of 11 parking spaces (2 accessible spaces) will be located at the rear of the parcels.

The proposal includes the addition of landscaping on both Lot 1 and Lot 2. In addition, the curb cuts on South Main Street will be closed, with vehicle access occuring at the rear of the site.

Please note that the proposal detailed above is subject to review by the Historic Preservation Commission

Signage is proposed and will be reviewed under the Sign Site Plan Review and Certificate of Appropriateness processes.

Should the Planning Board choose to approve the Site Plan, it is recommended that an approval be conditioned on the following;

- Approval of an access agreement by the Village Board
- Approval of a licensing agreement (refuse) by the Village Board
- Filing of a storm sewer access and maintenance easement and a hold harmless agreement between the property owner and the Village Board

Code Compliance

Purpose of District

The purpose of the district is to preserve and enhance the primary business and canal front districts in the Village of Fairport through architectural and site design that is representative in scale and character of traditional Village design; to create public and private spaces that enhance the public realm in the commercial and business district; and to reflect the vision of the community as set forth in the Village Comprehensive Plan.

To accomplish the foregoing, the Design Overlay District is created and regulations therefore established which shall supersede any conflicting provisions in this chapter applicable to the underlying zoning districts.

Design Overlay District Review

§ 550-46 **Buildings standards**.

- B. Height. Structures shall be a minimum of two stories and 24 feet in height and a maximum of 45 feet. Other building heights can be approved by the Planning Board with consideration given to:
 - (1) Height of adjacent buildings.
 - (2) Enclosure created by the building in relation to street width (building-face to building-face).
 - (3) Vistas and views.
 - (4) Structures that possess unique value to the Village and maintain the vision set forth in the Comprehensive Plan and these design standards.

The existing Bank of America building is 35' 6" feet tall and is one story.

The proposed building is 24' 9" tall and is one story.

The proposed building complies with the height requirement, but does not comply with the minimum number of stories. Please note that the Bank of America building is one story and the building immediately to the south of the proposed building (70 South Main Street) is a two-story structure.



C. Width to height ratio. Buildings shall have a width to height ratio between 1:1 and 1:2.

The existing building (Bank of America) does not meet the width to height ratio as the width of the building is 40' and the height of the building is 35' 6".


The proposed building does not meet the width to height ratio. The width of the proposed building is 33' and the height is 24' 9".

D. Setbacks.

(1) Front setback. All structures shall have a front setback of zero feet from the lot line, or when the lot line encroaches in the right-of-way the setback shall be zero feet from the right-of-way. A setback greater than zero feet can be approved by the Planning Board to create space for outdoor eating, public art or other semipublic uses that enliven the public realm. Corner buildings are subject to the front setback requirement on both street frontages.

The existing building does not meet the front setback requirement of zero and is setback 6.7' from the lot line.

The proposed building does not meet the front setback requirement of zero and is setback 16'. It should be noted that an outdoor seating area has been proposed to enliven the public realm.

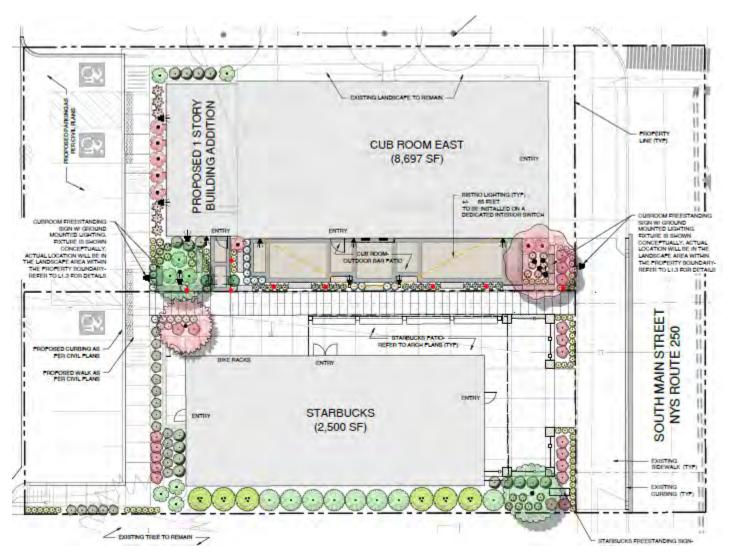

- F. Facade composition.
- (5) Transparency. A minimum of 60% of all first floor facades with street frontage shall consist of pedestrian entrances, display windows or windows affording views into retail, offices, gallery or lobby space. The building wall subject to transparency requirements shall include the portion between three feet and 10 feet above the sidewalk. Blank walls should be avoided and lively facades encouraged.

The transparency of the existing Bank of America building is 34%.

§ 550-47 **Site standards**.

A. Lot coverage.

Required	BOA Building (Lot 1)	Proposed Building (Lot 2)
Building Coverage	44%	32%
70%		
Parking Lane Coverage	16.7%	15.7%
10%		
Green / Open Space	12%	16%
20%		

- B. Parking and circulation.
- (2) The number of off-street parking spaces required shall be consistent with underlying zoning district.


Proposed Use	58 South Main Street – Restaurant (Lot 1)	Proposed Building – Restaurant (Lot 2)	
Required Parking			
Indoor Seating – 1 space	Occupancy = 120 persons	Occupancy = 28 persons	
per four occupants	Parking = 30 spaces	Parking = 7 spaces	
Outdoor Seating – 1 space	Outdoor Seats = 40 seats	Outdoor Seats = 32 seats	
per four outdoor seats	Parking = 10 spaces	Parking = 8 spaces	
Total Required	40 spaces	15 spaces	
Total Required for Lot 1 and Lot 2	55 spaces		
On-site parking spaces	11 spaces	_	

A parking waiver of 44 spaces is required.

(3) Where municipal lots are within 500 feet, or ample on-street parking is present, the Planning Board, in its discretion, may reduce or waive off-street parking requirements.

As displayed below, the subject property is within 500 ft of two municipal parking lots.

Parking lot	Spaces
Village Landing	Upper: 282, Lower: 86
Packett's Landing	216

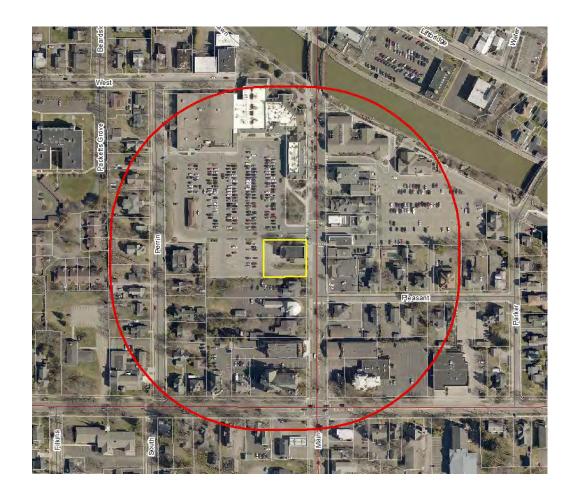

In addition to being within 500' of two municipal parking lots, the applicant has also submitted written correspondence between the applicant and the representative of the property immediately to the south of the parcel (70 South Main Street) that parking (13 spaces) at 70 South Main Street may be used by the employese of uses located on Lot 1 and Lot 2 during hours when the business at 70 South Main Street is not in operation.

The applicant has also submitted data regarding usage at the Landing municipal lot. Please see Page 2 of the Engineer's Memo. This data provides the average available space counts for peak weekend morning and afternoon time on several days in May and July 2023.

The following standards will be used to evaluate the proposed amendments to the existing Site Plan Approval.

550-19 Factors for Consideration

- A. The Planning Board's review of a preliminary site plan shall include but is not limited to the following considerations:
- (1) The adequacy and arrangement of vehicular traffic access and circulation, including intersections, road widths, channelization structures and traffic controls.
- (2) The adequacy and arrangement of pedestrian traffic access and circulation, including the separation of pedestrian from vehicular traffic, walkway structures, control of intersections with vehicular traffic and pedestrian convenience.
- (3) The location, arrangement, appearance and sufficiency of off-street parking and loading areas.
- (4) The location, arrangement, size and design of buildings, lighting and signs.
- (5) The adequacy, type and arrangement of trees, shrubs and other landscaping constituting a visual and/or a noise-deterring buffer between these and adjoining lands.
- (6) In the case of an apartment house, townhouse or multiple dwelling, the adequacy of usable open space for playgrounds and informal recreation.
- (7) The adequacy of stormwater and sanitary waste disposal facilities.
- (8) The adequacy of structures, roadways and landscaping in areas with a moderate to high susceptibility to flooding and ponding and/or erosion.
- (9) The protection of adjacent properties against noise, glare, unsightliness or other objectionable features.
- B. In its review, the Planning Board may consult with the Village Engineer and other Village, town and county officials, as well as with representatives of federal and state agencies, including the Soil Conservation Service and the New York State Department of Environmental Conservation. The Planning Board may require that the exterior design of all structures be made by or under the direction of a registered architect, whose seal shall be affixed to the plans.
- C. When reviewing a site plan because of a change in the use or occupancy of land, a building or any portion thereof, the Planning Board shall consider the impact of the proposed change upon other uses within the same building or parcel. To the extent practical, the Planning Board may require such modification thereto as will promote the most efficient use of land consonant with compliance with the provisions of this chapter. In no event shall the Planning Board waive the direct application of a local law provision to the changed use or occupancy under review.

550-45 District design principles.

The following principles shall guide all development and redevelopment in the Design Overlay District and provide additional regulatory criteria for the Planning Board in its site plan review process:

- A. Create, maintain and/or reinforce pedestrian-oriented and human-scaled streetscapes that promote safe pedestrian movement, access and circulation, and a pleasant experience for pedestrians.
- B. Encourage and promote direct visual and physical access to and from the Erie Canal and Main Street.
- C. Promote the design of buildings and sites to be an integral part of the public realm with identifiable buildings entrances, active storefronts, attractive parking areas, and an effective/efficient circulation system.
- D. Encourage and promote the design of buildings, sites and public spaces through the use of design elements, details, architectural styles and materials or treatments that reflect traditional Village character.
- E. Locate off-street parking areas to the side or rear of the structure and encourage the use of existing public lots whenever possible and, in cases where parking is adjacent to the street or sidewalk, provide clear separation with the use of landscaping, knee walls, fencing, or other methods viewed as appropriate by the Planning Board.
- F. Utilize landscaping to soften hard edges and buffer adjacent properties whenever possible.



























