TOWN OF MANCHESTER PLANNING AND ZONING COMMISSION

April 1, 2024 7:00 P.M.

Lincoln Center Hearing Room, 494 Main Street Or virtually, via Zoom

AGENDA

This meeting will be held both in person and virtually, via Zoom. The meeting will be shown live on Cox Channel 16 and streamed live at

http://www.channel16.org/CablecastPublicSite/watch/1?channel=1. Individuals who wish to speak at or attend the virtual meeting must complete a Request to Attend Virtually form, available at https://manct.us/meeting by 4:00 p.m. on the day of the meeting. These individuals will need to join the Zoom meeting and will be allowed to speak when directed by the Chairman. Zoom meeting information will be sent to individuals who complete a Request to Attend Virtually form. Only individuals who complete a Request to Attend Virtually form will be allowed to join the Zoom meeting. A physical location and electronic equipment will be provided for the public to use if a written request is received at least 24 hours in advance, via email to pzccomments@manchesterct.gov, or by mail to the Planning Department, 494 Main Street, P.O. Box 191, Manchester, CT 06045-0191.

PUBLIC HEARING:

1. **PROPOSED SIDEWALK AND CURB PLAN 2024-2029** – Proposed amendments to the Town Sidewalk and Curb Plan.

BUSINESS:

- 1. **PROPOSED SIDEWALK AND CURB PLAN 2024-2029** Proposed amendments to the Town Sidewalk and Curb Plan.
- 2. TOWN OF MANCHESTER PUBLIC WORKS DEPT. Expansion of Charter Oak Park facilities including a new skate park/pump track, synthetic turf playing field, and parking lot at 30 Charter Oak Street.
 - Inland Wetland Permit Determination of Significance (IWP-0003-2024)
- 3. <u>DISCUSSION: OPEN SPACE ACQUISITION PROCESSES</u>
- 4. DISCUSSION: MUNICIPAL FINES FOR INLAND WETLANDS VIOLATIONS
- 5. ADMINISTRATIVE REPORTS
 - Upcoming Training Opportunities
- 6. APPROVAL OF MINUTES
 - March 18, 2024 Public Hearing/Business Meeting
- 7. RECEIPT OF NEW APPLICATIONS

TOWN OF MANCHESTER LEGAL NOTICE

The Planning and Zoning Commission will hold a public hearing on April 1, 2024 at 7:00 P.M., both virtually and in person in the Lincoln Center Hearing Room, 494 Main Street, Manchester, Connecticut, to hear and consider the following petitions:

<u>PROPOSED SIDEWALK AND CURB PLAN 2024-2029</u> – Proposed amendments to the Town Sidewalk and Curb Plan to include updates and recommendations of priority locations for the extension of sidewalks, and proposed amendments to the Sidewalk Location Map to reflect completed projects and other changes pursuant to Article IV Section 279-31 of the Code of the Town of Manchester, Connecticut.

At this hearing interested persons may be heard, either in person or virtually via Zoom, and written communications received. This meeting will be shown live on Cox Channel 16 and streamed live at http://www.channel16.org/CablecastPublicSite/watch/1?channel=1. Individuals who wish to speak at or attend the virtual meeting must complete a Request to Attend Virtually form, available at https://manct.us/meeting, by 4:00 p.m. on the day of the meeting. These individuals will need to join the Zoom meeting and will be allowed to speak when directed by the Chairman. Zoom meeting information will be sent to individuals who complete a Request to Attend Virtually form. Only individuals who complete a Request to Attend Virtually form will be allowed to join the Zoom meeting. A physical location and electronic equipment will be provided for the public to use if a written request is received at least 24 hours in advance, via email to pzccomments@manchesterct.gov, or by mail to the Planning Department, 494 Main Street, P.O. Box 191, Manchester, CT 06045-0191.

Individuals may also submit comments in writing to the Planning and Economic Development Department via email to pzccomments@manchesterct.gov, or by mail to the Planning Department, 494 Main Street, P.O. Box 191, Manchester, CT 06045-0191. All written comments received by 4:00 p.m. on the day of the meeting will be presented and recorded as part of the hearing.

A copy of the proposed Sidewalk and Curb Plan amendments may be reviewed online at https://www.manchesterct.gov/Government/Departments/Planning-and-Economic-Development; by contacting the Town Clerk's office at townclerkdept@manchesterct.gov or (860) 647-3037 to request a PDF by email; or in the Planning and Economic Development Department, 494 Main Street, during regular business hours, 8:30 – 4:30, Monday through Friday. Information about this application will be available online at https://Manchesterct.gov/pzc by the Friday before the hearing.

TOWN OF MANCHESTER PLANNING AND ECONOMIC DEVELOPMENT DEPARTMENT

TO: Planning & Zoning Commission

FROM: Megan Pilla, Principal Development Planner

DATE: March 28, 2024

RE: Proposed Sidewalk & Curb Plan 2024-2029

Introduction

Pursuant to Article IV, Section 279-31 of the Code of the Town of Manchester (attached for reference), the Planning & Zoning Commission must review and update the Sidewalk and Curb Plan every five (5) years. The existing Plan was most recently adopted with revisions in April 2019, and is due to be updated and adopted again now.

As described in the ordinance, the purpose of this Plan is to aid in determining whether or not developers shall be required to install sidewalks and curbs simultaneous with new building construction, and if payment of a fee in lieu of such installation is acceptable, on a case by case basis.

Proposed Update

Proposed updates to the Plan document include the following:

- Addition of a "Purpose" section to explain the purpose of the Plan, as dictated by the referenced ordinance.
- Addition of a "Maps" section to clearly identify the maps that are included in the Plan.
- Revision of the minimum standard width for sidewalks on Rural/Scenic Roads from "8 feet" to "6-8 feet, based on site conditions."
- Staff recommendations for streets to be added to the list of "critical path extensions" on pg. 4 of the Plan.
- Revision of the "Removal of Sidewalks" section to clarify that the Plan no longer recommends any specific sidewalks to be removed.
- Several minor language and grammar revisions.

Proposed updates to the Sidewalk Location Map, which is part of this Plan, include:

• Updates to reflect sidewalk extensions and gap closures that have been completed since 2019.

- Deletion of the term "Bike Lane" from the legend, because this term is incorrect in this context (the referenced trails are multi-use trails, not bike lanes).
- Deletion of the category "Neighborhood Identified For Possible Sidewalk Removal Projects" from the legend, because sidewalk removals are no longer recommended on a neighborhood scale.
- Removal from the Map of any trails that are not adjacent to public streets, because they are irrelevant to the purpose of this Plan.

No changes are proposed to the Roadway Classification map, which accompanies this Plan only for reference.

Staff Review

As required by the ordinance, the proposed Plan update was sent to the Board of Directors for review. As of the writing of this memo, no comments from the Board have been received. An update on the status of any comments will be provided to the Commission at the April 1, 2024 meeting.

$$\label{eq:power_problem} \begin{split} & mp \\ & \text{R:Planning} \\ & \text{PZC} \\ & \text{2024} \\ & \text{04 - April 01} \\ & \text{Packet} \\ & \text{Sidewalk Plan - Memo.docx} \\ & \text{Attach.} \end{split}$$

Town of Manchester, CT Wednesday, March 20, 2024

Chapter 279. Streets and Sidewalks

Article IV. Assessments for Sidewalks and Curbs

§ 279-31. Sidewalk and curb installation on existing streets simultaneous with building construction.

[Amended 7-22-2003]

- A. The owner of lands on which any structure is hereafter erected, fronting on public highways or streets in the Town, shall install concrete sidewalks and granite curbs in accordance with the public improvement standards of the Department of Public Works, if such installation is in conformance with the sidewalk and curb plan of the Town as approved by the Town Planning and Zoning Commission. Said walks and curbs shall be installed concurrently with the construction of said structure. When, for good cause shown, the installation of either sidewalks or curbs is not advisable or desirable, the Planning and Zoning Commission may allow and/or require the owner of said lands to make a payment to the Town in lieu of the installation. The Planning and Zoning Commission shall not make its determination until it has received a recommendation from the Director of Public Works on the advisability of installing the sidewalks and/or curbs. The Director of Public Works shall make his recommendation no later than 20 working days from the receipt of the request for an opinion from the Planning and Zoning Commission or its designated staff. [Amended 3-3-2009]
- B. When payment in lieu of installation is required, payments shall be in an amount based upon the prevailing costs of said improvements as determined by the director of public works. If a substitute material for granite curbing is required temporarily for good cause, the cost of the substitute material shall be deducted from the cost of the granite, and the balance will constitute the payment in lieu of installation.
- C. Payments in lieu of installation shall be deposited into a dedicated fund to be used solely for the installment of new sidewalks and curbs. A record of all property owners and properties subject to the payment in lieu of installation shall be kept by the Planning Department, and said property owners shall not be liable for any fee or assessment for the installation of sidewalks or curbs in front of their property in the future.
- D. The Planning and Zoning Commission shall prepare and adopt a sidewalk and curb plan for the Town. The plan shall set forth the policies for determining where sidewalks and curbs would be installed; enumerate examples of what constitutes good cause for allowing or requiring payment in lieu of installation; and recommend priority locations for the extension or removal of sidewalks. The sidewalk and curb plan shall be reviewed and amended as appropriate every five years. The plan shall be so revised and adopted within six months of the adoption of this section and every five years thereafter. Before adoption, the plan shall be submitted to the Board of Directors for review and comment, and at least one public hearing shall be held.
- E. If concrete sidewalks, concrete curbs or granite curbs are in existence abutting the land on which any structure is hereinafter erected, fronting on public highways or streets in the Town, the owner of such lands shall repair said sidewalks and curbs to the satisfaction of the Director of Public Works

or his designated representative. Existing bituminous curbs shall be removed and replaced with granite curbs.

[Amended 3-3-2009]

- F. The Building Department shall affix a copy of this regulation to all building permits issued by it.
- G. From the effective date of this section forward, any previously granted deferments may be called by the Board of Directors, and the then-owner of the property shall be required to pay the cost of said installation. Before calling a deferment, the Board of Directors shall request a written recommendation from the Planning and Zoning Commission and Director of Public Works on the advisability of calling said deferment.

2019<u>2024</u>-<u>202</u>4<u>2029</u>

TOWN OF MANCHESTER SIDEWALK AND CURB PLAN



Prepared by:

Manchester Planning Department Manchester Public Works Department

Adopted April 1, 2019 TBD Planning and Zoning Commission

SIDEWALK & CURB PLAN

Purpose

In accordance with Town ordinance § 279-31, which requires the installation of sidewalks and curbs by property owners simultaneous with new building construction, the purpose of this plan is:

- To set forth the policies for determining where sidewalks and curbs should be installed along public streets;
- To recommend priority locations for the extension of sidewalks; and
- To enumerate examples of what constitutes good cause for allowing or requiring payment in lieu of sidewalk installation.

Introduction

Providing paths for pedestrians has always been fundamental to community building, and while the need for and function of sidewalks has changed, it has not disappeared. The purpose of sidewalks is to provide a safe location for people to walk separated from motorized or mechanized vehicles. Sidewalks are an elemental form of transit, connecting people to public transit, schools, work, shopping, services, and cultural or recreational facilities and activities. They provide a space for spontaneous social interaction. They are increasingly used as a recreation and health amenity in themselves for walkers and joggers. For families with young children sidewalks provide a safe dedicated space for youngsters to learn to ride a bike or rollerblade.

For all of these reasons, Manchester has long required individuals and businesses developing land in Manchester to construct sidewalks. The goal is to provide pedestrian connections within neighborhoods, connections between neighborhoods, and connections from homes to services, facilities, and amenities in the community.

The Town's Sidewalk Plan was first adopted in 1980. Since that time there have been at least twoseveral periods of significant new industrial, commercial and residential development in Manchester. Because As development has extendged to previously undeveloped areas and away from beyond the Town center, the Planning and Zoning Commission periodically reviewsed the Sidewalk Plan considering current conditions and anticipated future trends. Our sidewalk and curb policies, and the location map that will serves as a guide for the implementation of this Plan, have been revised to reflect these new current realities condition. The Plan articulates policies for where new sidewalks should be installed; effectively and sensibly deals with new installations in developed areas; sets guidelines on how and whether to decide to remove

sidewalks in certain areas, identifies priorities for filling in gaps and/or extending the existing system; and provides guidance on what types of curbs should be installed in various locations or conditions.

Maps

The following maps are included with this Plan:

- Sidewalk Location Map a map of all existing and anticipated future sidewalks along public streets, identified by material type.
- Roadway Classification Map the classification of all public streets by type, to be used in accordance with the policies outlined below for locating new sidewalks.

Policy for New Sidewalk Installation

As a general policy, the Sidewalk Plan calls for concrete sidewalks on all-most streets in the Town of Manchester. The amount and location of sidewalks will vary depending on the type of street and its function. Table One describes the minimum standards and locations for sidewalks. Roadway classifications are shown on the Roadway Classification Map, Town of Manchester Sidewalk Plan, dated revised July 2009(date TBD).¹

On all <u>new</u> local streets, sidewalks will be constructed as required in Table One unless the judgment is made by the Planning and Zoning Commission, with the recommendation of the Public Works Department (PWD), that payment in lieu of installation is warranted. On all <u>existing</u> local² streets, sidewalks will be required as identified on the Sidewalk Location Map, unless the judgment is made by the Planning and Zoning Commission, with the recommendation of PWD, that payment in lieu of installation is warranted.

Table One

Minimum Standards for Sidewalks						
Roadway Classification	Sidewalk	Concrete	Bituminous	One	Two	
	Width		or	Side	Sides	
	(feet)		Alternative			
Arterial Street	5	X			X	
Collector Street	5	X			X	
Local Street	5	X		X		
Rural/Scenic Road	<u>*6-</u> 8		X	X		

^{*} based on site conditions

-

¹ Rev. 1/21/09 ² Rev. 1/21/09

Regardless of the general policy and standards recommended in this Plan and contained in Table One above, the location of sidewalks on existing streets shall be based on the Sidewalk Location Map which is a part of this Plan. Sidewalks will be required on all street segments identified as Proposed Sidewalk Extensions, and repairs, if necessary as required by the Town Sidewalk Ordinance (see Appendix A), will be required on all segments identified as existing sidewalk. The Plan may require that sidewalks be built on both sides of an existing local street if it is deemed necessary for pedestrian safety given the proximity to schools, the housing density of the neighborhood, and other factors.

When required on only one side of the street, sidewalks shall be installed on the north and east sides of the roadway to facilitate snow melt and ease of maintenance. While this general standard should always apply, there may be circumstances where the location, width, or material requirements may be waived. Conditions that may warrant a deviation from these standards include the following:

- Infill development in neighborhoods or on streets where the sidewalks should match the dominant pattern on the street or in the neighborhood.
- Physical features of the area including the available right-of-way, grades, rocks/ledge, specimen trees or other important natural features which should be preserved, etc. In these cases the Director of Public Works may recommend, and the Planning and Zoning Commission may approve, alternate locations.

All sidewalks shall be built according to the design and construction standards contained in the Town of Manchester Public Improvement Standards, as amended.

Critical Path Extensions

The Sidewalk Plan has identified the desirable locations for sidewalks throughout the Town of Manchester. Keeping in mind this Plan will be updated every five years, the Plan identifies selected streets as priorities for the extensions of new sidewalks. Criteria for determining these critical path connections include the following:

- The desire to provide safe pedestrian connections to schools, shopping, or transit facilities, with consideration given to the school location, residential density and nature of the streets and traffic.
- The desire to provide safe pedestrian walkways on arterial or collector streets where such
 pedestrian systems are not now available, in particular highly populated or highly
 traveled areas.
- The desire to close gaps in sidewalk systems in areas of high pedestrian traffic.

The priority streets identified as part of this Plan are:^{3 4}

- Broad Street from Middle Turnpike West to Hilliard Street
- Tolland Turnpike
- Keeney Street from Bush Hill Road north
- Parker Street from East Center Street to Mather Street
- Sheldon Road
- Woodland Street
- Woodbridge Street from Parker Street to Weaver Road
- East Center Street from Goodwin Street to Middle Turnpike East
- Charter Oak Street
- Wyllys Street/Porter Street
- Autumn Street
- Bush Hill Road
- Hilliard Street from Duval Street to Fleming Road

Although these are priority streets for extensions, such extensions are dependent upon the availability of funds and may not be <u>included completed</u> during the <u>20192024-2024-2029</u> planning period. Likewise, other streets may see their sidewalks extended if funding opportunities arise, or if circumstances arise during the planning period that warrant sidewalk extensions on non-priority streets.

Removal of Sidewalks

In some circumstances in older residential neighborhoods where there are sidewalks on both sides of the street, it may be desirable to remove sidewalks to meet the current standard of sidewalks on only one side of the street. Removing walks on one side of the street would bring older neighborhoods in line with current practice for local streets. The removal of sidewalks within narrow rights of way provides opportunities to create greater separation of pedestrian and vehicular traffic. Selective removal would allow more neighborhood sidewalks to be repaired or replaced over the long-term, and the Town's long-term maintenance and liability costs would be reduced. The removal of sidewalks is not generally recommended; however, the Town recognizes that unique circumstances may arise in which removals could be considered. Such instances will be reviewed on a case by case basis.

Sidewalk removal projects will be pursued only after an analysis of neighborhood conditions has been completed and public meetings with neighborhood residents have been held. Conditions which may warrant the removal of sidewalks include the following:

• The amount of right-of-way available in the existing public street area.

Rev.7/6/09

Rev.02/13/14
⁴ Rev. 04/01/19

4

³ Rev. 1/21/09

- The density of housing in the neighborhood. Generally the lower the housing density and the smaller the resident population, the more unlikely sidewalks will be necessary on both sides of the street.
- On streets with low traffic volumes and/or which are not major pedestrian corridors, sidewalks will less likely be necessary on both sides of the street.
- Neighborhoods whose distance from commercial or service uses would generate less pedestrian traffic may not require sidewalks on both sides of the street.
- Neighborhoods with wide rights-of-way, exclusively residential areas and neighborhoods not in proximity to non-residential uses.

Granite Curbing Installation

- Installation of granite curbs shall be required on all new local streets and extensions of existing local streets.
- Granite curbs shall be required on all collector and arterial streets as shown on a Town of Manchester Roadway Classification Map.
- When existing roadways and sidewalks are reconstructed on local streets, curbs should be replaced with the predominant curb type that exists within the neighborhood, as determined by PWD.
- On rural/scenic roads, the determination whether to install granite curbs or alternate materials will be based upon such factors as the street grade, stormwater management considerations, and natural features and topography.

Rural/Scenic Roads

Although Manchester is a largely developed community, there are some roads that are, and should remain, rural and scenic in character. These are roads in outlying areas that are mostly identified as natural or rural/agriculturalconservation sectors on the proposed character mapConservation & Growth Map in the Town's Plan of Conservation and Development.

ManchesterNEXT. Future development in these areas is anticipated to be at low densities that would not conflict with rural or scenic roads. In these areas a pedestrian path should be provided, but a bituminous or stone dust pedestrian path may be more appropriate than granite curbs and concrete sidewalks.

Good Cause for Payment in Lieu of Installation

The This Plan identifies desirable locations for sidewalks and curbs⁵ throughout the community. The Plan recognizes that, depending on the amount of Town financial resources available, and the development pattern in various areas, it may not be prudent or practical to install sidewalks and curbs⁶ in all new developments approved during the <u>current</u> five—year planning period. Where the Plan calls for sidewalk and curb installation, but where there is good cause not to install them at the time of the development, payment in lieu of installation shall be required in accordance with the Town Sidewalk Ordinance (see Appendix A).

Criteria Situations in which requirement of payment in lieu of installation mayto be considered by the Planning and Zoning Commission following a recommendation by the Director of Public Works when requiring payment in lieu of installation would include, but are not be limited to, the following:


- There are no other sidewalks or curbs within a reasonable distance of the area where the sidewalks would be required.
- There are no sidewalks or curbs in the area or on the street where new walks would be otherwise required.
- There is no project funded by the Town that would fill in the gaps that exist in the sidewalk and/or curb system on the street where the development is proposed.
- There are plans in the near term for major street reconstruction which would provide opportunities to fill gaps in the sidewalk and/or curb system, but it would be better to construct the required sidewalks as part of the larger reconstruction project.
- When a sidewalk and or granite curbs are to be located within the right of way of a State road and the State denies a permit for the installation⁷.


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⁶ Rev. 7/06/09

⁵ Rev. 1/21/09

⁷ Rev. 7/06/09



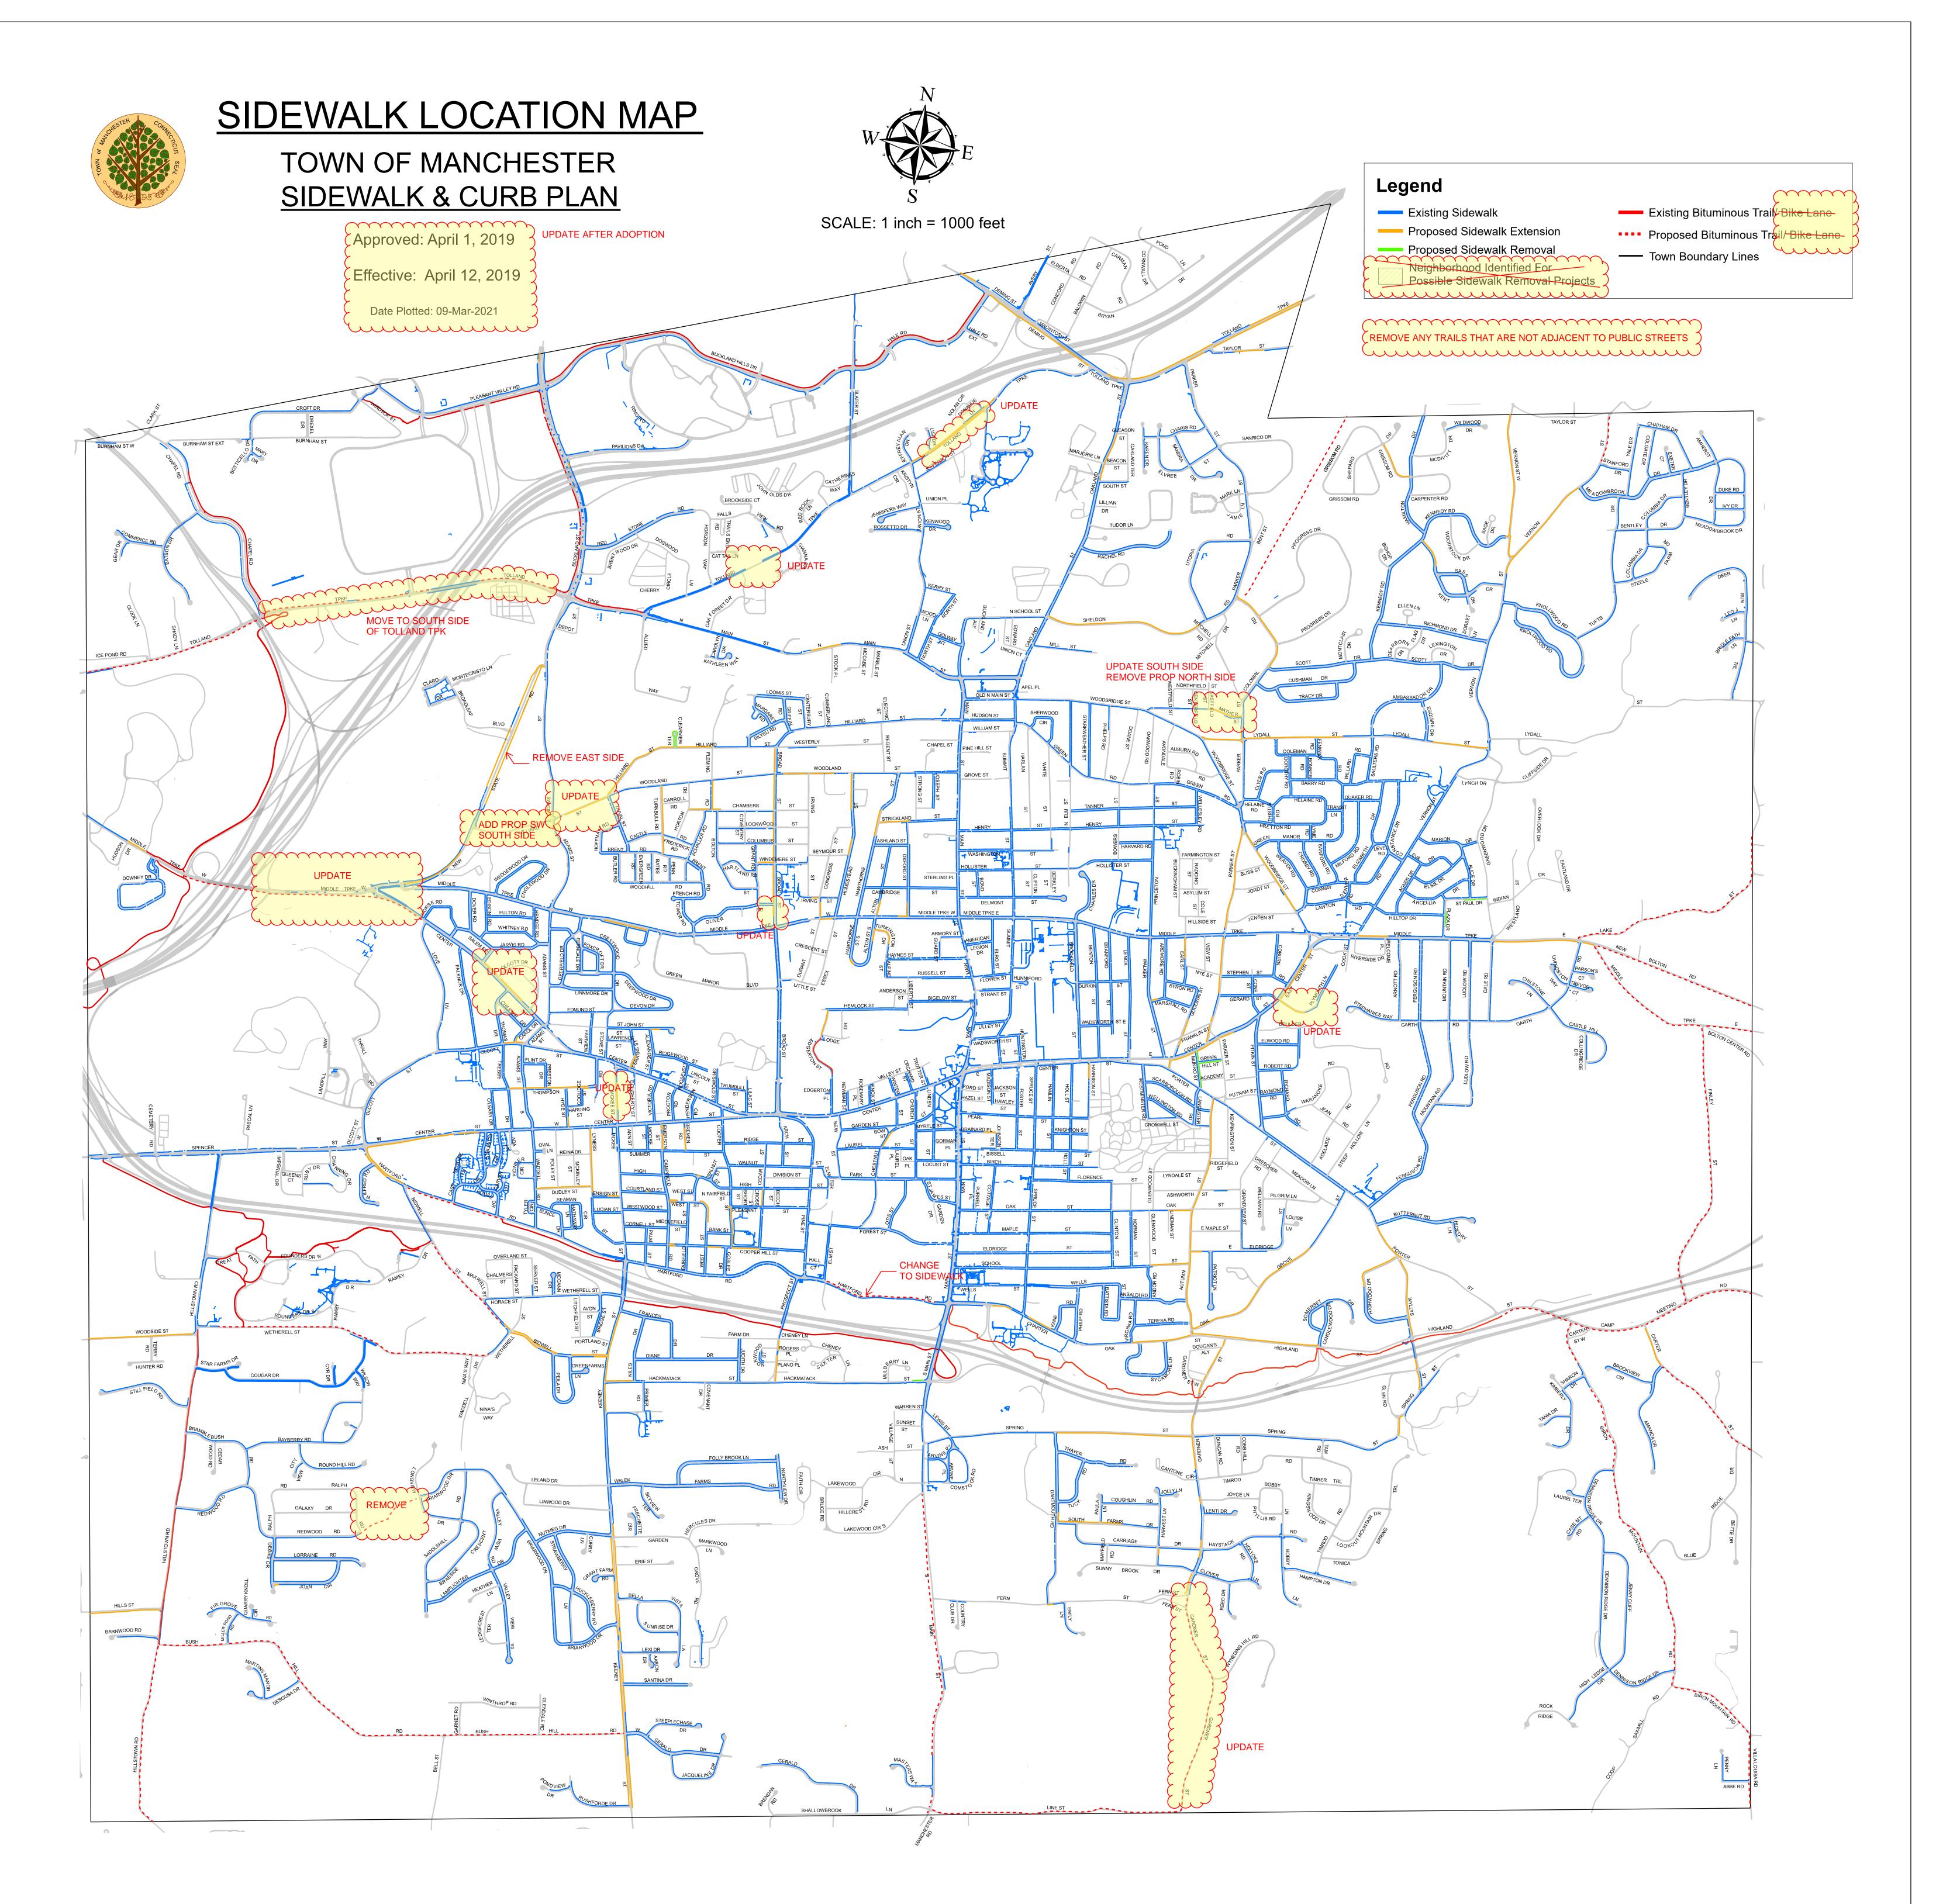

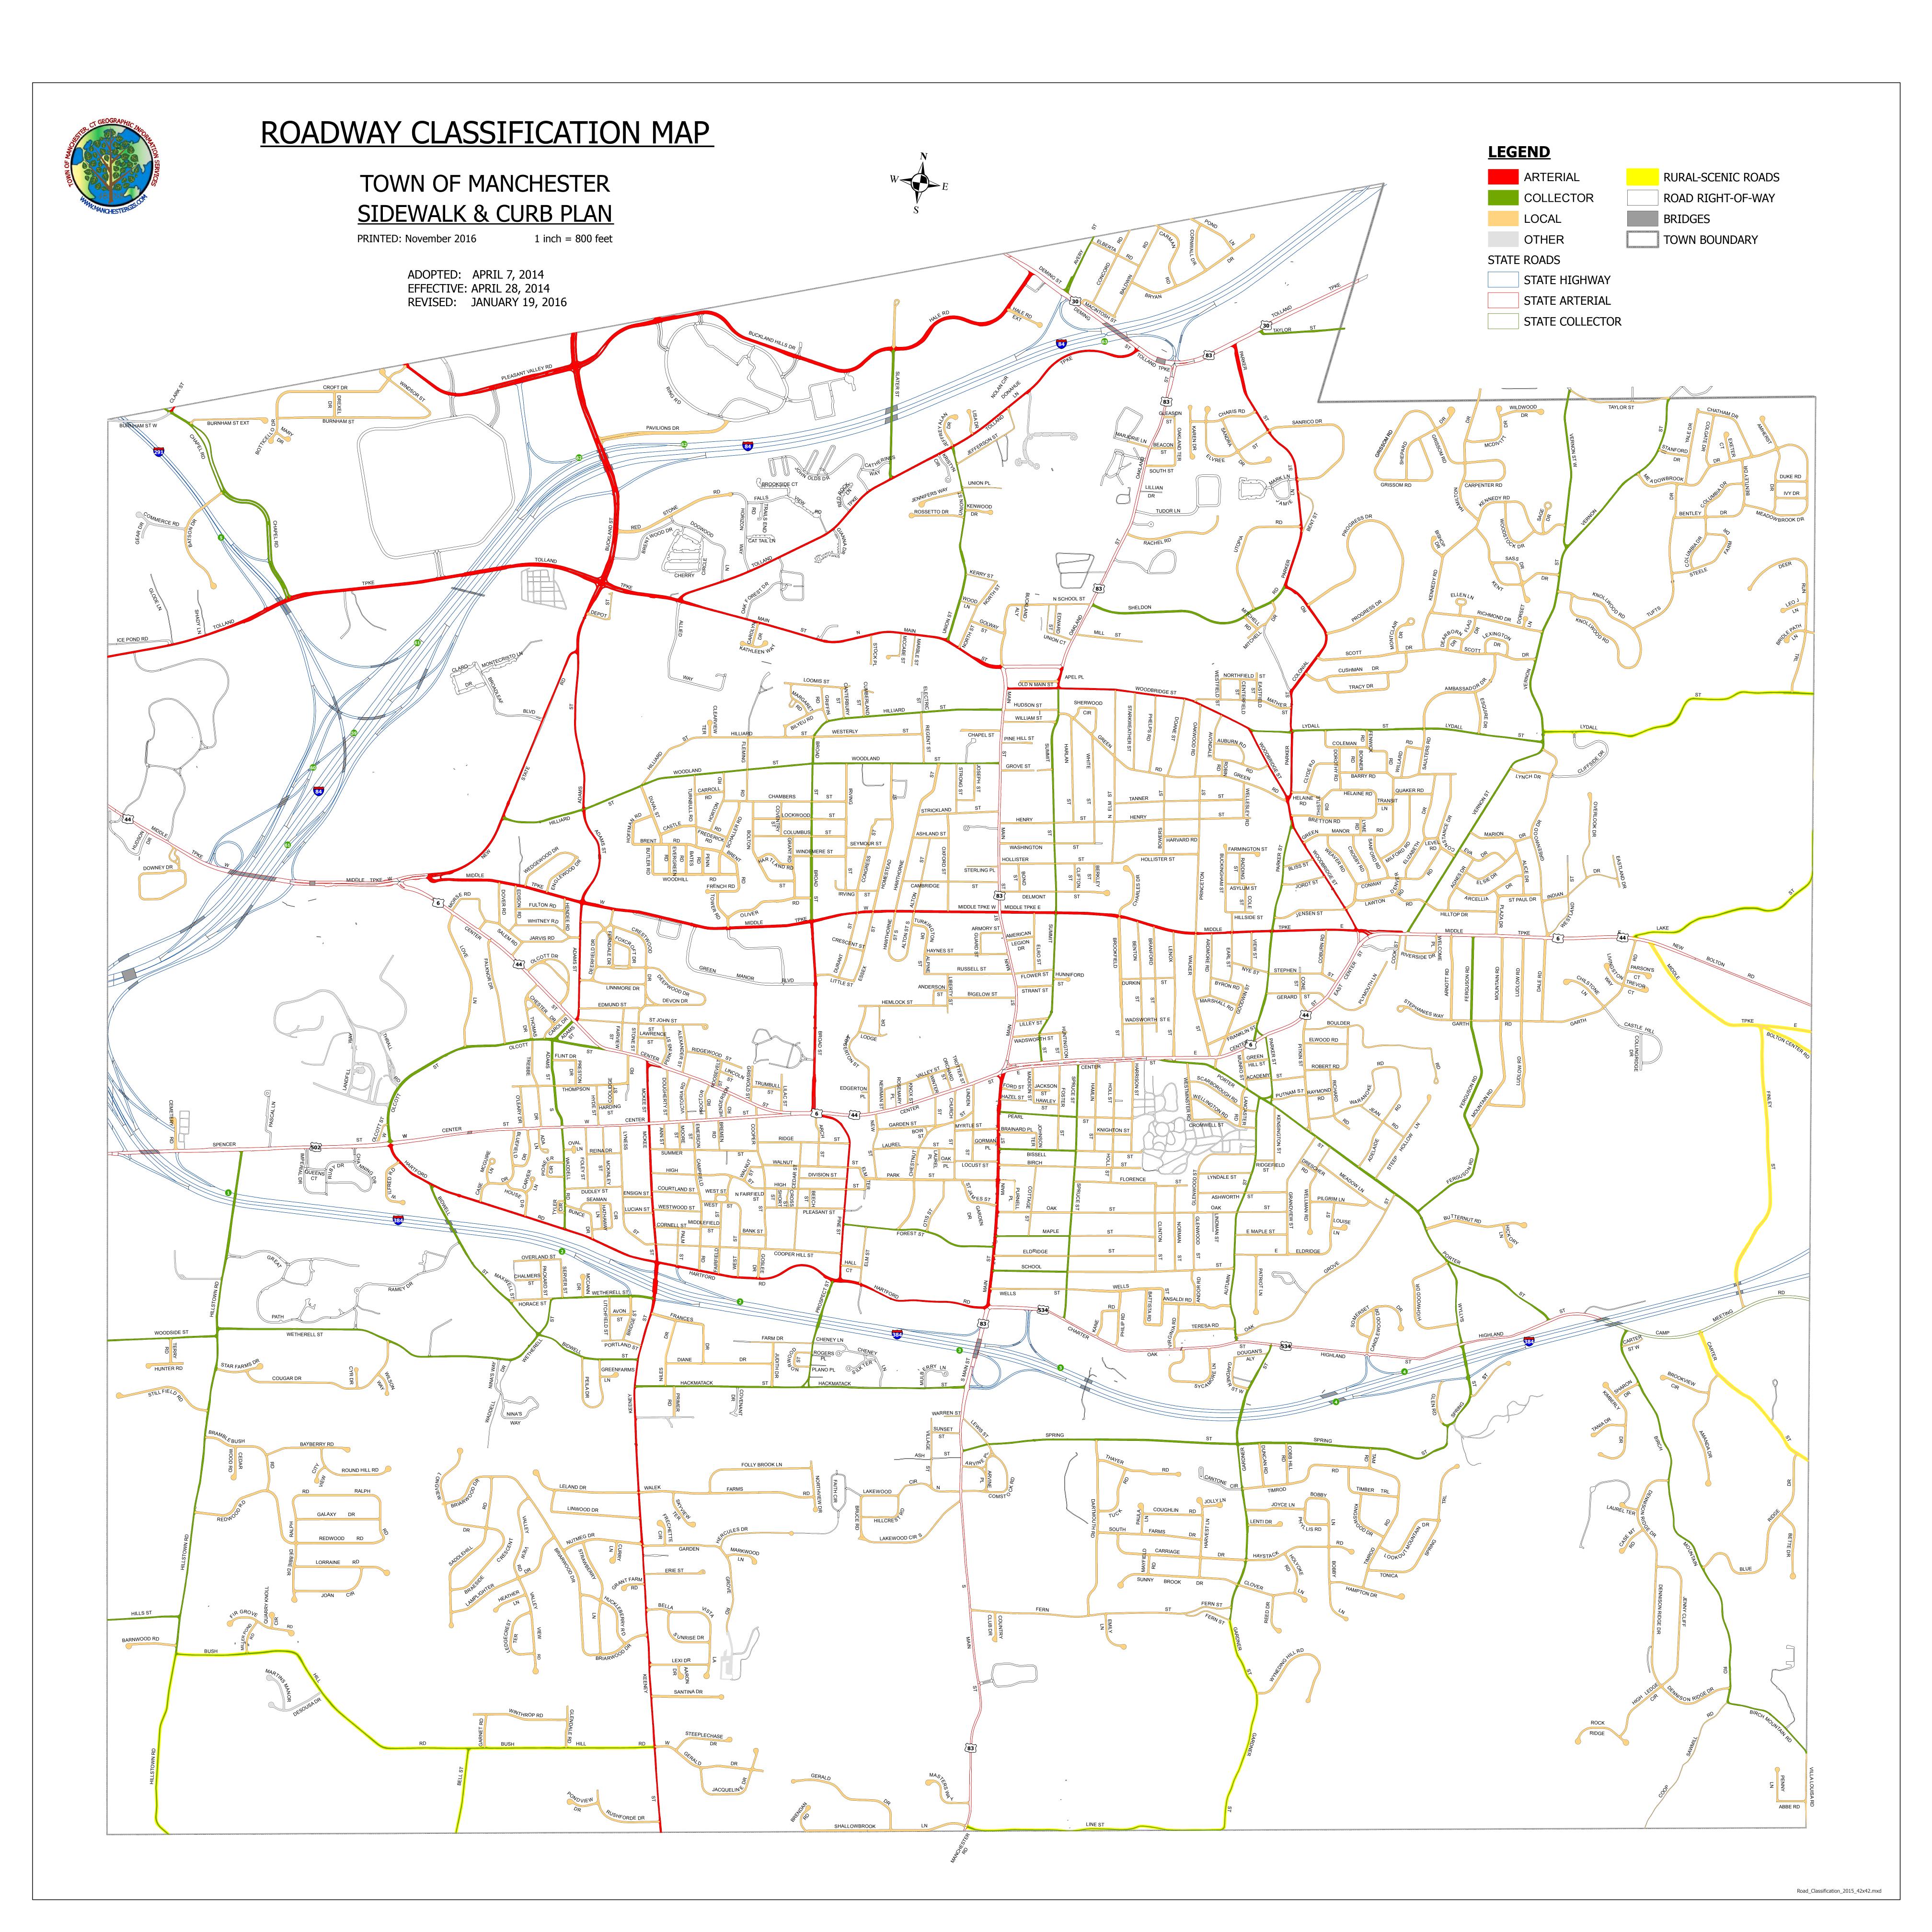TOWN OF MANCHESTER PLANNING AND ECONOMIC DEVELOPMENT DEPARTMENT

TO: Planning & Zoning Commission

FROM: David Laiuppa, Environmental Planner/Wetlands Agent

DATE: March 27, 2024

RE: Town of Manchester Public Works Dept. – 30 Charter Oak Street

Inland Wetlands Permit Determination of Significance (IWP-0003-2024)

Introduction

The applicant is requesting approval of a wetland permit for the expansion of Charter Oak Park with the construction of a 390' x 240' synthetic turf playing field, a combination skate park/pump track and associated 74-stall parking lot at 30 Charter Oak Street. A portion of this project is in the upland review area of Hop Brook.

Project Description

The Town of Manchester Department of Public Works proposes to expand Charter Oak Park with the construction of a 390' x 240' synthetic turf playing field, a combination skate park/pump track and associated 74-stall parking lot at 30 Charter Oak Street. 30 Charter Oak Street is a Town-owned parcel that is bordered to the north by Charter Oak Street (State Route 534), to the east by the Interstate 384 Exit 3 Westbound ramps, to the south by the Charter Oak Greenway and Hop Brook and to the west by South Main Street (State Route 83). The 7.4 acre site is zoned Residence AA and currently used for municipal soccer fields. There is no parking on site. The Charter Oak Greenway, a 10' wide bituminous concrete shared use path, runs southerly and westerly of the existing fields.

The proposed project includes the following:

- Construction of a 390' x 240' synthetic turf playing field;
- Construction of turf field amenities, including bleachers, scoreboard, benches, etc.;
- Construction of a 74-stall parking lot with new curb cut on Charter Oak Street;
- Construction of a 42' x 16' concrete block utility and storage building;
- Installation of site and field LED lighting;
- Construction of a combination skate park/pump track.

Inland Wetlands Permit

It is estimated that the project will disturb approximately 4.2 acres of the 7.4-acre site. No work is proposed within the wetlands. Approximately 0.77 acres of disturbance is proposed within the 100' regulated upland review area.

Control measures will include installation of silt fence along the southern project limits downgrade of the proposed construction. Further installation of silt fencing and/or silt sacks will be as needed at the direction of the Engineer. All sedimentation and erosion control devices will be installed in accordance with the 2002 Connecticut Guidelines for Soil Erosion and Sediment Control prior to the start of construction and maintained or replaced by the Contractor.

The total proposed area of **direct disturbance within the upland review area is 0.77 acres**. [NOTE: This number is provided by the applicant.]

Determination of Significance

The Inland Wetlands Agency is required to make a determination of the significance of the impact of the proposed activities on the wetlands, watercourses, and/or water bodies. In making its determination, the Agency should be guided by the definition of "Significant Impact Activity" as found in the Inland Wetlands and Watercourses Regulations, which means any activity including, but not limited to, the following activities which may have a major effect or significant impact:

- a. Any activity involving a deposition or removal of material which will or may have a substantial effect on the wetland or watercourse or on wetlands or watercourses outside the area for which the activity is proposed; or
- b. Any activity which substantially changes the natural channel or may inhibit the natural dynamics of a watercourse system; or
- c. Any activity which substantially diminishes the natural capacity of an inland wetland or watercourse to support aquatic, plant or animal life, prevent flooding, supply water, assimilate waste, facilitate drainage, provide recreation or open space or perform other functions; or
- d. Any activity which is likely to cause or has the potential to cause substantial turbidity, siltation or sedimentation in a wetland or watercourse; or
- e. Any activity which causes a substantial diminution of flow of a natural watercourse or groundwater levels of the wetland or watercourse; or
- f. Any activity which is likely to cause or has the potential to cause pollution of a wetland or watercourse; or
- g. Any activity which damages or destroys unique wetland or watercourse areas or such areas having demonstrable scientific or educational value.

If the Agency finds the proposed activity may have a significant impact on the wetlands, a public hearing is required. A public hearing shall also be held if either 1) a petition signed by at least

twenty-five persons who are eighteen years of age or older and who reside in the municipality is filed no later than fourteen days after the receipt of such application, or 2) the Agency finds that a public hearing regarding such application would be in the public interest. Should the Agency find that none of the above circumstances applies to the application, then no public hearing is required.

Staff Review

Town staff is still reviewing the materials submitted with this application. Any outstanding comments will be provided to the Agency during the final decision meeting.

dl/kw

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Attach.

Town of Manchester, CT



Geographic Information Systems **30 CHARTER OAK STREET**

Legend

Overlay Zone

Zoning

AA - Residence AA

B3 - Business III

CBD - Central Business District

H - Historic

NB - Neighborhood Business

PRD - Planned Residence Development

RB - Residence B

RR - Rural Residence

DISCLAIMER:


DISCLAIMER:
The Town of Manchester, CT assumes no legal responsibility for the information contained in this map. This map is provided "AS IS" without warranty of any kind.
NOTES:

NOTES: Planimetric and topographic information were compiled by stereo photogrammetric methods from photography dated April 24, 1999 in accordance with ASPR accuracy standards for 1"#40" 12721 as accordance with ASPK accuracy standards for 1"=40" large scale Class I maps. Real property compiled from recorded deeds, subdivision plans and other public records. Utility networks compiled from record plans, as-builts and/or field survey data. Aerial photography dated April 24, 1999.

0 50100 200 300 400

1 inch = 300 ft

Date: 3/28/2024

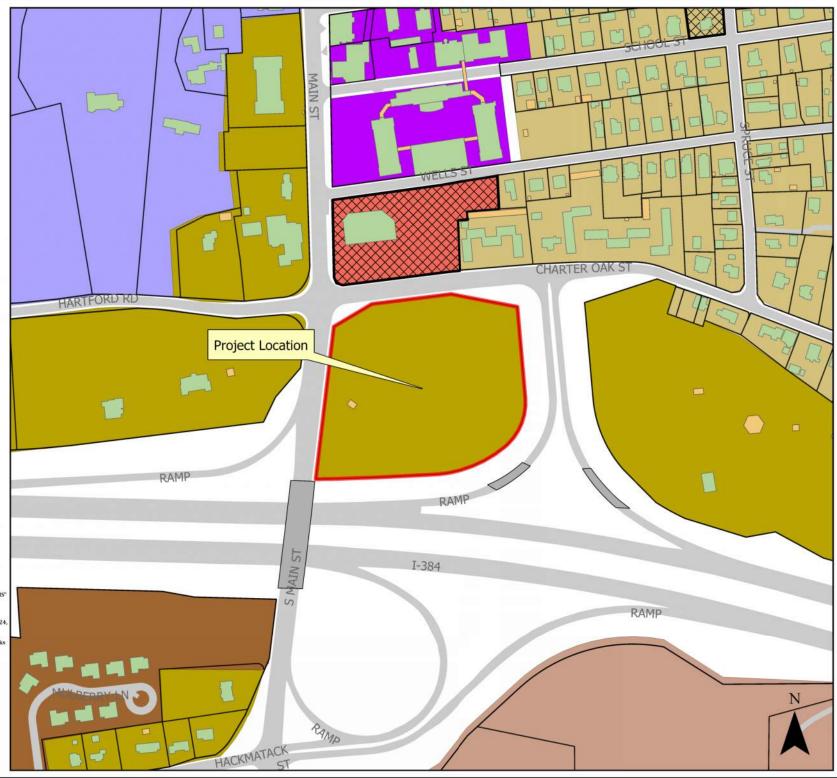

PROJECT NARRATIVE

FOR

CHARTER OAK PARK WEST

March 15, 2024

by

Jeff LaMalva, P.E., Town Engineer



Town of Manchester Department of Public Works Engineering Division

INLAND WETLANDS AND EROSION & SEDIMENTATION CONTROL PERMIT: APPLICATION SUPPLEMENT

PROPOSED PROJECT INFORMATION:

The Town of Manchester Department of Public Works proposes to expand Charter Oak Park with the construction of a 390' x 240' synthetic turf playing field, a combination skate park/pump track and associated 74-stall parking lot at 30 Charter Oak Street.

EXISTING CONDITIONS:

30 Charter Oak Street is a Town owned parcel that is bordered to the north by Charter Oak Street (State Route 534), to the east by the Interstate 384 Exit 3 Westbound ramps, to the south by the Chater Oak Greenway and Hop Brook and to the west by South Main Street (State Route 83). The 7.4 acre site is zoned Residence AA and currently used for municipal soccer fields. There is no parking on site. The Charter Oak Greenway, a 10' wide bituminous concrete shared use path, runs southerly and westerly of the existing fields. The site is not located within an aquifer protection area. A preliminary screening through the Natural Diversity Database (NDDB) indicated no critical habitats have been documented in close proximity to the site.

SCOPE OF WORK:

The project primarily includes the following work:

- Construction of a 390' x 240' synthetic turf playing field;
- Construction of turf field amenities, including bleachers, scoreboard, benches, etc.;
- Construction of a 74-stall parking lot with new curb cut on Charter Oak Street;
- Construction of a 42' x 16' concrete block utility and storage building;
- Installation of site and field LED lighting;
- Construction of a combination skate park/pump track;

TRAFFIC STATEMENT:

The project is not expected to have a significant impact on traffic. The proposed curb cut has been reviewed and approved by the State of Connecticut Department of Transportation.

UTILITY STATEMENT:

The project includes the installation of a new electric service and a new water service coming off of Charter Oak Street. There is an existing sanitary sewer main that traverses the site. A new sanitary sewer service for the utility building is proposed that will connect to the existing main. Other than the resetting of manhole frames to grade, there are no expected impacts to the existing utility.

PLANS:

The following plan is included as part of the submission:

1. Charter Oak Park West, Inland Wetlands and Erosion and Sedimentation Control Permit, dated March 2024, prepared by Town of Manchester Public Works Department Engineering Division

EROSION & SEDIMENTATION CONTROL:

Control measures will include installation of silt fence along the southern project limits downgrade of the proposed construction. Further installation of silt fencing and/or silt sacks will be as needed at the direction of the Engineer. All sedimentation and erosion control devices will be installed in accordance with the 2002 Connecticut Guidelines for Soil Erosion and Sediment Control prior to the start of construction and maintained or replaced by the Contractor.

March 15, 2024 PAGE 1 OF 2

DISTRUBANCES:

The overall total site disturbance is approximately 4.2 acres. Approximately 33,500 sf, or 0.77 acres of the overall disturbance is located within the 100' upland review area. No work is proposed within the wetlands.


STORMWATER MANAGEMENT:

The proposed project will increase the site's impervious area coverage by approximately 0.75 acres. The project includes the construction of a hydrodynamic separator at the southwest corner of the site designed to treat the runoff from the parking lot and synthetic turf field before discharging into an existing storm drainage outfall pipe that discharges to Hop Brook. Per the Town's Public Improvement Standards, stormwater detention is not required due to the close proximity to the watercourse.

PROJECT SCHEDULE:

The project will be constructed in two phases. The first phase, which includes the synthetic turf field, utility building and parking lot is anticipated to commence this summer and take approximately six months to complete. The second phase, which includes the construction of the skate park/pump track will be completed in 2025.


March 15, 2024 PAGE 2 OF 2

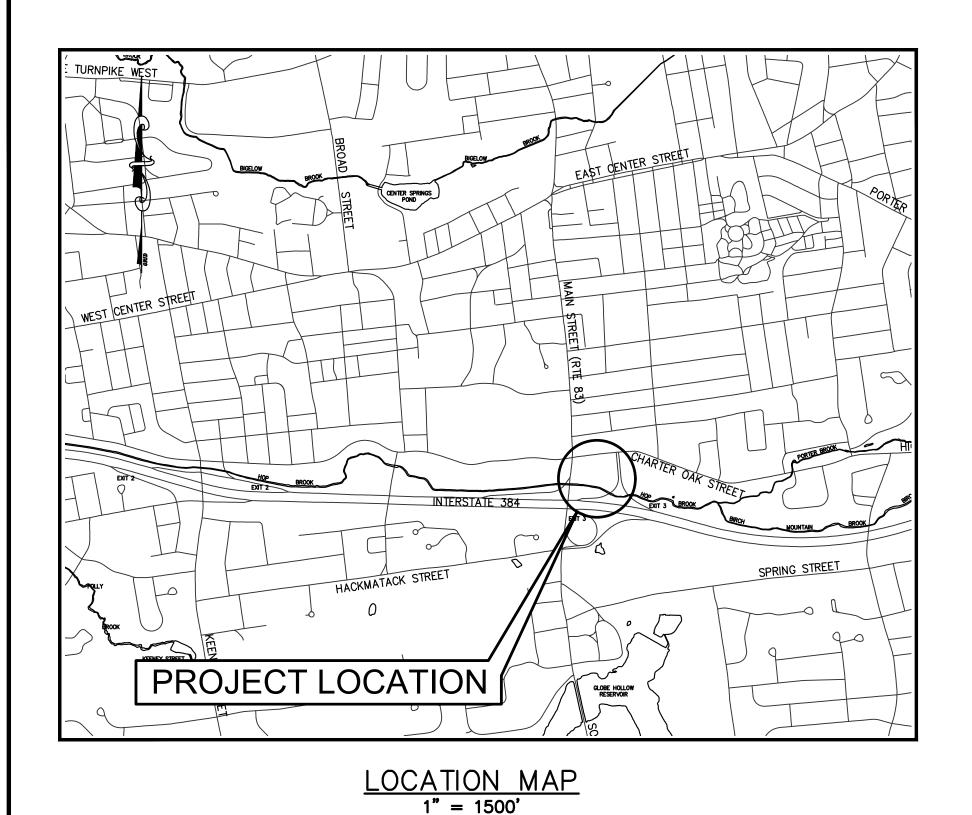

TOWN OF MANCHESTER

PUBLIC WORKS DEPARTMENT ENGINEERING DIVISION



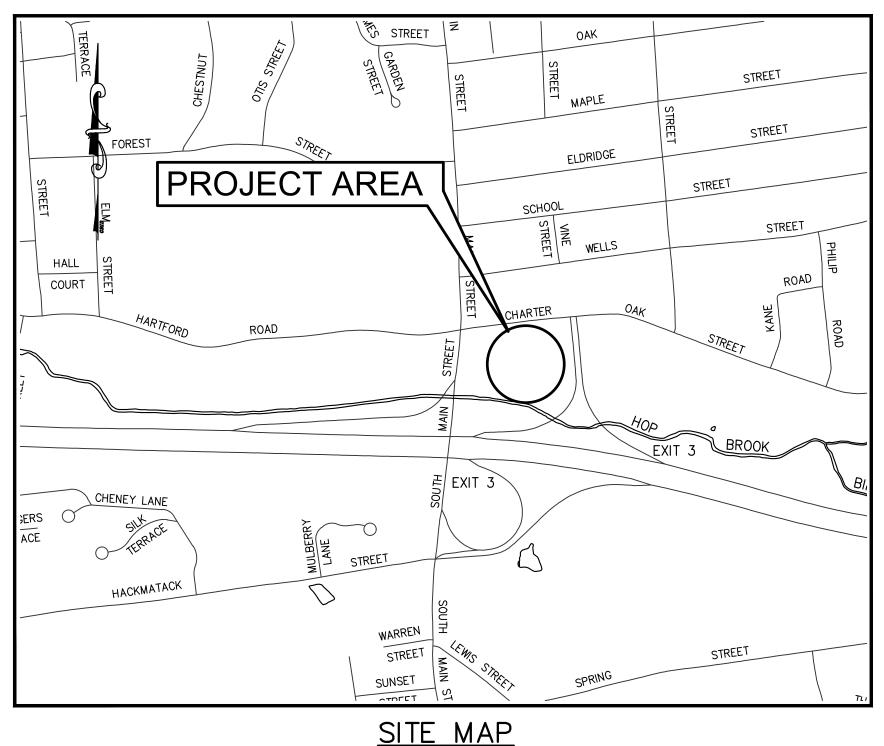

PARK IMPROVEMENTS CHARTER OAK PARK WEST

INLAND WETLANDS PERMIT EROSION AND SEDIMENTATION CONTROL PERMIT MARCH 2024

DESIGN STANDARD: TOWN OF MANCHESTER PUBLIC IMPROVEMENT STANDARDS, EFFECTIVE DATE OCTOBER 31, 2020,

AS AMENDED

DATUMS: HORIZONTAL DATUM: TOWN OF MANCHESTER CONTROL NETWORK

(NAD83 AS ESTABLISHED IN 1998)

VERTICAL DATUM: TOWN OF MANCHESTER CONTROL NETWORK

(NAVD88 USING GEOID 96)

STANDARD

SPECIFICATIONS: SEE CONTRACT DOCUMENTS


DESIGN SCALES:


PLAN: 1'' = 30'OTHER SCALES AS NOTED

LIST OF DRAWINGS SHEET NO. DESCRIPTION 1 COVER SHEET 2 SITE LAYOUT PLAN 3 UTILITY PLAN GRADING PLAN PAVEMENT MARKINGS AND SIGNING PLAN TURF ESTABLISHMENT AND EROSION CONTROL PLAN 7 | FIELD MARKING PLAN 8 UTILITY BUILDING PLAN 9-15 DETAILS 16 EXISTING CONDITIONS PLAN

DESIGNED BY: TOWN OF MANCHESTER ENGINEERING DIVISION

JEFF LAMALVA TOWN ENGINEER P.E. NO. 20967

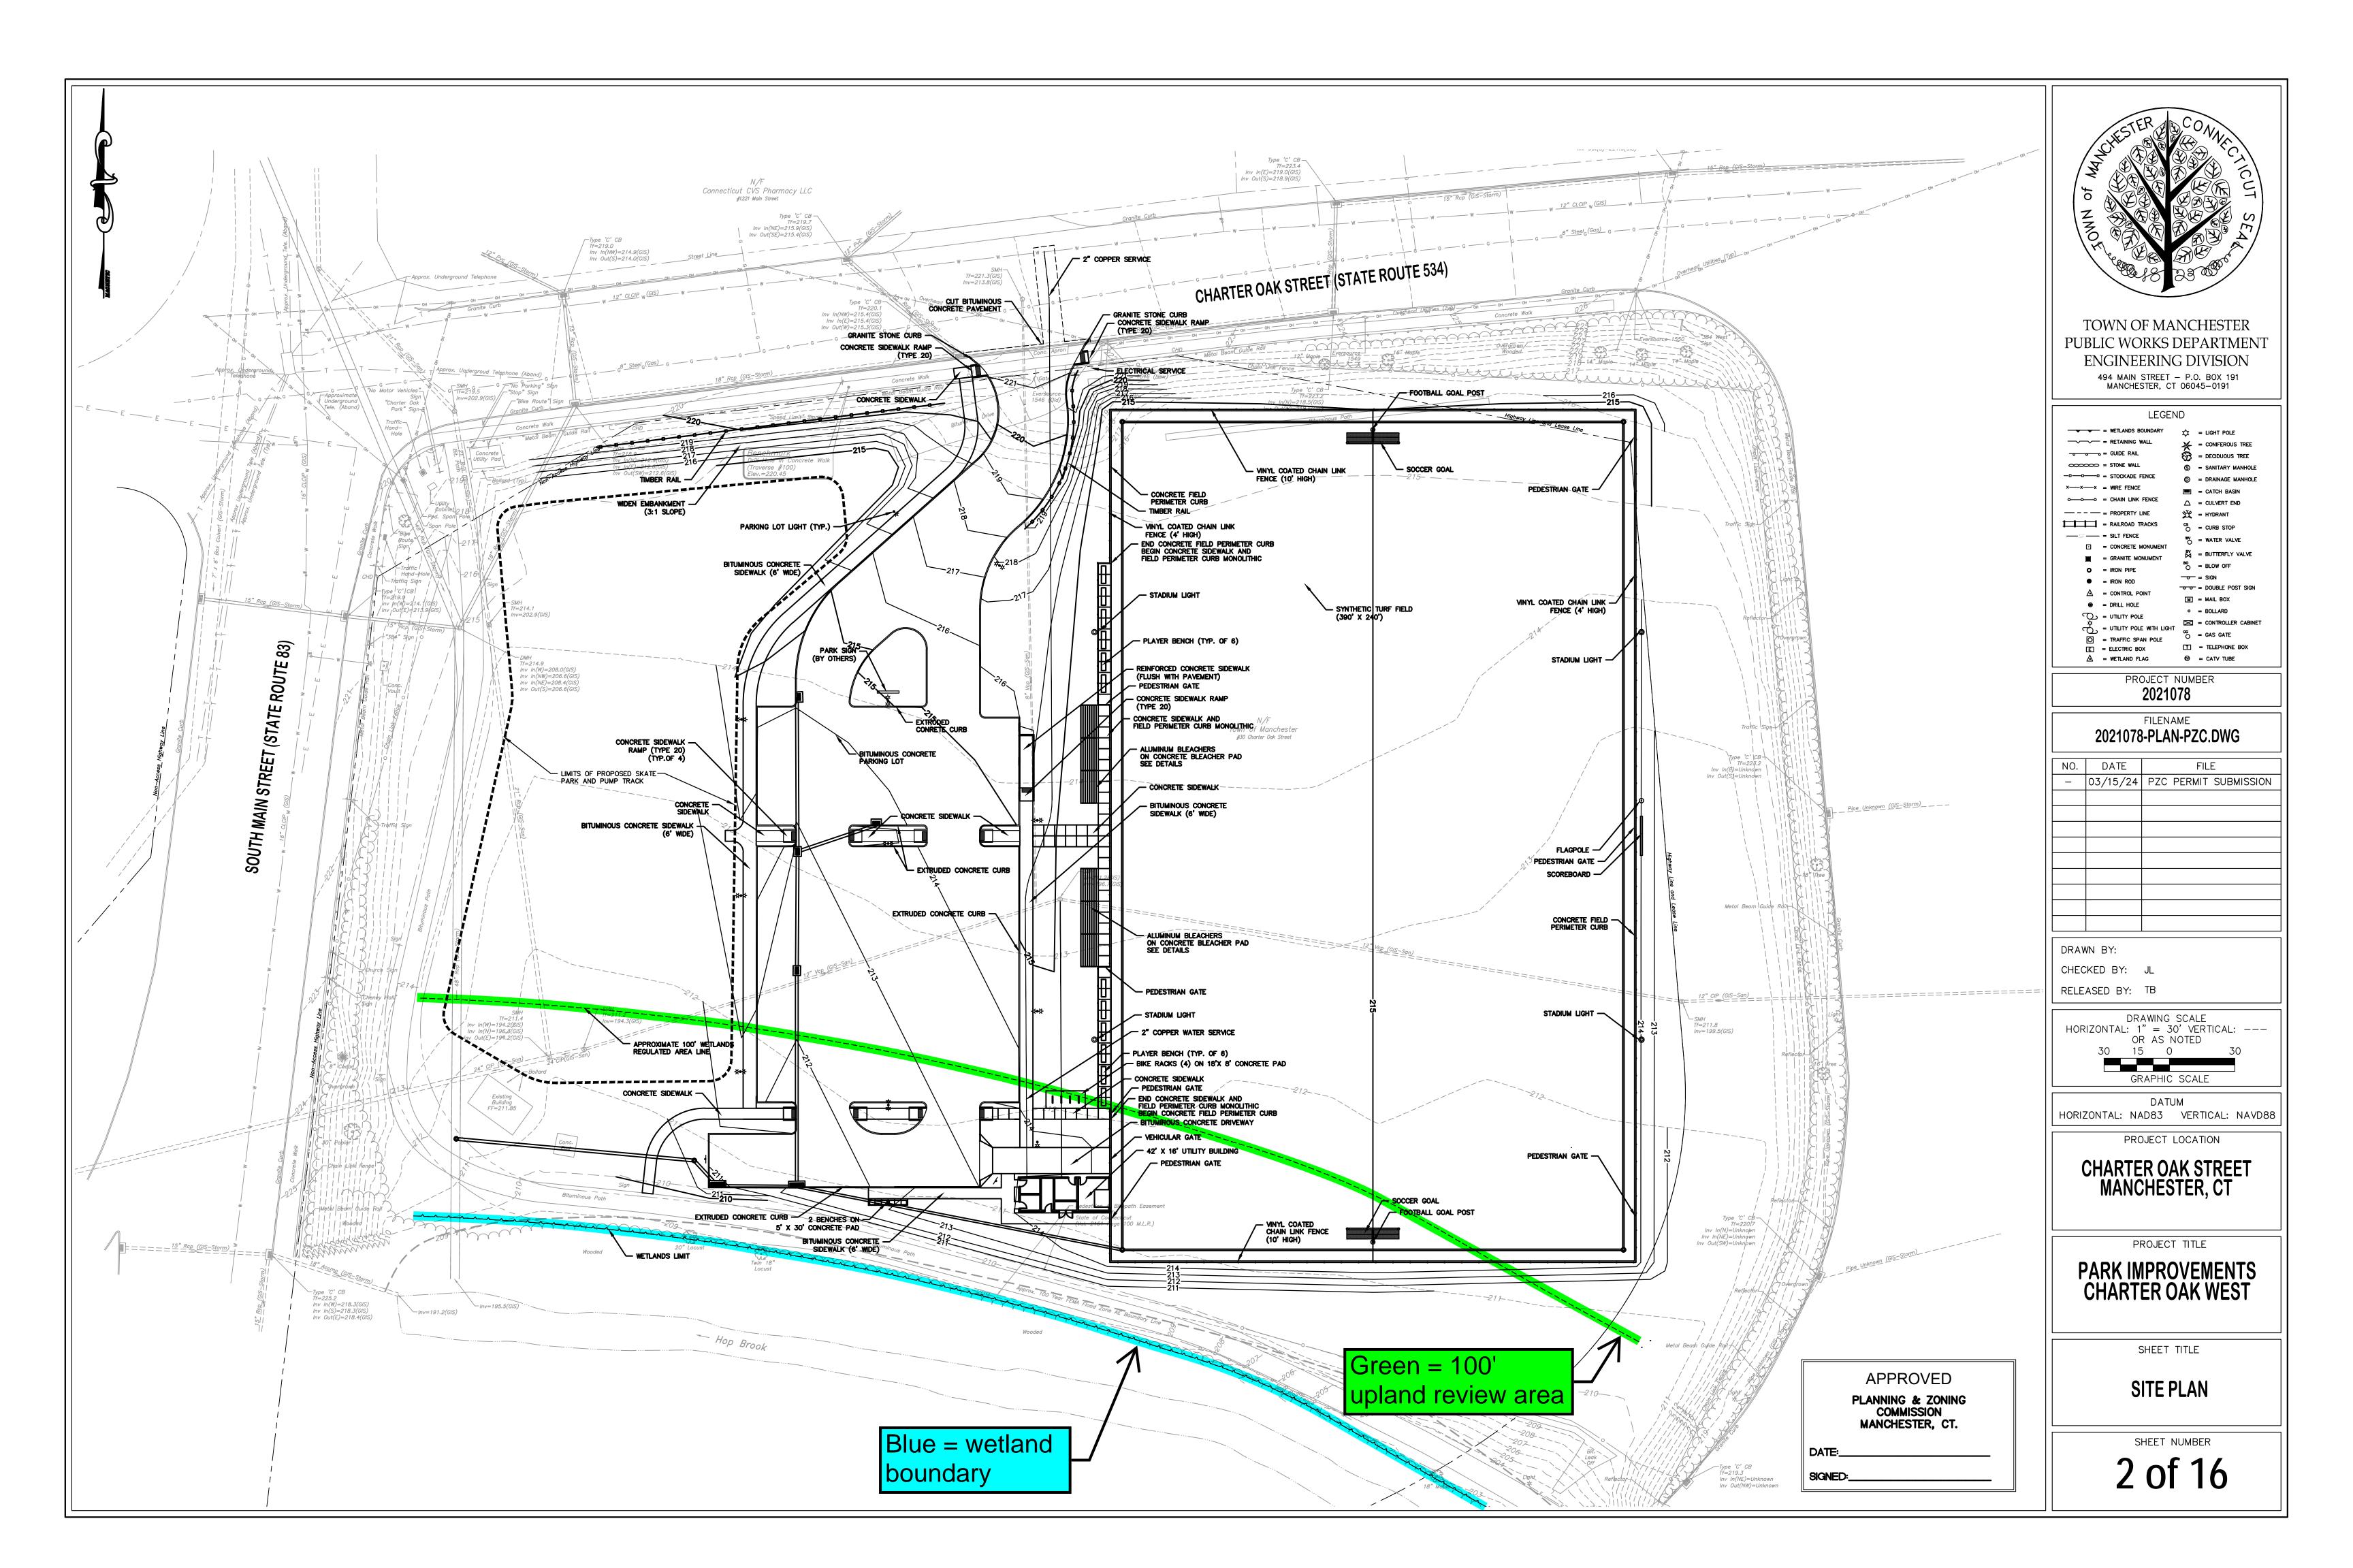

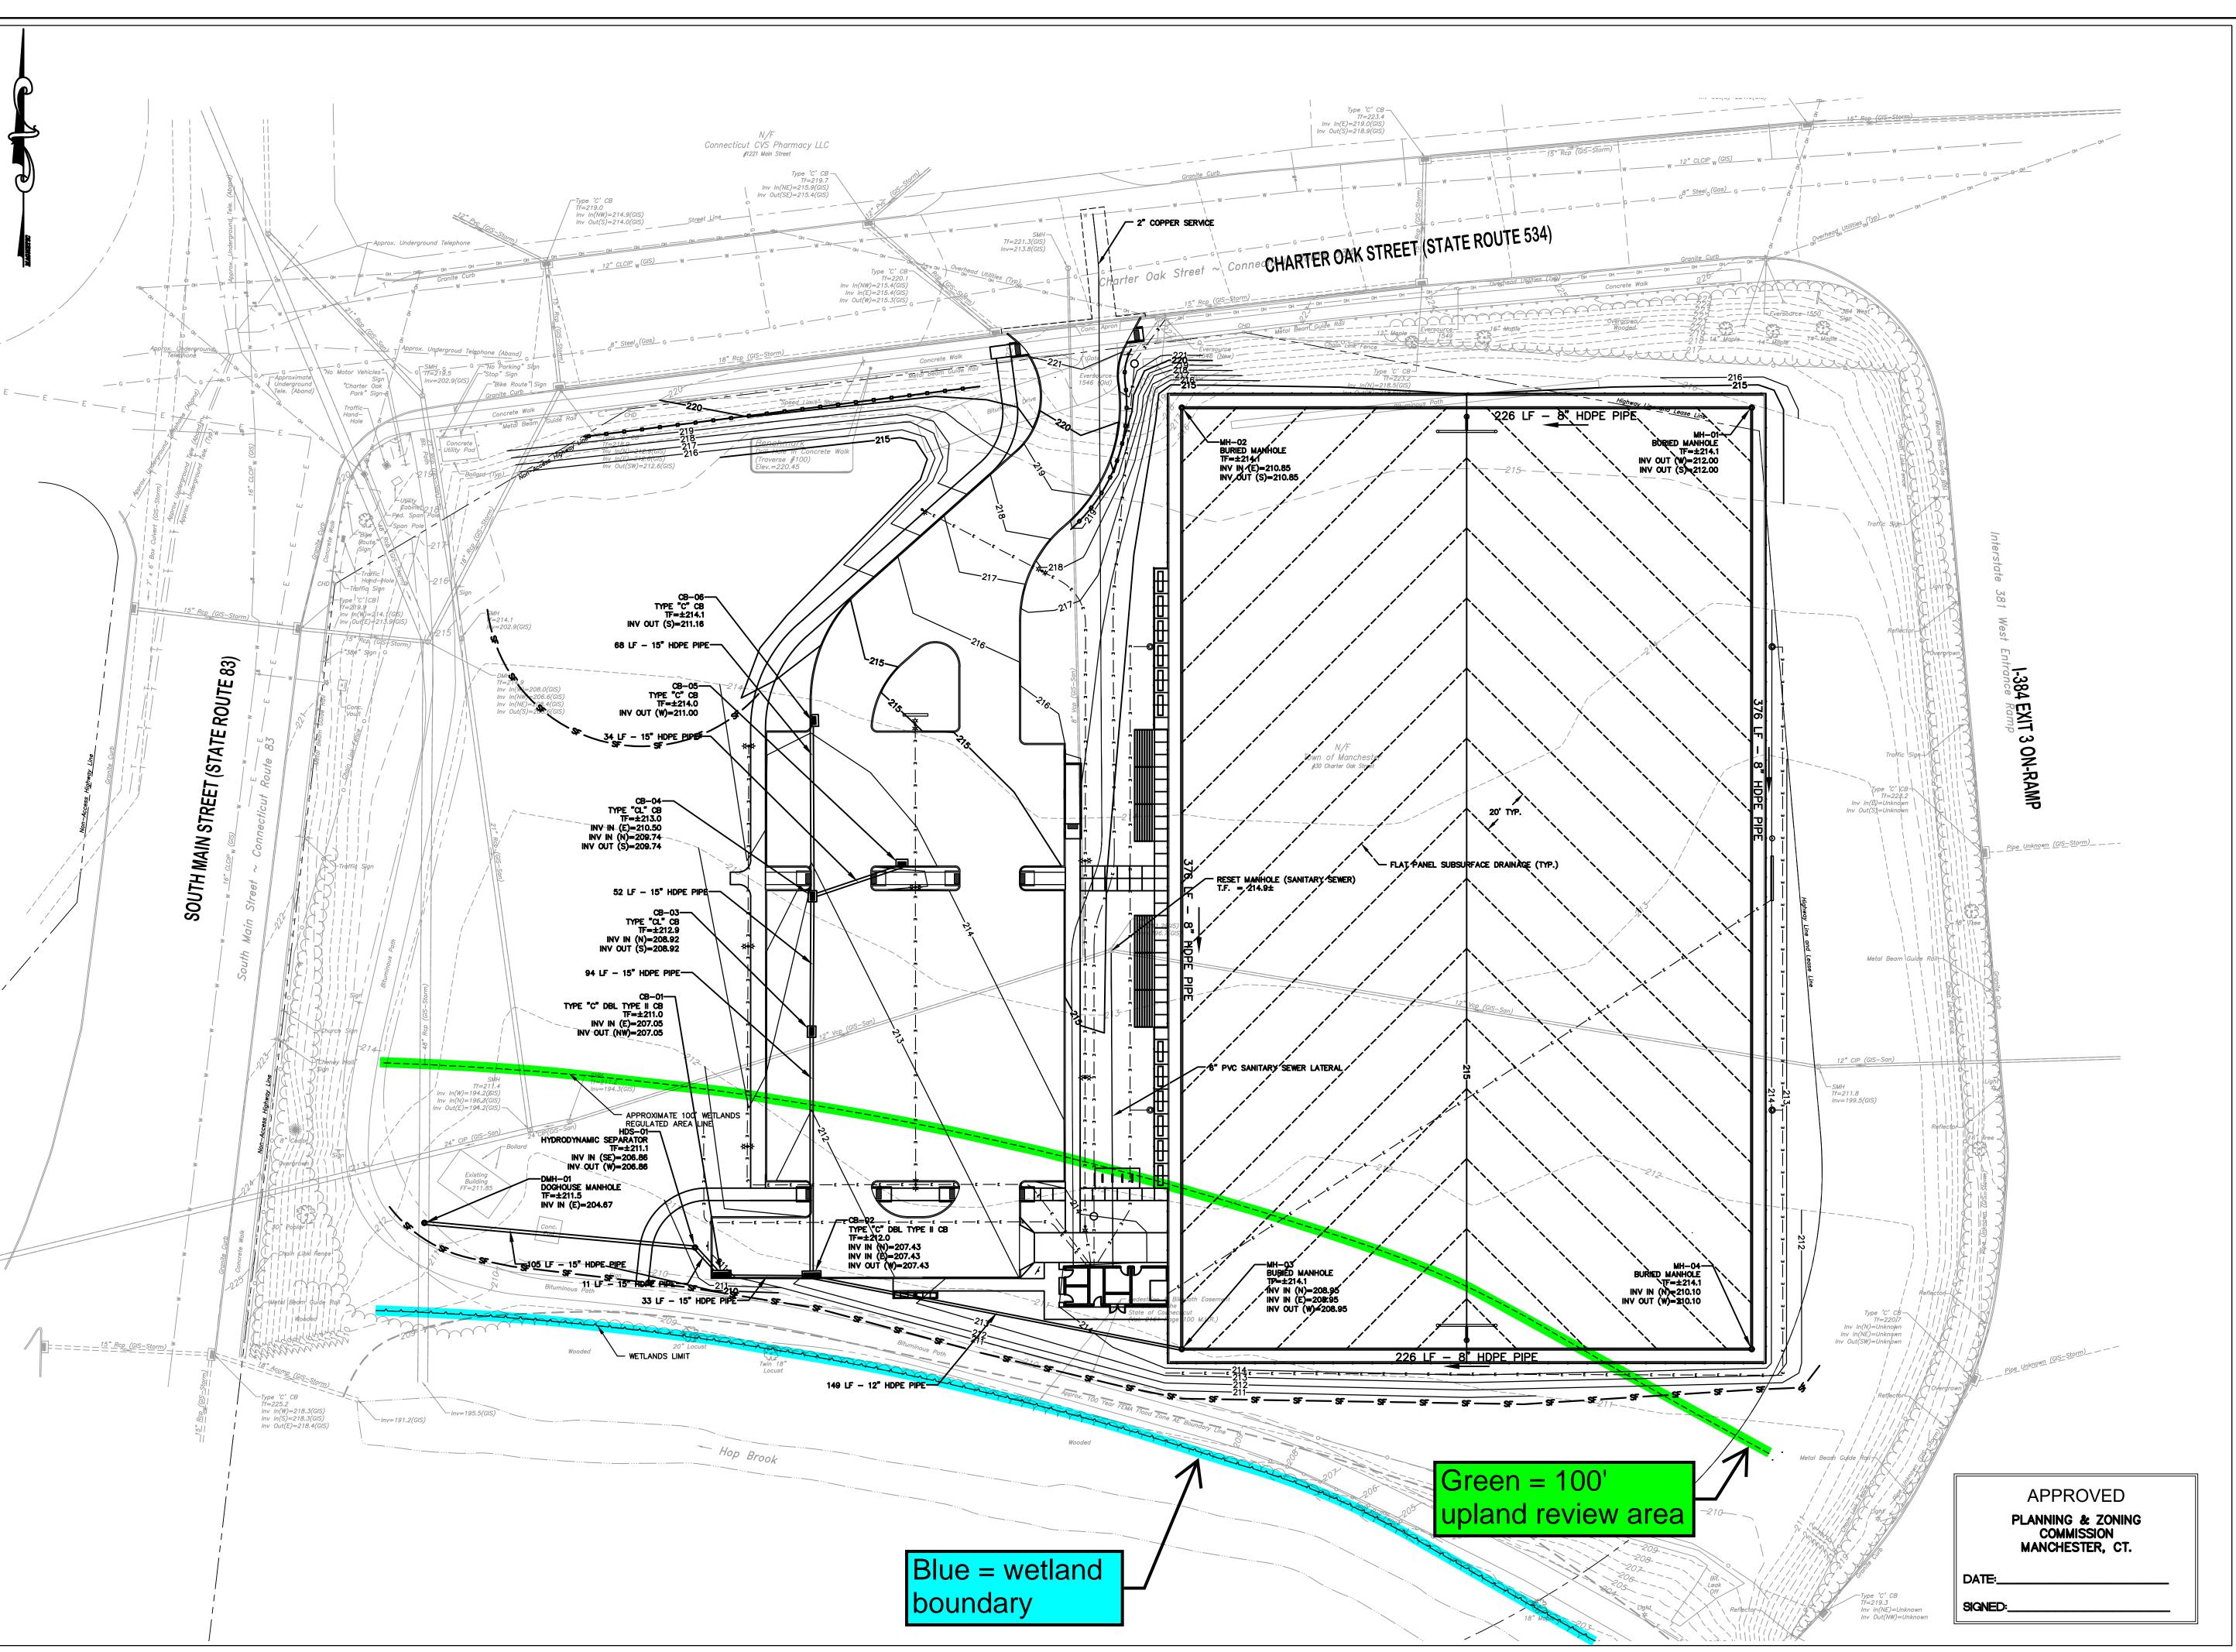



TOWN OF MANCHESTER
PUBLIC WORKS DEPARTMENT
ENGINEERING DIVISION

494 MAIN STREET - P.O. BOX 191
MANCHESTER, CT 06045-0191

LEGEND

= WETLANDS BOUNDARY

= RETAINING WALL

= CONIFEROU

= GUIDE RAIL

= DECIDUOUS

= SANITARY |

= DATION BOON

= CONIFEROU

= CONIFEROU

= DECIDUOUS

= SANITARY |

= DATION BOON

= CONIFEROU

= CATCH BAS

= CATCH BAS

= CULVERT E

= HYDRANT

S = CURB STOF

W = WATER VAL

BV = BUTTERFLY

BO = BLOW OFF

■ SIGN

O = IRON PIPE

■ IRON ROD

A = CONTROL POINT

■ DRILL HOLE

□ UTILITY POLE WITH LIGHT

O = GAS GATE

BO = BLOW OFF

□ SIGN

□ DOUBLE POST SIGN

□ GO = GAS GATE

E = ELECTRIC BOX

A = WETLAND FLAG

□ = TELEPHONE BOX

O = CATV TUBE

PROJECT NUMBER

FILENAME 2021078-PLAN-PZC.DWG

2021078

NO.	DATE	FILE
_	03/15/24	PZC PERMIT SUBMISSION

DRAWN BY:
CHECKED BY: JL
RELEASED BY: TB

DRAWING SCALE
HORIZONTAL: 1" = 30' VERTICAL: --OR AS NOTED
30 15 0 30

GRAPHIC SCALE

DATUM
HORIZONTAL: NAD83 VERTICAL: NAVD88

PROJECT LOCATION

CHARTER OAK STREET MANCHESTER, CT


PROJECT TITLE

PARK IMPROVEMENTS CHARTER OAK WEST

SHEET TITLE

UTILITY PLAN

SHEET NUMBER

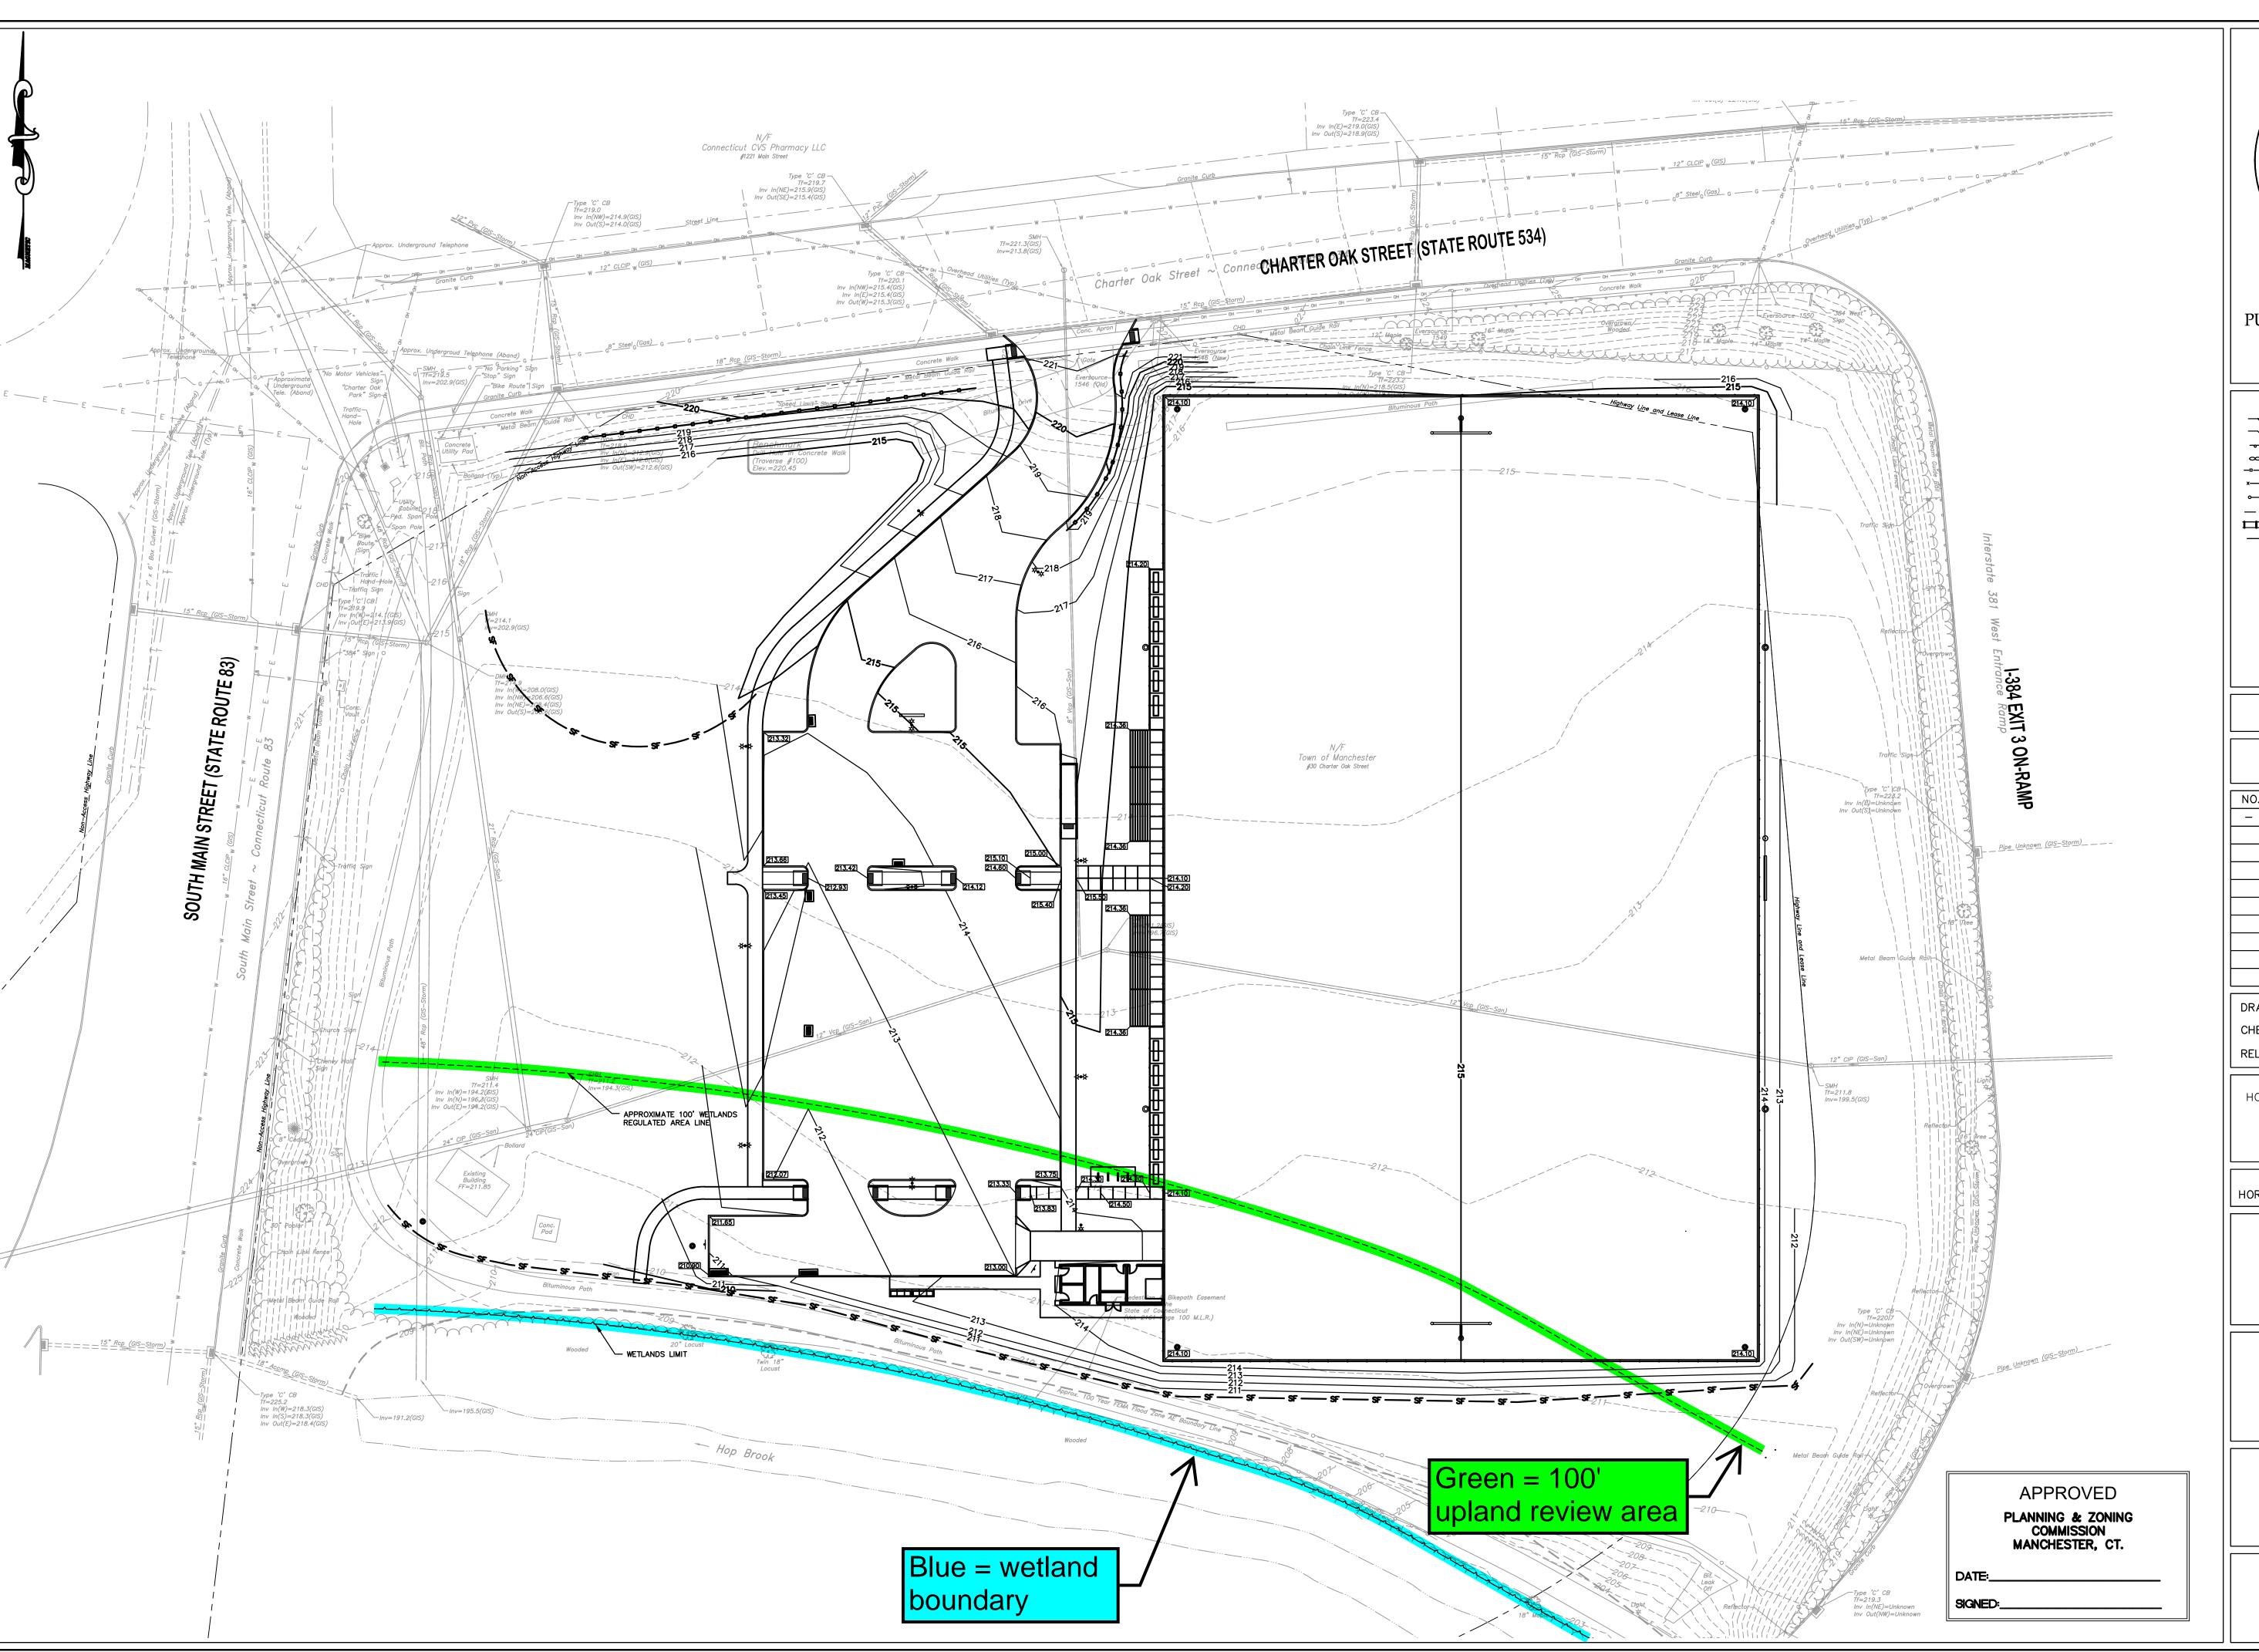



TOWN OF MANCHESTER
PUBLIC WORKS DEPARTMENT
ENGINEERING DIVISION

494 MAIN STREET - P.O. BOX 191
MANCHESTER, CT 06045-0191

LEGEND

= RETAINING WALL

= CONIFEROUS TREE

= DECIDUOUS TREE

= STONE WALL

= STOCKADE FENCE

= DRAINAGE MANHO

= CATCH BASIN

= CULVERT END

= HYDRANT

= RAILROAD TRACKS

= CURB STOP

WY = WATER VALVE

WY = BUTTERFLY VALVE

WY = BUTTERFLY VALVE

= SIGN

= IRON PIPE

= IRON ROD

= IRON ROD

= DOUBLE POST SIGN

= UTILITY POLE WITH LIGHT

= TRAFFIC SPAN POLE

= ELECTRIC BOX

= WETLAND FLAG

= CONIFOLIST TREE

= DECIDUOUS TREE

= CATCH BASIN

= DECIDUOUS TREE

= CATCH BASIN

= DECIDUOUS TREE

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= DECIDUOUS TREE

= CATCH BASIN

= DECIDUOUS

= DOUBLE POST SIGN

= DECIDUOU

PROJECT NUMBER 2021078

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DRAWN BY:
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DRAWING SCALE
HORIZONTAL: 1" = 30' VERTICAL: --OR AS NOTED
30 15 0 30
GRAPHIC SCALE

DATUM
HORIZONTAL: NAD83 VERTICAL: NAVD88

PROJECT LOCATION

CHARTER OAK STREET MANCHESTER, CT


PROJECT TITLE

PARK IMPROVEMENTS CHARTER OAK WEST

SHEET TITLE

GRADING PLAN

SHEET NUMBER

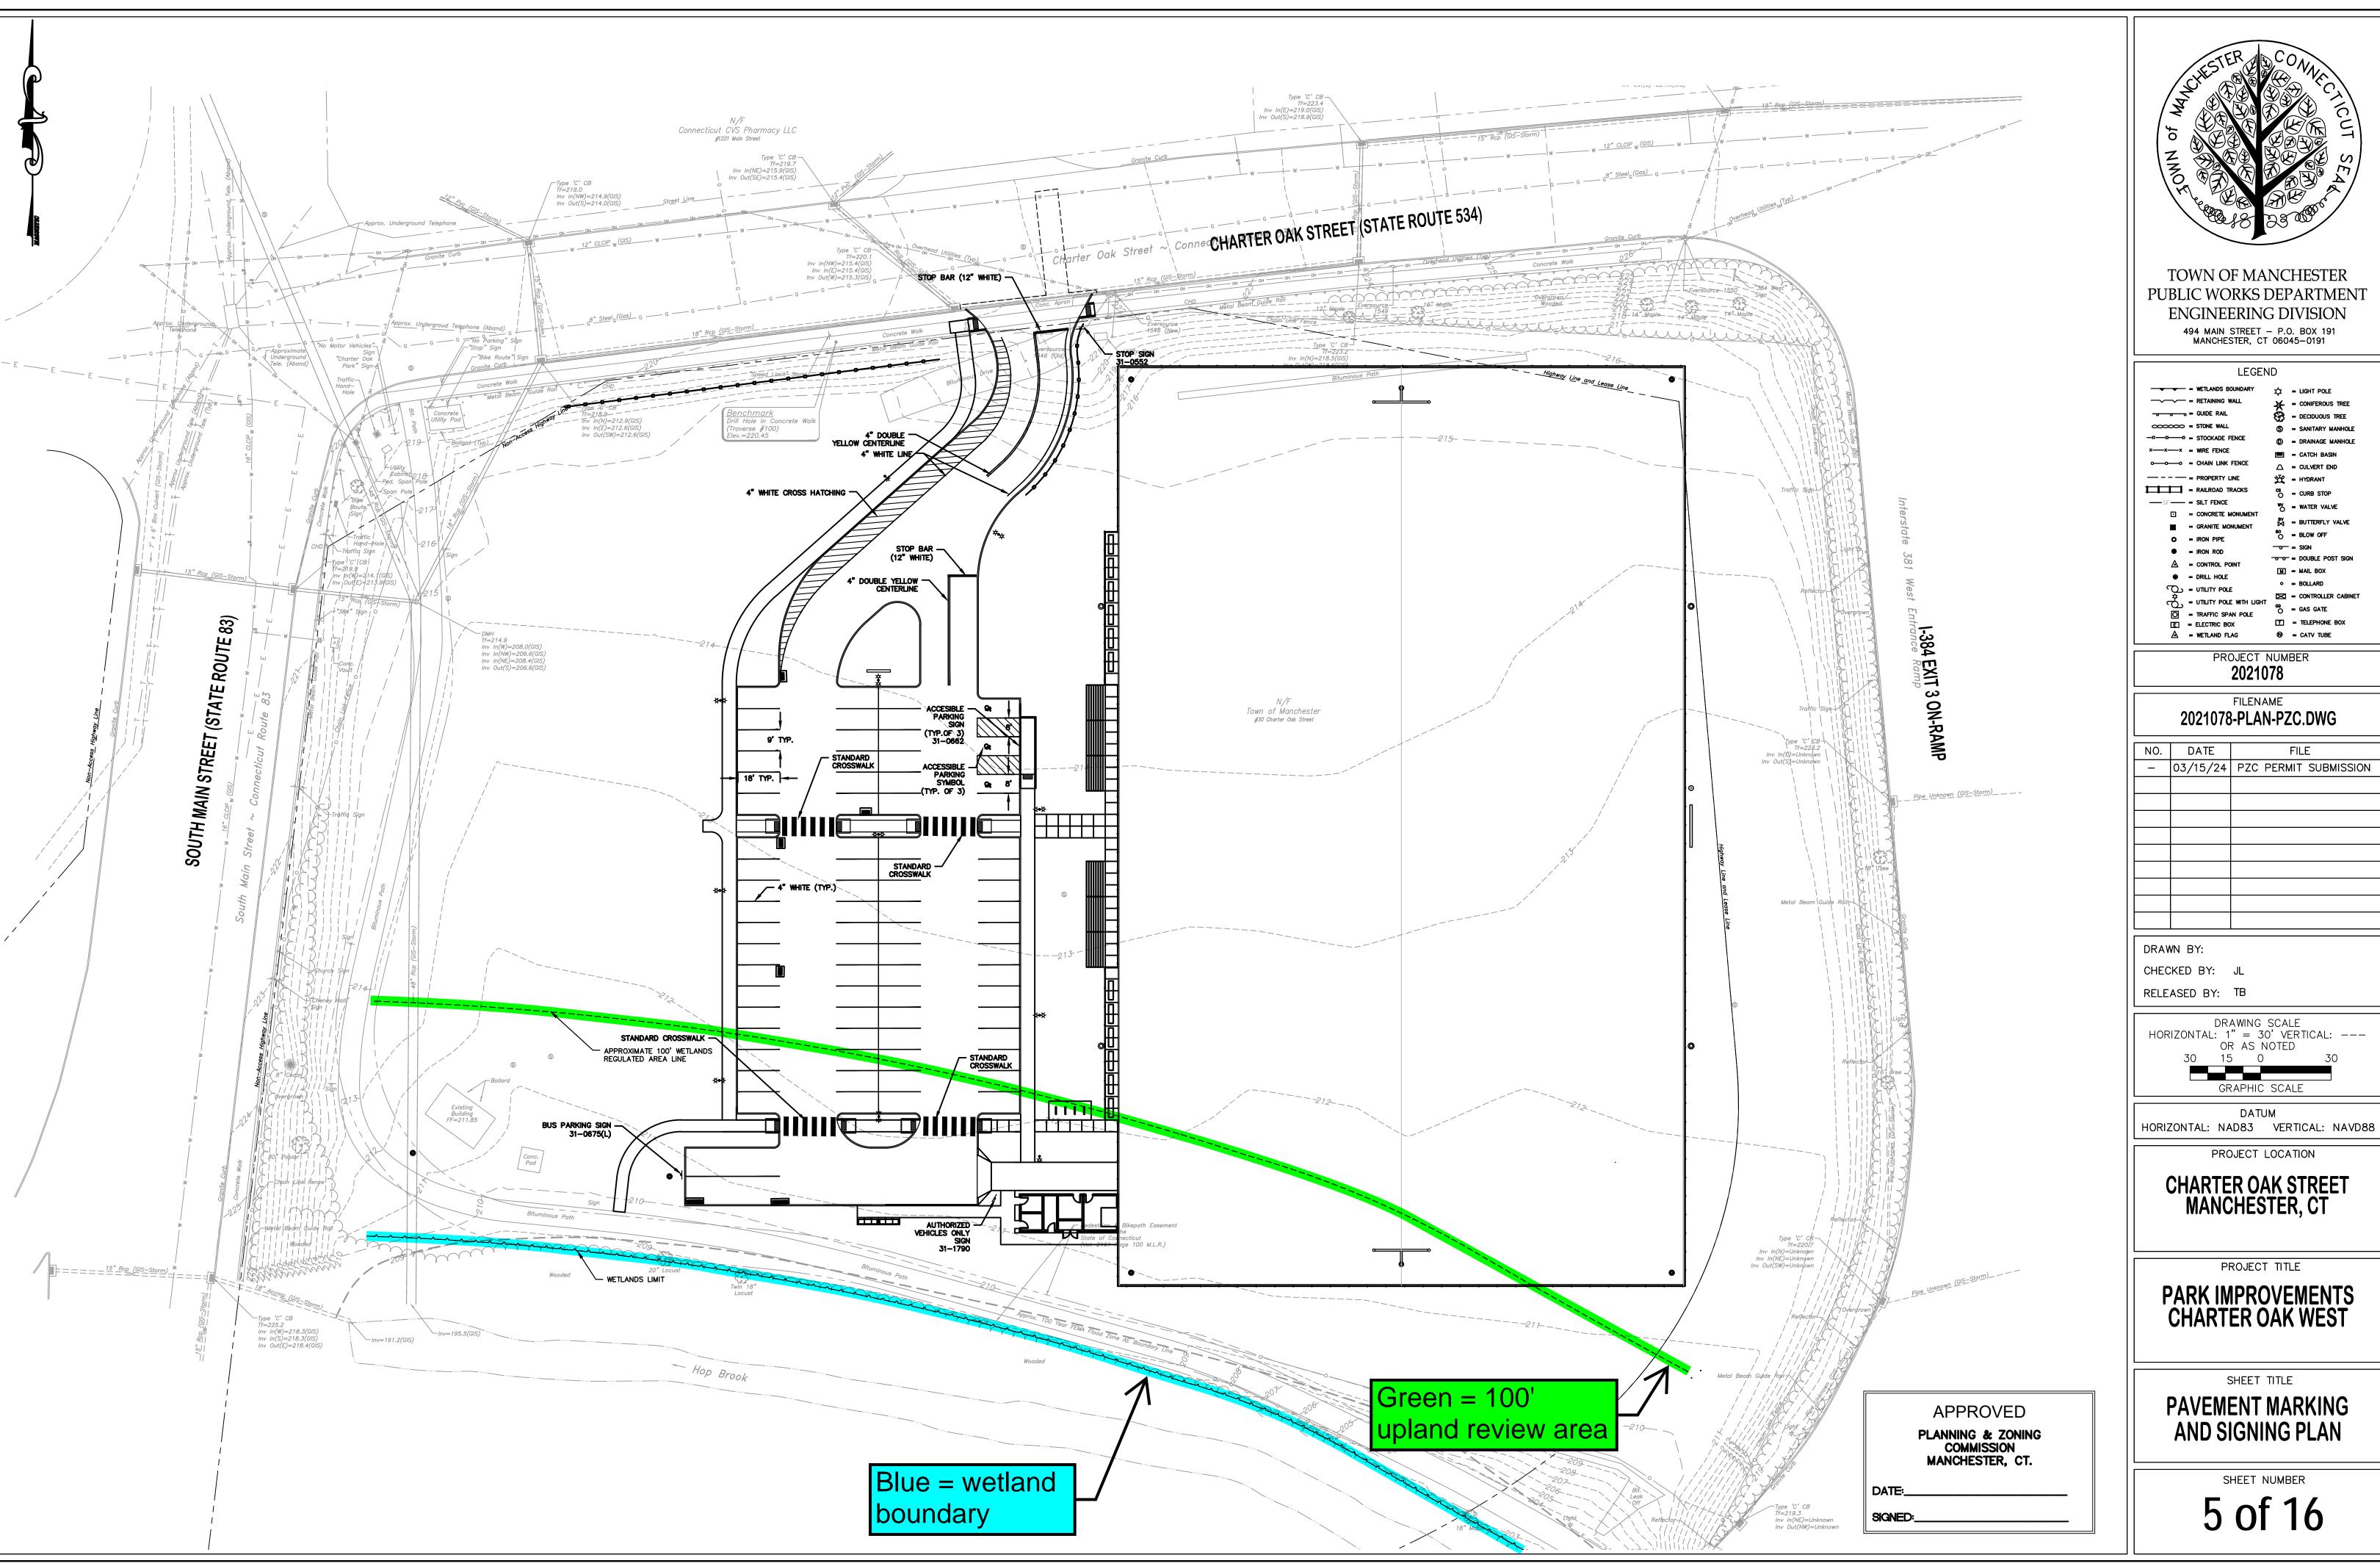



TOWN OF MANCHESTER PUBLIC WORKS DEPARTMENT **ENGINEERING DIVISION**

> BV = BUTTERFLY VALVE - sign

O = BLOW OFF M = MAIL BOX = BOLLARD

T = TELEPHONE BOX


NO.	DATE	FILE
_	03/15/24	PZC PERMIT SUBMISSION

DRAWING SCALE
HORIZONTAL: 1" = 30' VERTICAL: --OR AS NOTED
30 15 0 30
GRAPHIC SCALE

PROJECT LOCATION

PARK IMPROVEMENTS CHARTER OAK WEST

PAVEMENT MARKING AND SIGNING PLAN

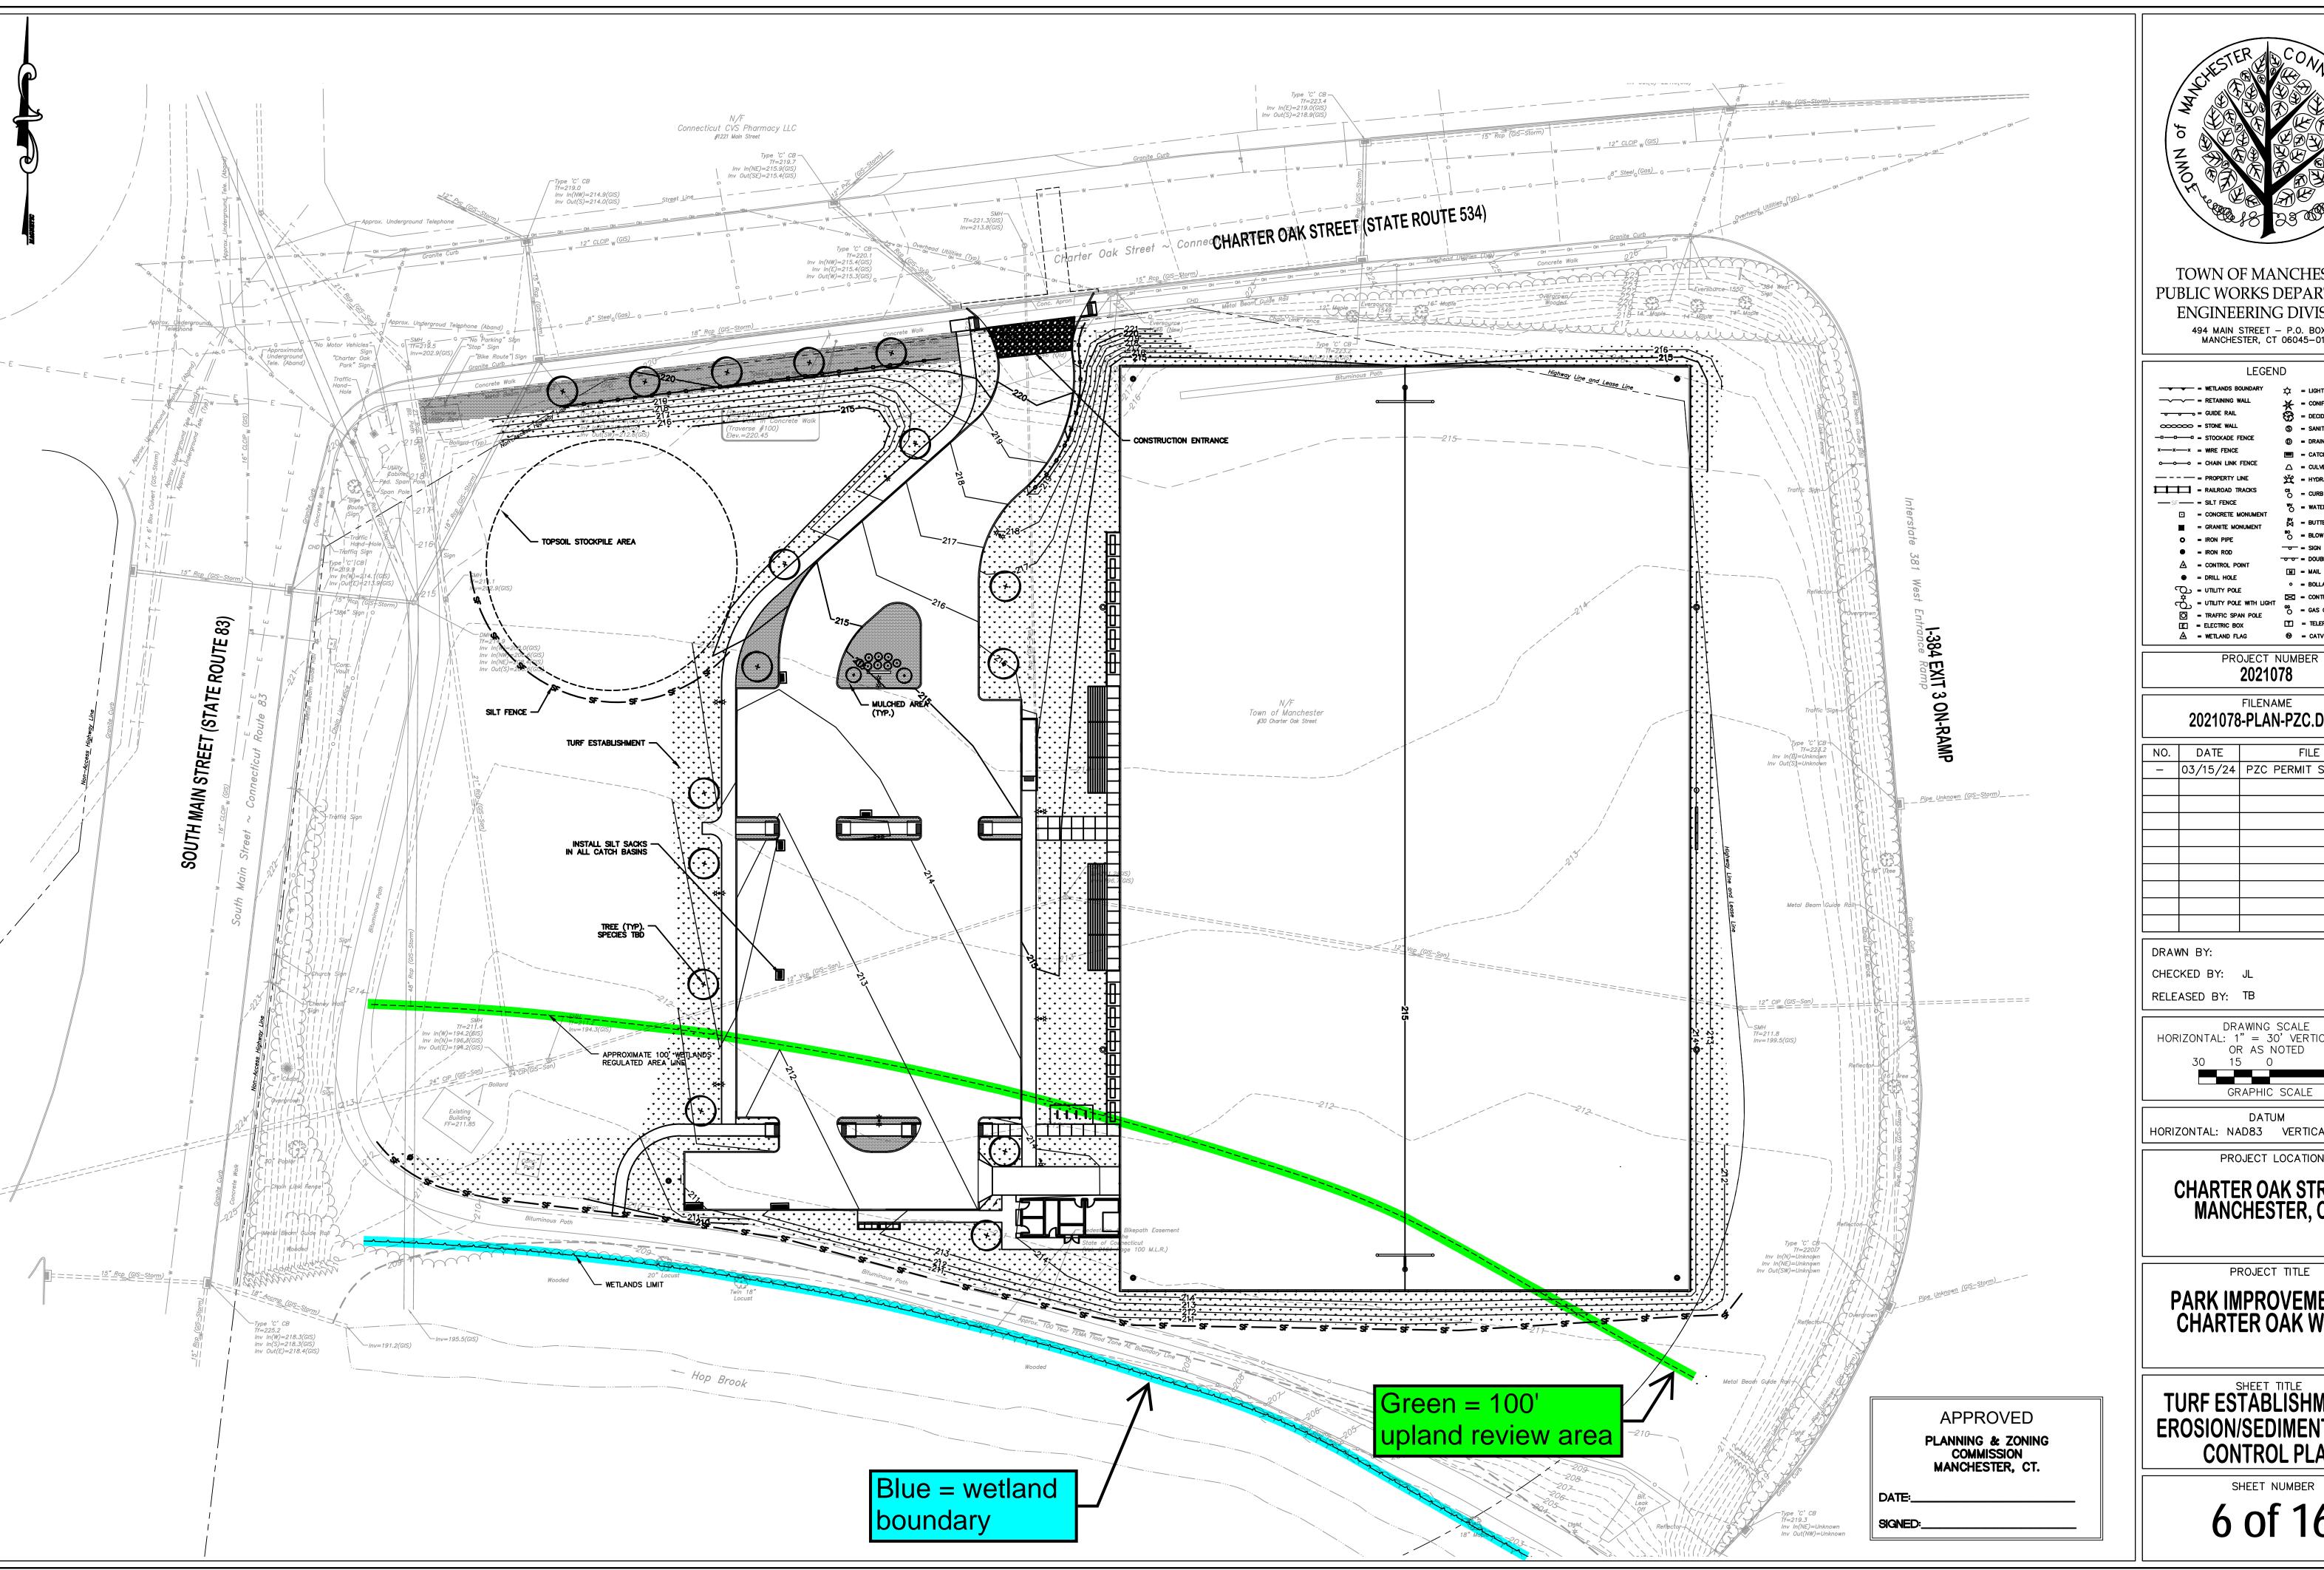



TOWN OF MANCHESTER PUBLIC WORKS DEPARTMENT **ENGINEERING DIVISION** 494 MAIN STREET - P.O. BOX 191 MANCHESTER, CT 06045-0191

- sign M = MAIL BOX T = TELEPHONE BOX

2021078

FILENAME 2021078-PLAN-PZC.DWG

NO.	DATE	FILE
_	03/15/24	PZC PERMIT SUBMISSION

DRAWING SCALE
HORIZONTAL: 1" = 30' VERTICAL: --OR AS NOTED
30 15 0 30

DATUM
HORIZONTAL: NAD83 VERTICAL: NAVD88

PROJECT LOCATION


CHARTER OAK STREET MANCHESTER, CT


PROJECT TITLE

PARK IMPROVEMENTS CHARTER OAK WEST

TURF ESTABLISHMENT & EROSION/SEDIMENTATION CONTROL PLAN

SHEET NUMBER

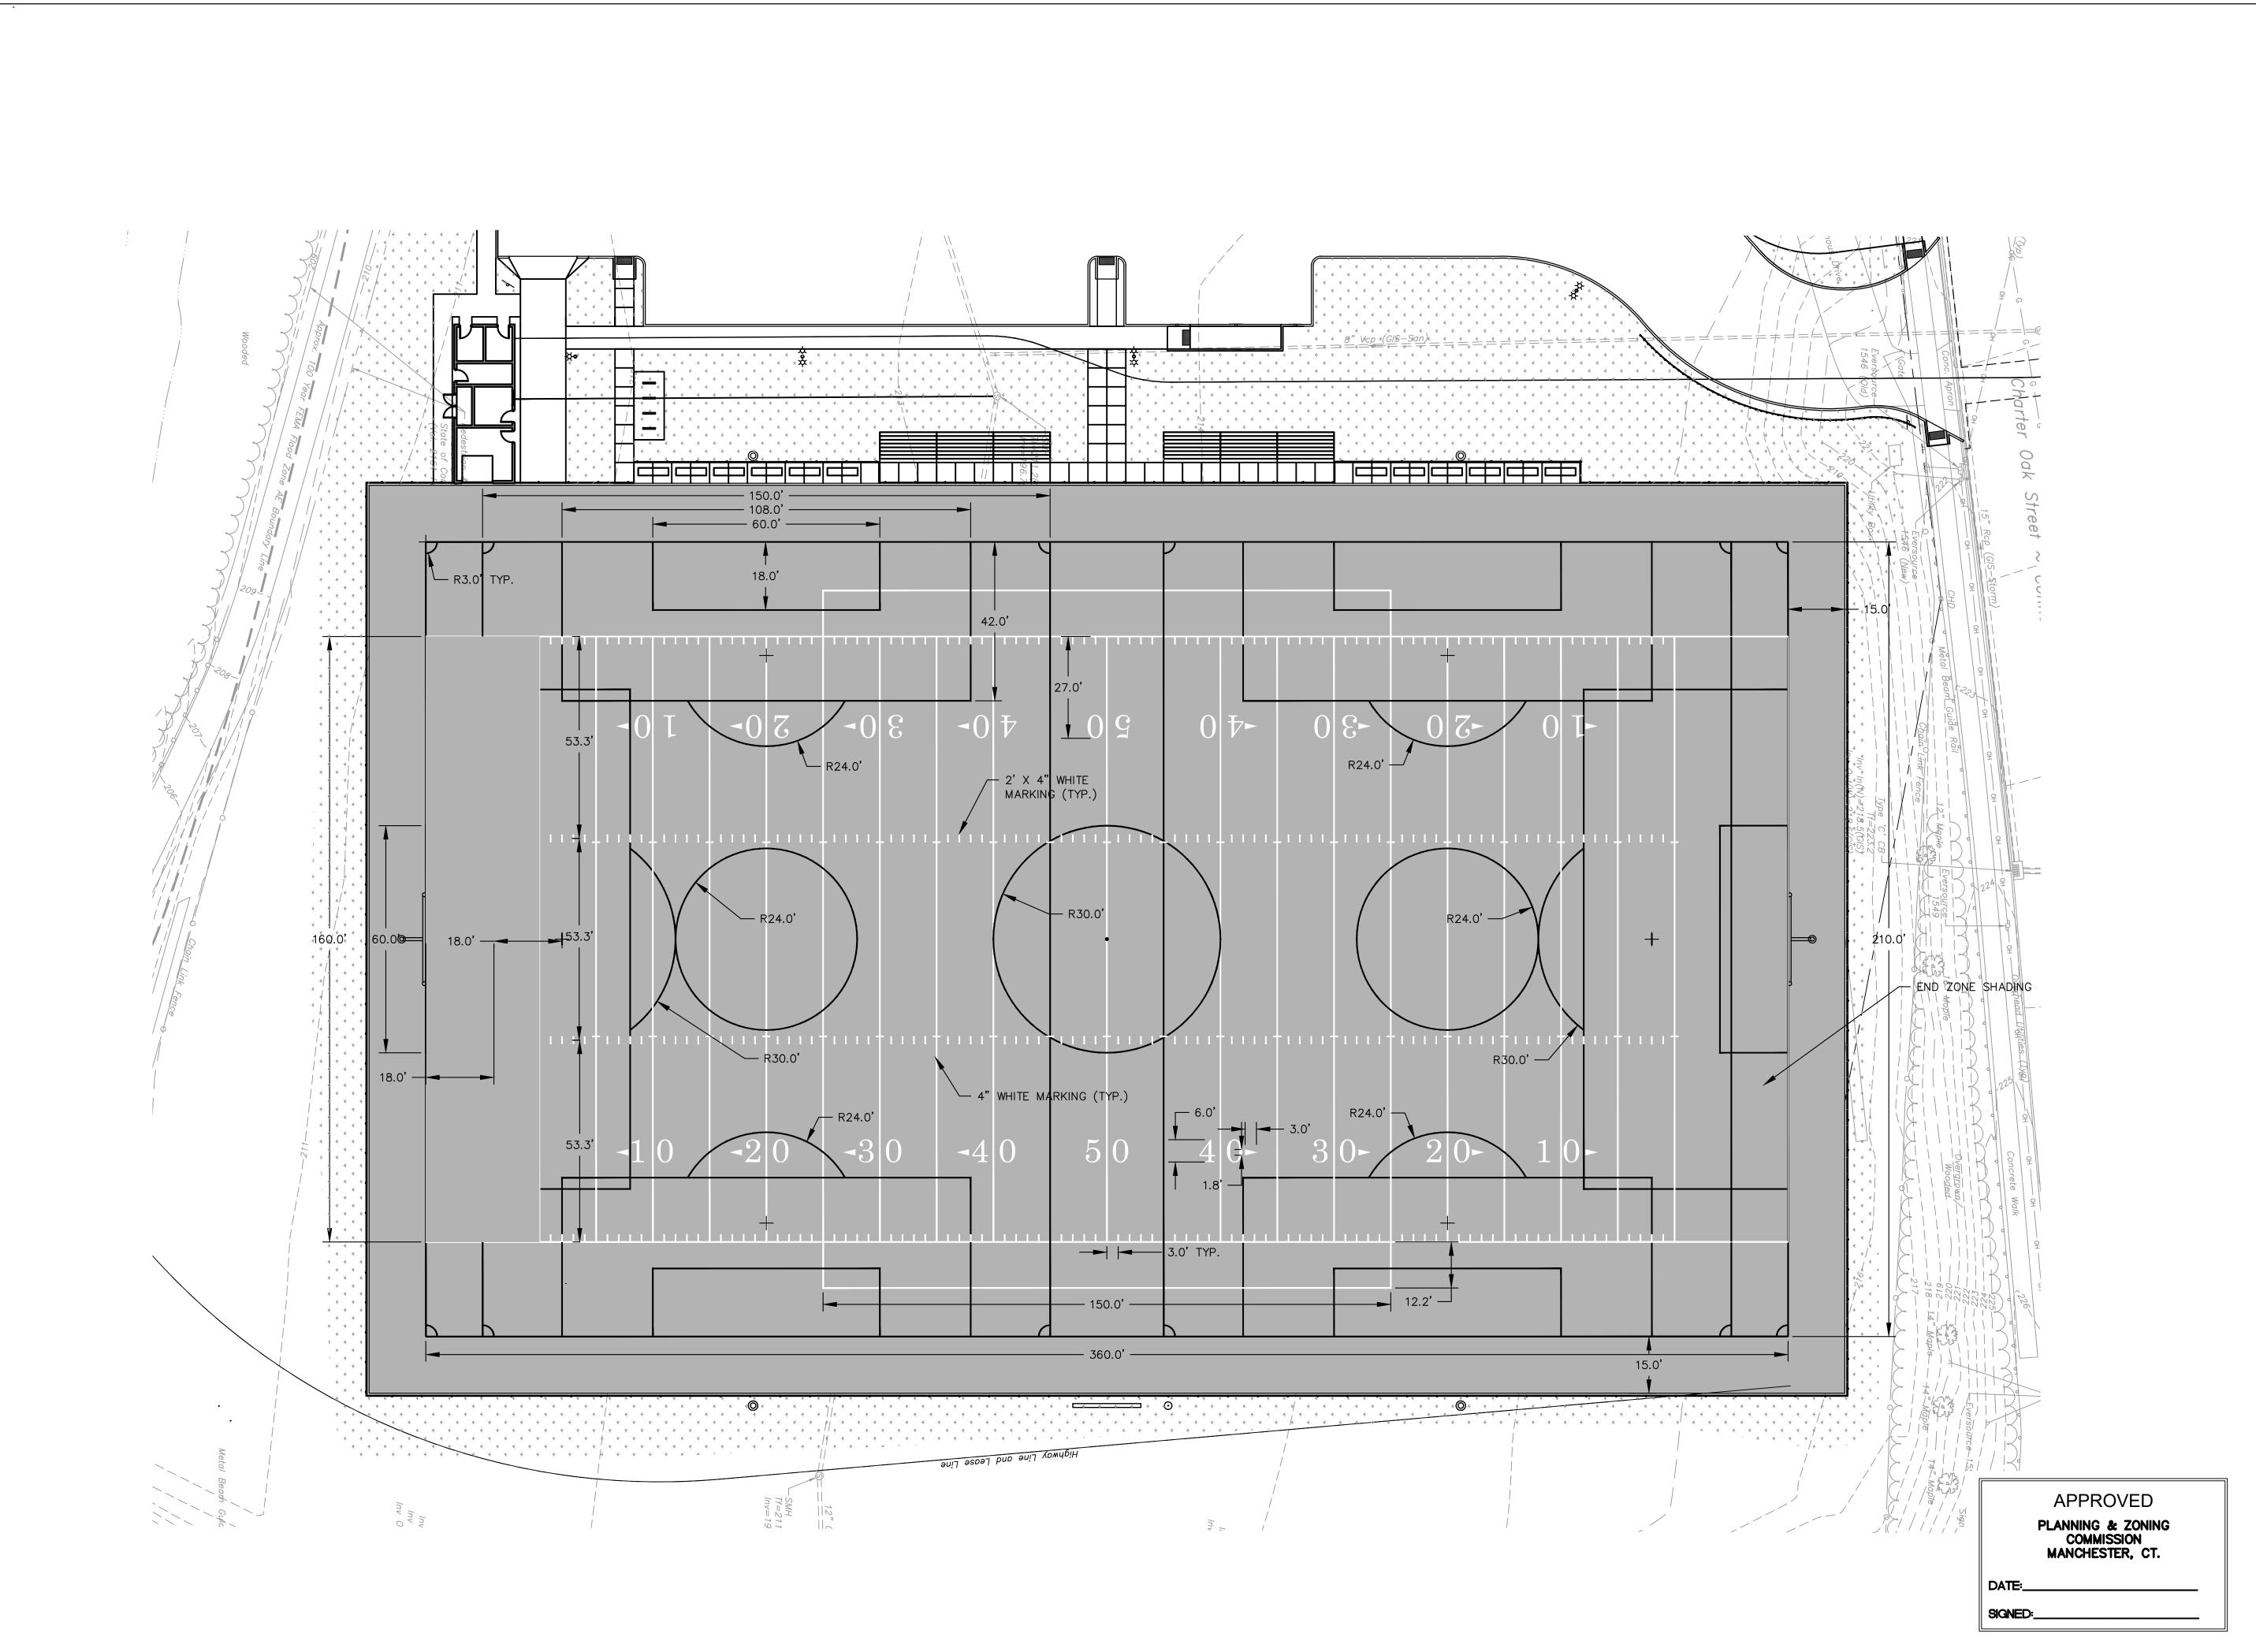

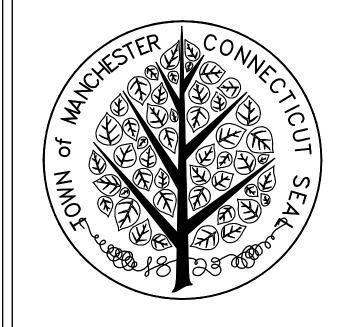

TOWN OF MANCHESTER
PUBLIC WORKS DEPARTMENT
ENGINEERING DIVISION

494 MAIN STREET - P.O. BOX 191
MANCHESTER, CT 06045-0191

LEGEND								
= WETLANDS BOUNDARY	\$	= LIGHT POLE						
= RETAINING WALL	¥	= CONIFEROUS TREE						
GUIDE RAIL	8	= DECIDUOUS TREE						
○ STONE WALL	S	= SANITARY MANHOLI						
	0	= DRAINAGE MANHOLI						
×× = WRE FENCE		= CATCH BASIN						
oo = CHAIN LINK FENCE	Δ	= CULVERT END						

SF — SILT FENCE

CONCRETE MONUMENT

G = GRANITE MONUMENT

O = IRON PIPE

D = IRON POD

SW = WATER

W O = WATER

BY = BUTTER

C = BLOW 0

TO = SIGN

ON ROD

ON TOD

= CONTROLLER CABI

= UTILITY POLE WITH LIGHT

= TRAFFIC SPAN POLE

= ELECTRIC BOX

= WETLAND FLAG

= CONTROLLER CABI

GO

= GAS GATE

= TELEPHONE BOX

DO

= CATV TUBE

PROJECT NUMBER 2021078

FILENAME 2021078-PLAN-PZC.DWG

NO.	DATE	FILE
_	03/15/24	PZC PERMIT SUBMISSION

DRAWN BY:
CHECKED BY: JL
RELEASED BY: TB

DRAWING SCALE
HORIZONTAL: 1" = 20' VERTICAL: --OR AS NOTED
20 10 0 20
GRAPHIC SCALE

DATUM HORIZONTAL: NAD83 VERTICAL: NAVD88

CHARTER OAK STREET MANCHESTER, CT

PROJECT LOCATION

PROJECT TITLE


PARK IMPROVEMENTS CHARTER OAK WEST

SHEET TITLE

FIELD MARKINGS PLAN

SHEET NUMBER

PLUMBING SYMBOL LIST					
SYMBOL	ABBREV.	DESCRIPTION			
	CW	COLD WATER			
	HW	HOT WATER			
	V	VENT			
——SAN ———	SAN or W	SANITARY OR WASTE ABOVE SLAB/FLOOR			
SAN	SAN or W	SANITARY OR WASTE BELOW SLAB/FLOOR			
		SHUT-OFF VALVE			
Cl		RISER DOWN			
—-ю		RISER UP			
		TEE DOWN			
3		PIPE CAP			
		PITCH DOWN IN DIRECTION OF ARROW			
-		FLOW-IN DIRECTION OF ARROW			
0	FD	FLOOR DRAIN WITH P-TRAP			
0	со	FLOOR CLEAN OUT			
wco	wco	WALL CLEAN OUT			

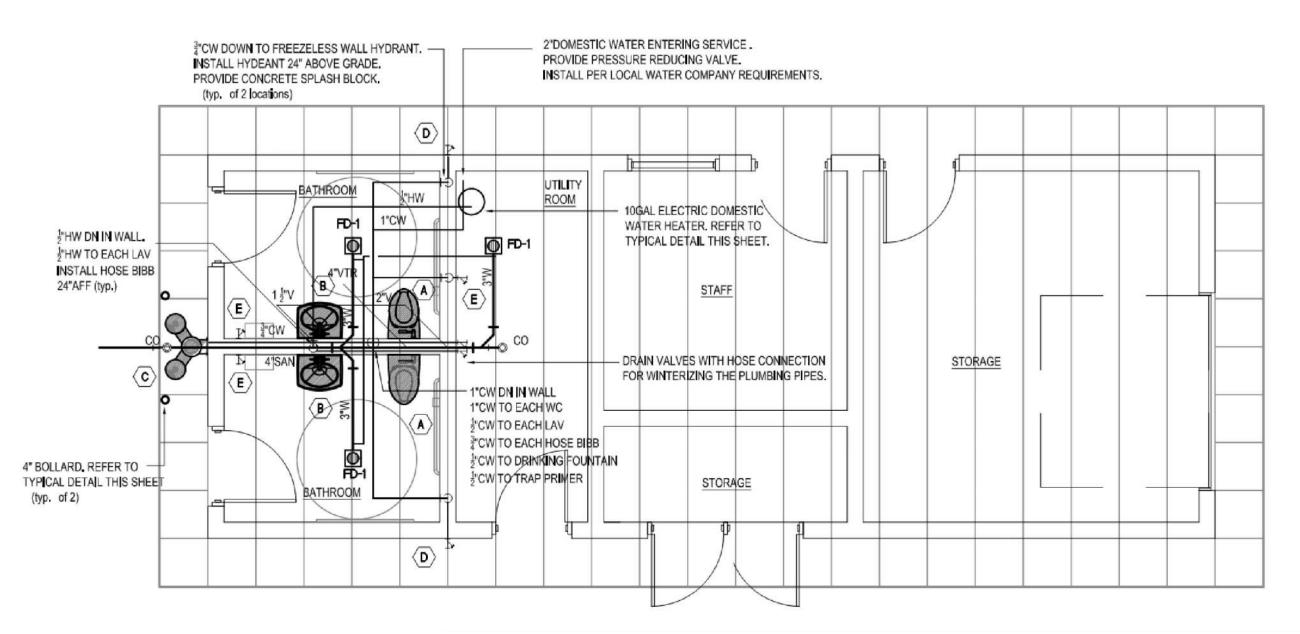

PLUMBING PLAN

GENERAL NOTES:

- 1. DRAWINGS ARE DIAGRAMMATIC AND SHOW GENERAL INTENT OF WORK, ALL CONTRACTORS MUST COORDINATE WITH OTHER TRADES OTHER TRADES BEFORE PROCEEDING WITH ANY WORK.
- 2. THE CONTRACTOR SHALL COORDINATE THE ROUTING AND INSTALLATION OF PLUMBING SYSTEMS TO AVOID CONFLICTS.
- 3. THE CONTRACTOR SHALL VISIT THE SITE AND FAMILIARIZE HIMSELF WITH CONDITIONS PRIOR TO SUBMITTING HIS BID.

 4. INSTALL ALL HANDICAP ACCESSIBLE FIXTURES IN ACCORDANCE WITH ADA, UFAS AND ANSI REQUIREMENTS.
- 5. ALL WASTE PIPE 3" AND LARGER SHALL HAVE A PITCH OF 1/8"per Ft.
- 6. ALL UNDER SLAB DRAINAGE PIPING SHALL BE IN PVC
- 7. MINIMUM SIZE FOR ALL UNDER SLAB DRAINAGE PIPING SHALL BE 3 INCH.
- 8. PROVIDE ESCUTCHEON PLATE @ ALL WALL/CEILING PENETRATIONS.
- 9. THIS CONTRACTOR SHALL PROVIDE CLEANOUTS WITH COVER (ACCESS DOORS) ON WASTE STACKS @ CHANGE OF DIRECTION AND SLAB PENETRATIONS.


4. WALL CLEANOUT WITH STAINLESS STEEL COVER

10. THERE SHALL BE NO EXPOSED PIPING. PIPES SHALL RUN CONCEALED ABOVE THE CEILING OR IN WALLS. WHERE NOT POSSIBLE, THE GENERAL CONTRACTOR SHALL PROVIDE PIPE CHASES. ON EXTERIOR WALLS, PIPES SHALL RUN ON THE WARM SIDE OF THE INSULATION AND HAVE 2" OF INSULATION, PROVIDE PVC COVER FOR INSULATED PIPES


UNIT No.	MANUF.	MODEL	SIZE: (OUTLET/ STRAINER)	LOCATION	TRAP PRIMER	REMARKS
FD-1	AY R SMITH	2005Y B-U-NB-13	3"Ø	TOILET RM.	P050	1,3
co	JAY R SMITH	4023				2,3
WC0	JAY R SMITH	4422				4

	PLUMBING FIXTURE SCHEDULE- UNITS							
FIXTURE	DESCRIPTION	MANUF.	MODEL	CONNECTION				REMARKS
TYPE	DESCRIPTION	MARKOT.	model.	cw	HW	W/SAN	٧	I CHOO EX
$\langle \mathbf{A} \rangle$	WATER CLOSET (ACCESSIBLE)	KOHLER	KINGSTON ULTRA K-84325	11 -		4.	2'	1.2
(A)	FLUSH VALVE (ACCESSIBLE)	SLOAN	WES-111-1.6/1.1					1,2
(B)	LAVATORY (ACCESSIBLE)	KOHLER	PINOIR K-2035-1	1/2" 1/2"	1 1/2"	1 1/4"	1,3,4	
•	FAUCET	CHICAGO	3502-4E2805ABCP	1/2 1/2		1 1/2		1 1/4
©	DRINKING FOUNTAIN (ACCESSIBLE)	ELKAY	LK4409BF	1/2*		1 1/2"	1 1/4"	1,2
(D)	FREEZELESS WALL HYDRANT	WOODFORD	65	3/4"	-	-	-	-
(E)	HOSE BIBB	WOODFORD	B26	3/4"	1-1	-	-	-

- REMARKS: 1, REFER TO ARCHITECTURAL DRAWINGS FOR FIXTURE MOUNTING HEIGHT,
 2. TOILET SEAT SHALL BE MODEL K-4731 BY KOHLER
 - 3. PROVIDE TRUBRO PIPE INSULATION FOR ALL ACCESSIBLE LAVATORIES AND SINKS.
 - SINGLE FAUCET HOLE
 PROVIDE WITH QUICK CONNECT HAND HELD SHOWER
 - PROVIDE MODEL 830 AA FAUCET, HOSE AND HOSE BRACKET, MOP HANGER, 3"QUICK DRAIN CONNECTOR, VYNIL BUMPER GUARD, STAINLESS STEEL WALL GUARD. PROVIDE AIR ADMITTANCE VALVE BY STUDORVENT.
 - PROVIDE STAINLESS STEEL TOP ENCLOSURE COVER TO MATCH SHOWER SYSTEM

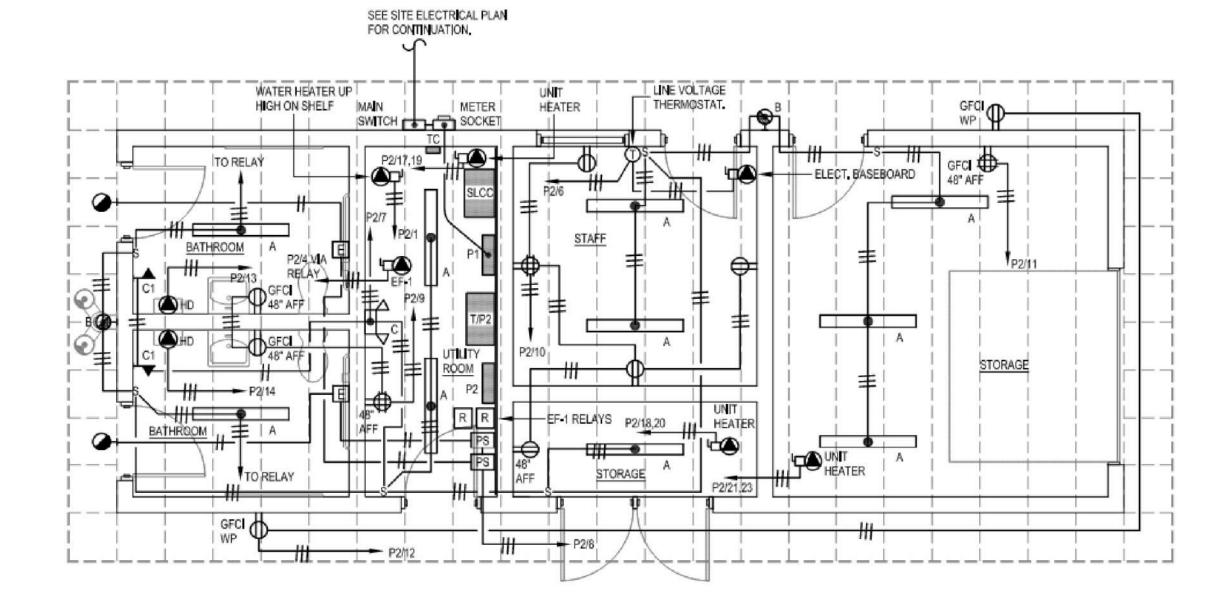

UTILITY BUILDING FLOOR PLAN - LIGHTING AND POWER

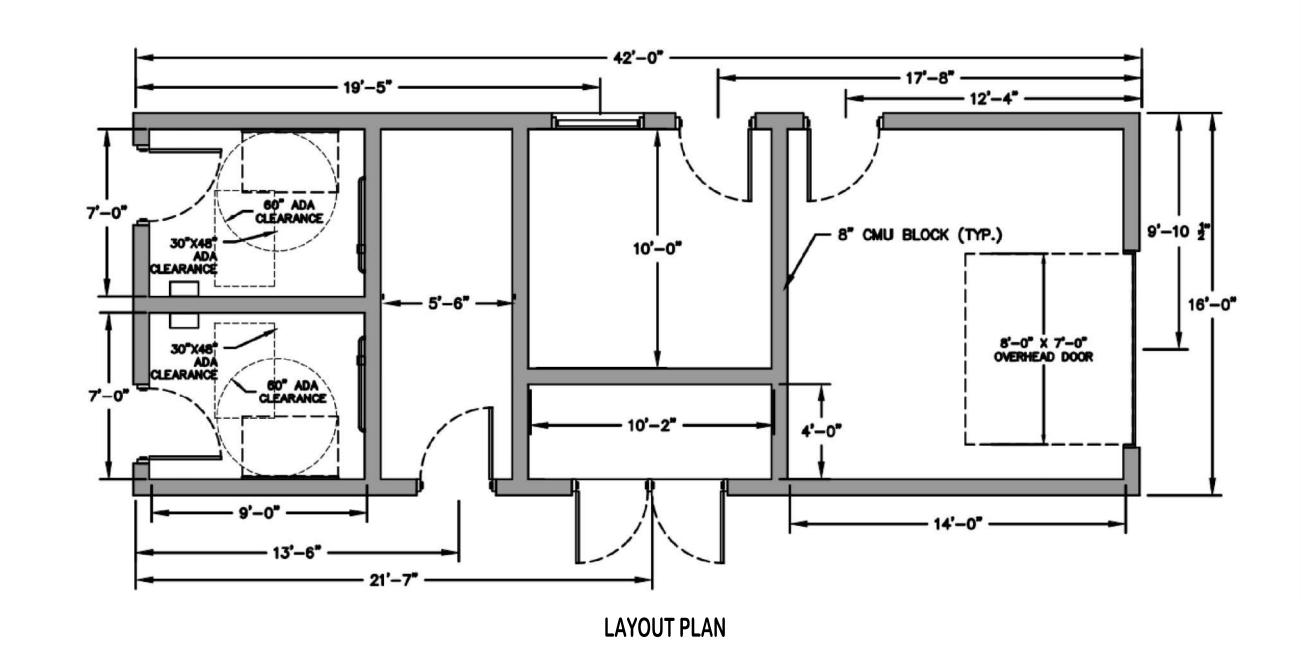

	APPROVED
	PLANNING & ZONING COMMISSION MANCHESTER, CT.
DATE:_	



TOWN OF MANCHESTER
PUBLIC WORKS DEPARTMENT
ENGINEERING DIVISION
494 MAIN STREET - P.O. BOX 191

MANCHESTER,	СТ	06045-0191	
			•

x x x = WRE FENCE

c c c = CHAIN LINK FENCE

PROPERTY LINE

RAILROAD TRACKS

SF = SILT FENCE

SF — SILT FENCE

□ = CONCRETE MONUMENT

■ GRANITE MONUMENT

O = IRON PIPE

O = IRON PIPE

O = SIGN

= IRON PIPE

= IRON ROD

A = CONTROL POINT

= DRILL HOLE

UTILITY POLE

T = UTILITY POLE WITH LIGHT

JMENT

SV	= BUTTERFLY VALVE	
SO	= BLOW OFF	
O	= SIGN	
O	O	= DOUBLE POST SIGN
M	= MAIL BOX	
O	O	= BOLLARD

= DECIDUOUS TREE

💥 = HYDRANT

○ = BOLLARD

○ = BOLLARD

○ = BOLLARD

○ = CONTROLLER CABINE

○ = GAS GATE

○ = GAS GATE

○ = ELECTRIC BOX

△ = WETLAND FLAG

○ = CATV TUBE

PROJECT NUMBER 2021078

FILENAME
2021078-PLAN-PZC.DW0

NO.	DATE	FILE
_	03/15/24	PZC PERMIT SUBMISSION

DRAWN BY:
CHECKED BY: JL
RELEASED BY: TB

DATUM				
HORIZONTAL:	NAD83	VERTICAL:	NAVD88	

PROJECT LOCATION

CHARTER OAK STREET MANCHESTER, CT


PROJECT TITLE

PARK IMPROVEMENTS CHARTER OAK WEST

SHEET TITLE

UTILITY BUILDING PLAN

SHEET NUMBER

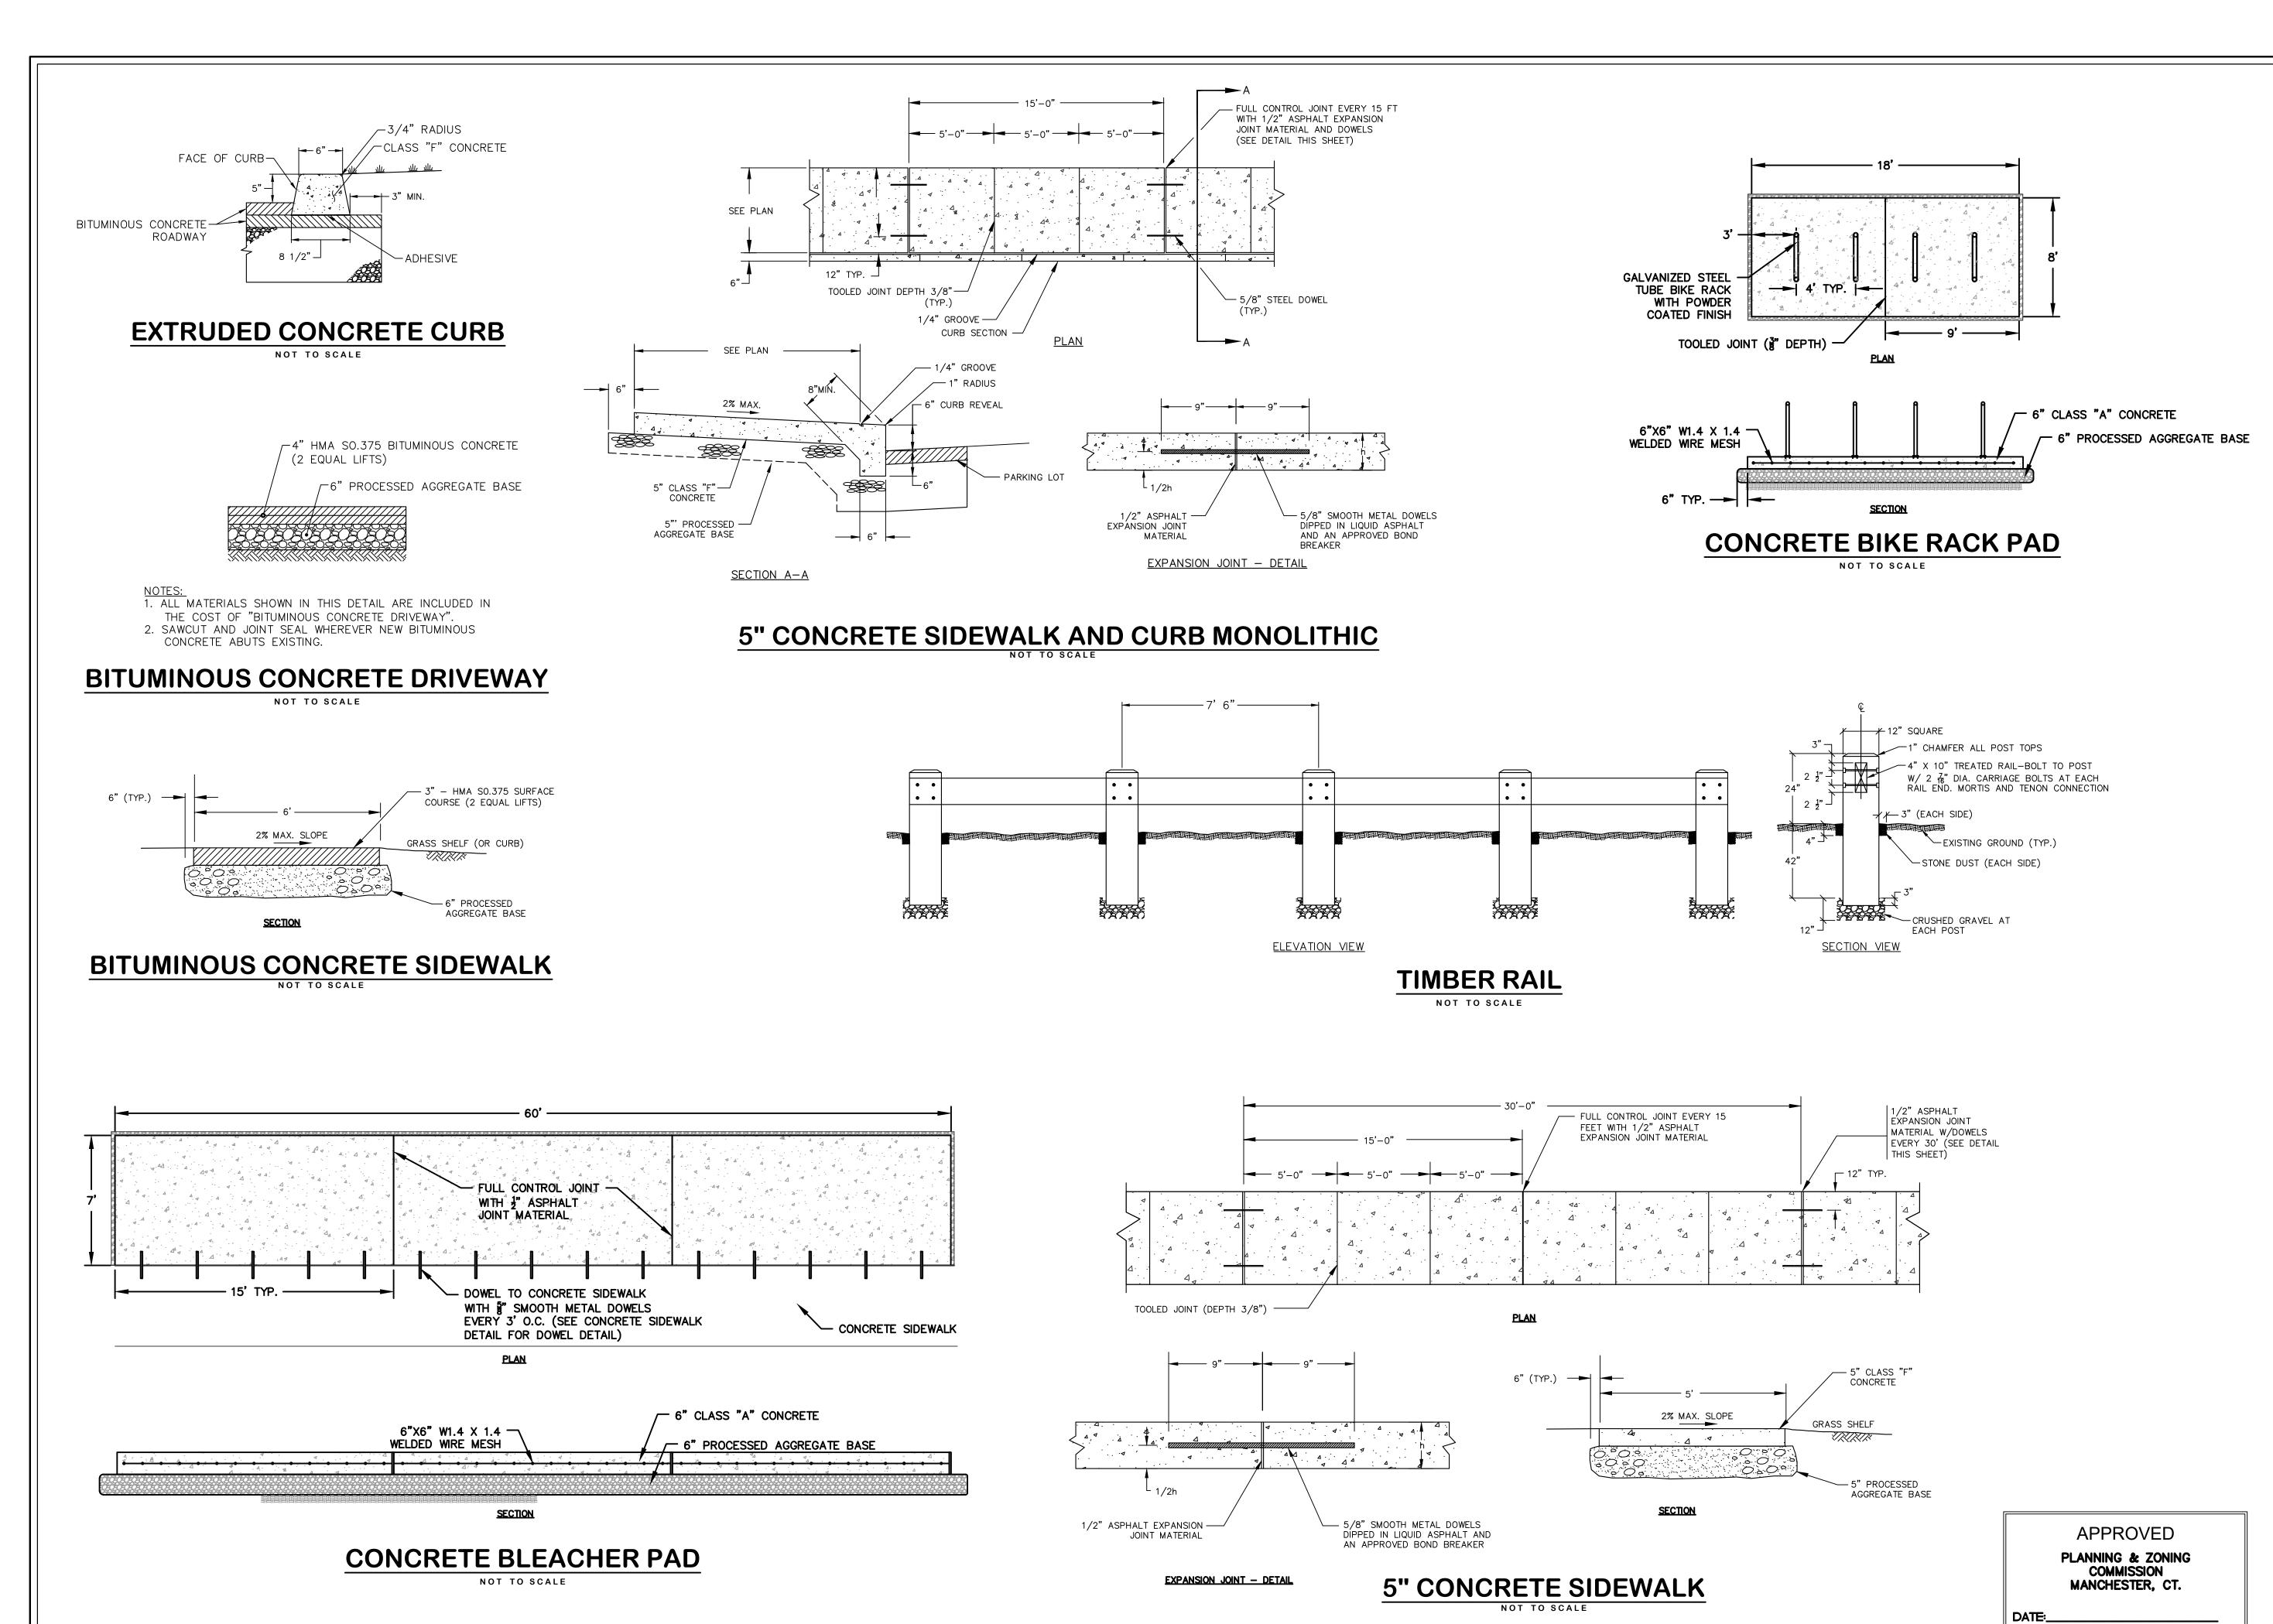

CONVECTION OF SEASONS OF SEASONS

TOWN OF MANCHESTER
PUBLIC WORKS DEPARTMENT
ENGINEERING DIVISION

494 MAIN STREET - P.O. BOX 191
MANCHESTER, CT 06045-0191

LEGEND

= WETLANDS BOUNDARY

= RETAINING WALL

= CONFEROUS TR

CONFEROUS

■ = GRANITE MONUMENT

O = IRON PIPE

■ IRON ROD

A = CONTROL POINT

■ DRILL HOLE

O = BULW OFF

O = BLOW OFF

O = DOUBLE POST SIGN

M = MAIL BOX

O = BOLLARD

■ UTILITY POLE

A = CONTROLLER CABIN

○ = BOLLARD

□ = UTILITY POLE WITH LIGHT

□ = TRAFFIC SPAN POLE

□ = ELECTRIC BOX

Δ = WETLAND FLAG

○ = BOLLARD

□ = CONTROLLER CA

□ = GAS GATE

□ = TELEPHONE BOX

□ = CATV TUBE

PROJECT NUMBER 2021078

FILENAME
2021078-PLAN-PZC.DWG

NO. DATE FILE

- 03/15/24 PZC PERMIT SUBMISSION

DRAWN BY:

CHECKED BY: JL

RELEASED BY: TB

DATUM
HORIZONTAL: NAD83 VERTICAL: NAVD88

PROJECT LOCATION

CHARTER OAK STREET MANCHESTER, CT

PROJECT TITLE


PARK IMPROVEMENTS CHARTER OAK WEST

SHEET TITLE

DETAILS

SHEET NUMBER

SIGNED:_

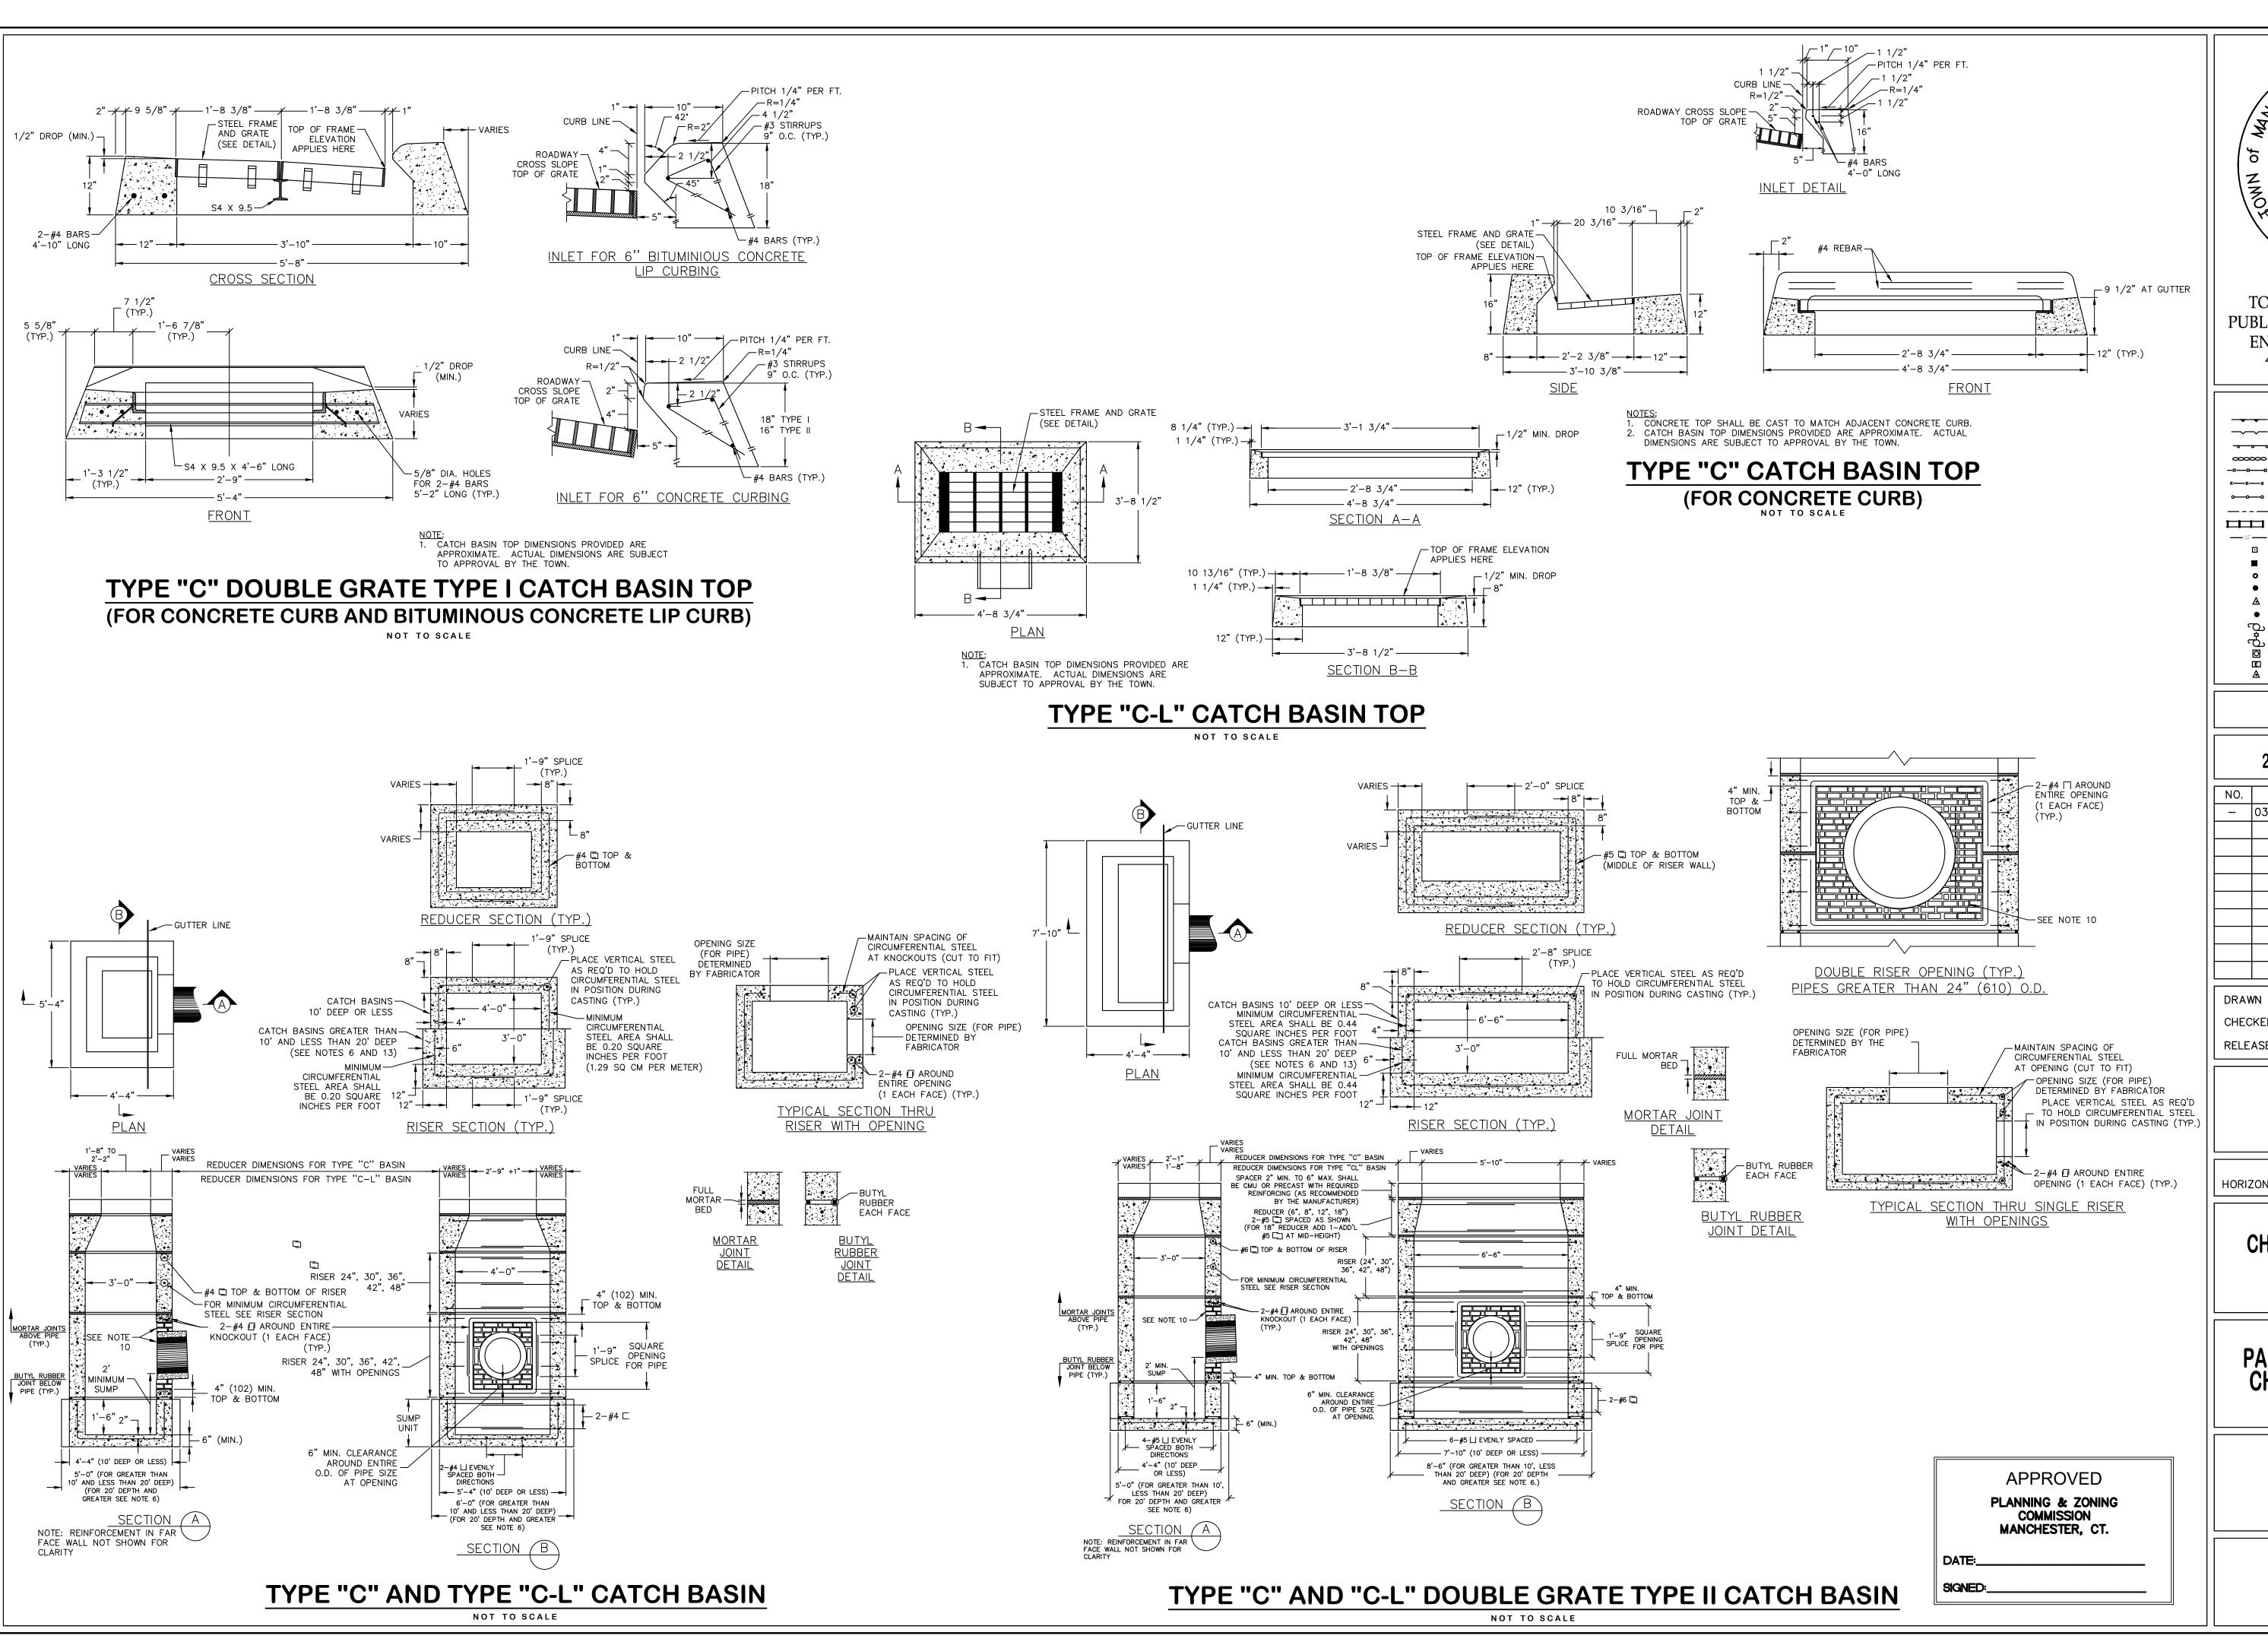



TOWN OF MANCHESTER
PUBLIC WORKS DEPARTMENT
ENGINEERING DIVISION

494 MAIN STREET - P.O. BOX 191
MANCHESTER, CT 06045-0191

LEGEN	ID
= WETLANDS BOUNDARY	☆ = LIGHT POLE
= RETAINING WALL	= CONIFEROUS TREE
= GUIDE RAIL	= DECIDUOUS TREE
STONE WALL	S = SANITARY MANHOLE
	DRAINAGE MANHOLI
xx = WIRE FENCE	= CATCH BASIN
oo = CHAIN LINK FENCE	△ = CULVERT END
	₩ = HYDRANT
= RAILROAD TRACKS	cs O = CURB STOP
——SF—— = SILT FENCE	=
	WV = WATER VALVE
■ = GRANITE MONUMENT	BV = BUTTERFLY VALVE
O = IRON PIPE	O = BLOW OFF
● = IRON ROD	o = SIGN
	o o = DOUBLE POST SIGN
= DRILL HOLE	M = MAIL BOX
= UTILITY POLE	• = BOLLARD
= UTILITY POLE WITH LIGHT	= CONTROLLER CABIN
O = TRAFFIC SPAN POLE	O = GAS GATE
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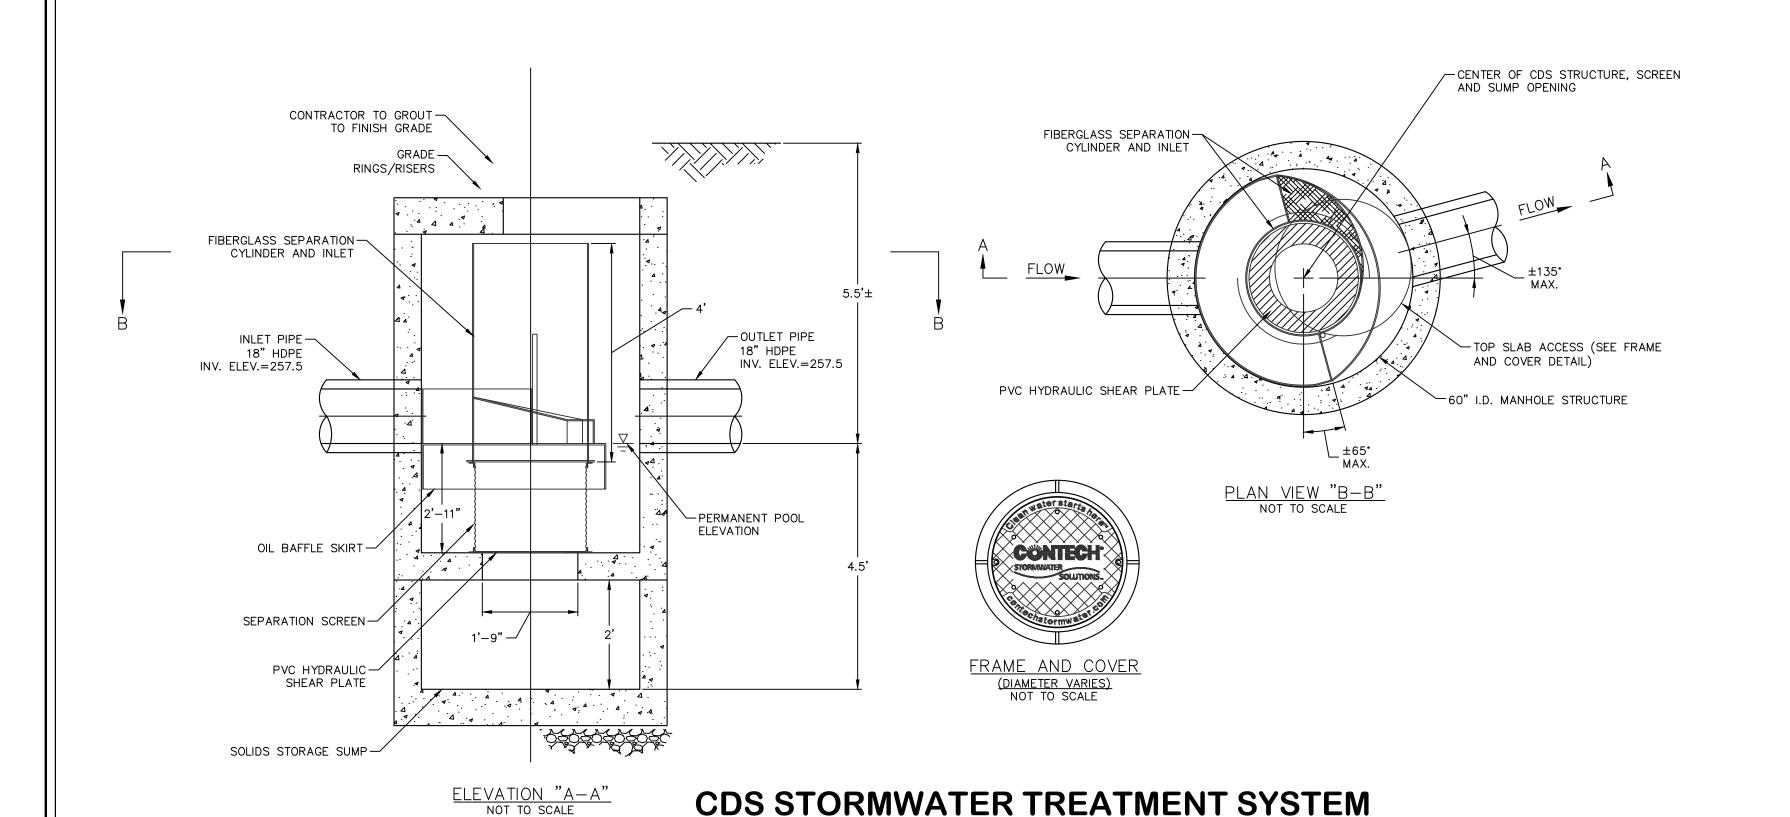
PROJECT TITLE


PARK IMPROVEMENTS CHARTER OAK WEST

SHEET TITLE


DETAILS

SHEET NUMBER



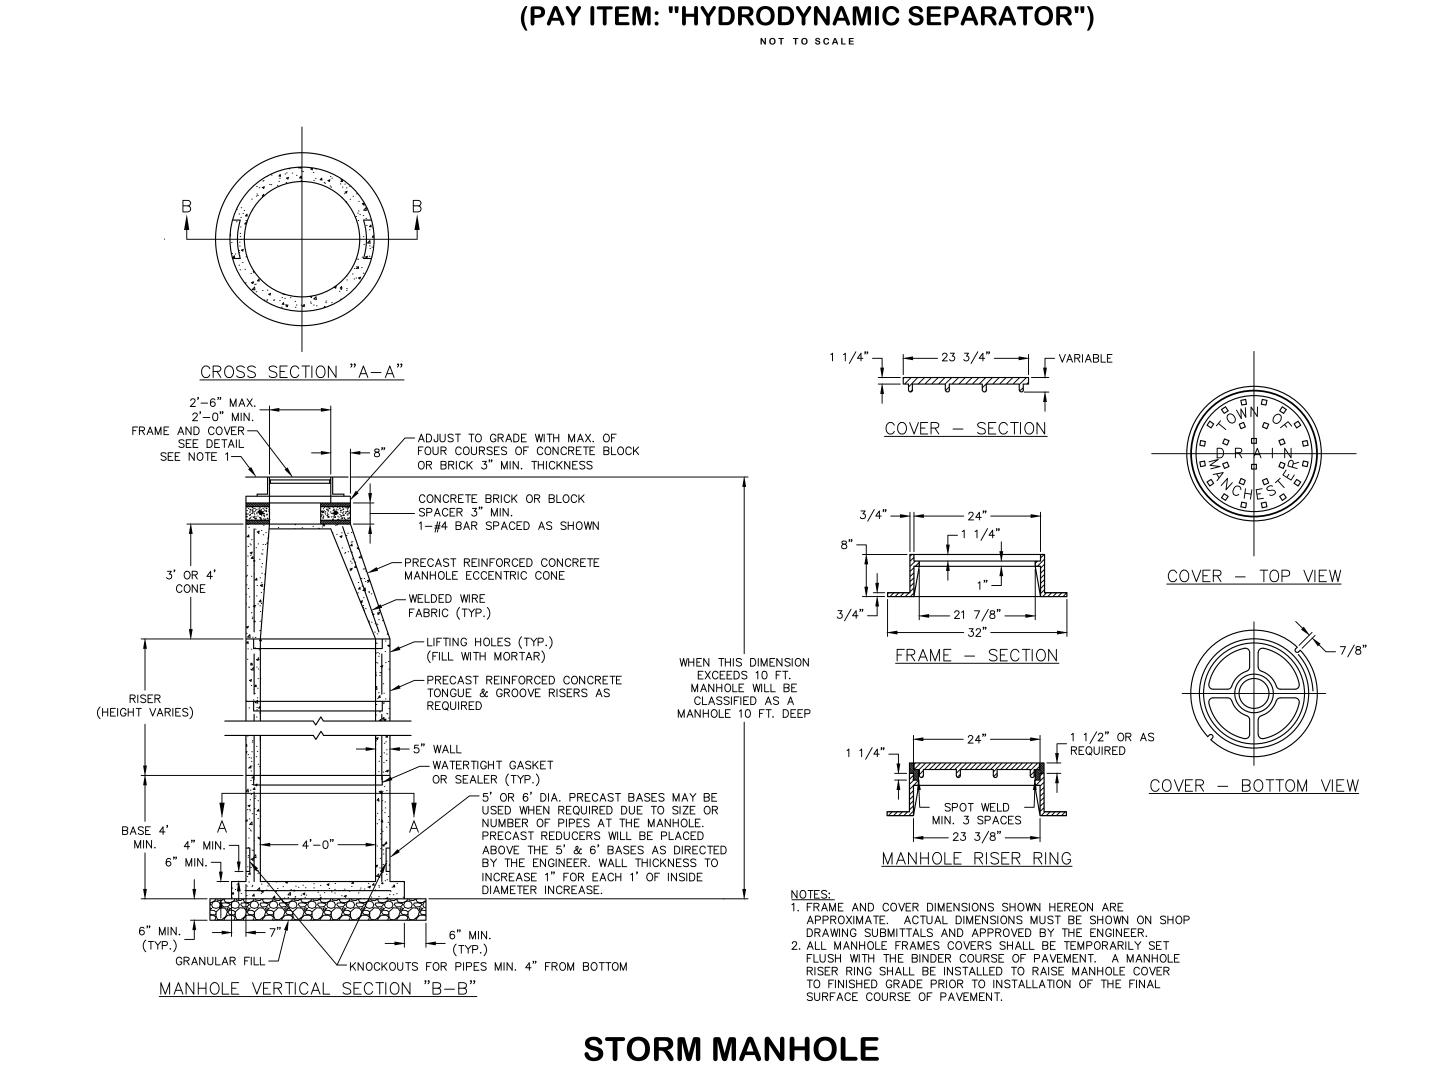


MODEL CDS 2025-5-C

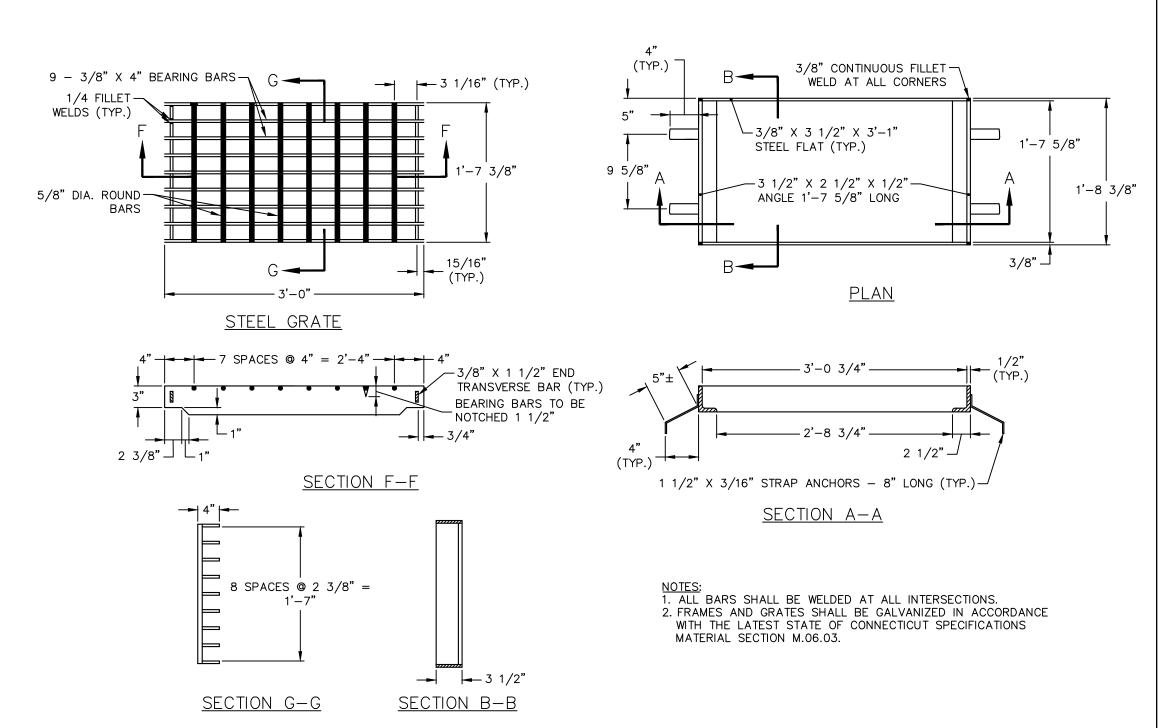

STEEL FRAME AND GRATE

NOT TO SCALE

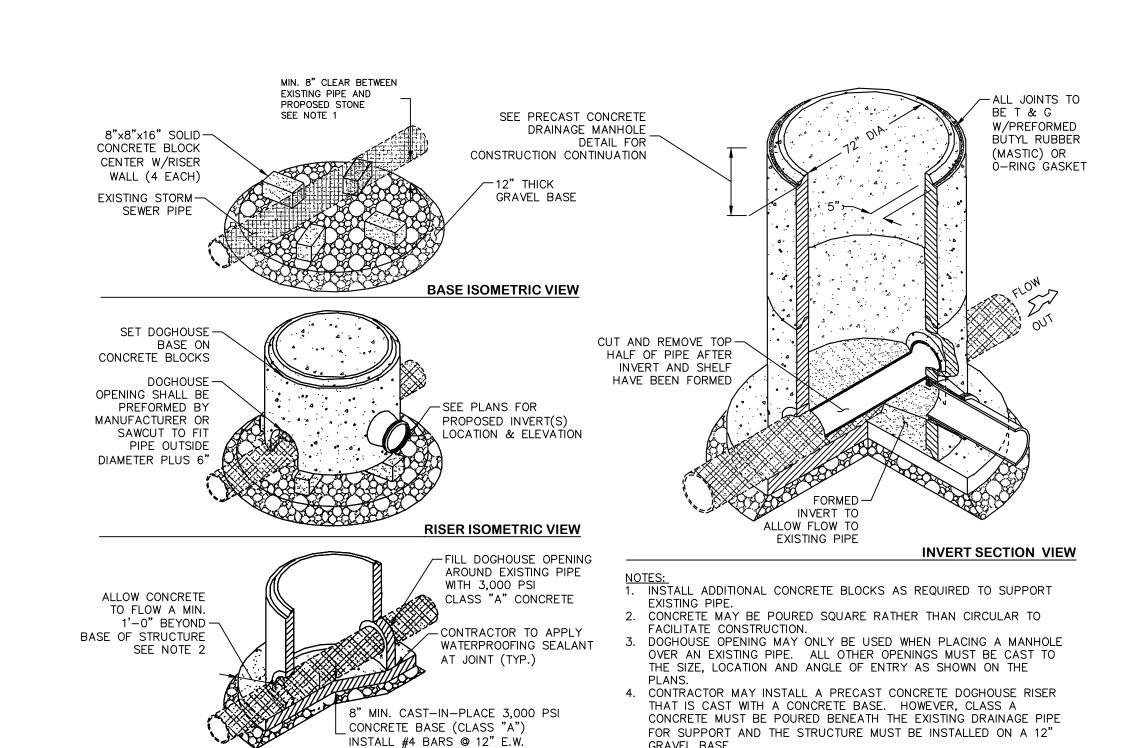

DRAINAGE (STORM) DOGHOUSE MANHOLE

SEE NOTE 4

FOUNDATION SECTION VIEW

APPROVED

PLANNING & ZONING

COMMISSION

MANCHESTER, CT.

5. DOGHOUSE MANHOLES SHALL NOT BE INSTALLED ON REINFORCED CONCRETE PIPE. ALL PROPOSED INSTALLATION LOCATIONS ARE SUBJECT TO APPROVAL BY THE TOWN.

CONNECTICUT SEAL BOOK OF SEAL B

TOWN OF MANCHESTER
PUBLIC WORKS DEPARTMENT
ENGINEERING DIVISION

494 MAIN STREET - P.O. BOX 191
MANCHESTER, CT 06045-0191

LEGEND

🗘 = LIGHT POLE
= CONIFEROUS TREE
= DECIDUOUS TREE
S = SANITARY MANHOLE
DRAINAGE MANHOLE
= CATCH BASIN
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WY = WATER VALVE
•
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⊕ CATV TUBE

2021078

PROJECT NUMBER

FILENAME
2021078-PLAN-PZC.DWG

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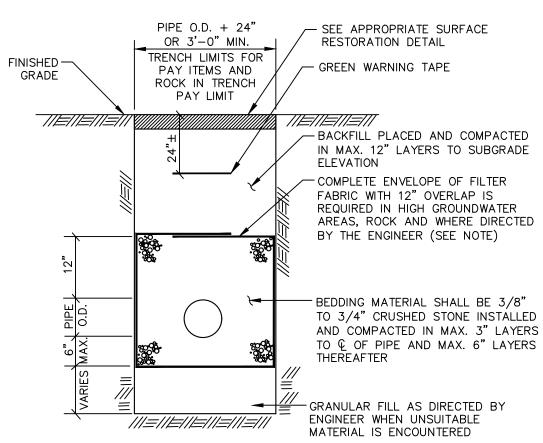
PROJECT TITLE

PARK IMPROVEMENTS CHARTER OAK WEST

SHEET TITLE

DETAILS


SHEET NUMBER



NOTE: IN ALL OTHER AREAS, AT A MINIMUM, BEDDING MATERIAL SHALL EXTEND TO THE TOP OF THE PIPE AND BE COVERED WITH


TYPICAL TRENCH DETAIL (SANITARY SEWER)

NOT TO SCALE

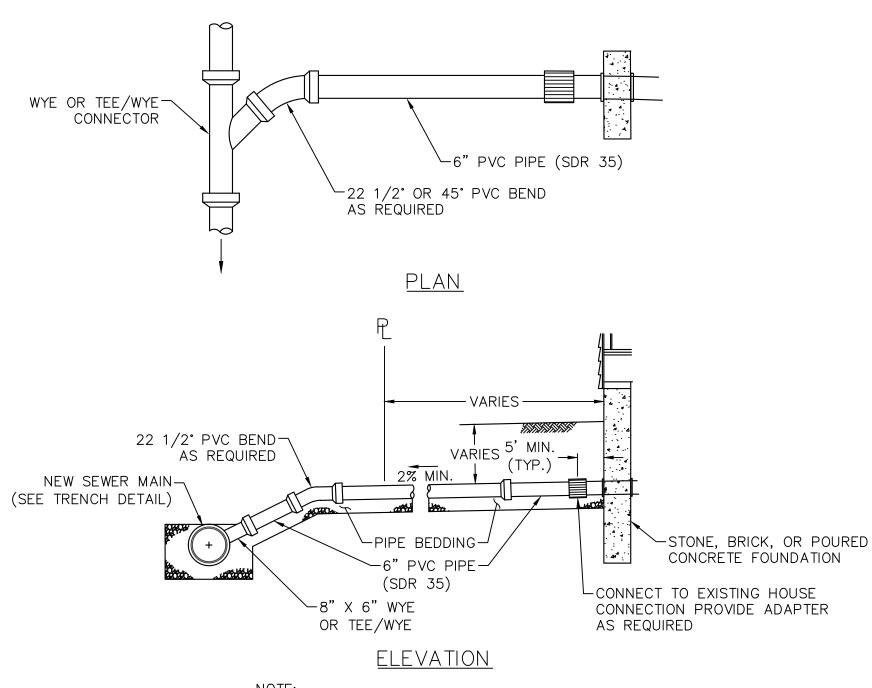

NOTE: EXACT LOCATION AND ELEVATION OF SERVICE CONNECTIONS TO BE DETERMINED IN THE FIELD DURING CONSTRUCTION.


6" SANITARY LATERAL CONNECTION (PAY ITEM: "6" PVC SANITARY SEWER LATERAL") NOT TO SCALE

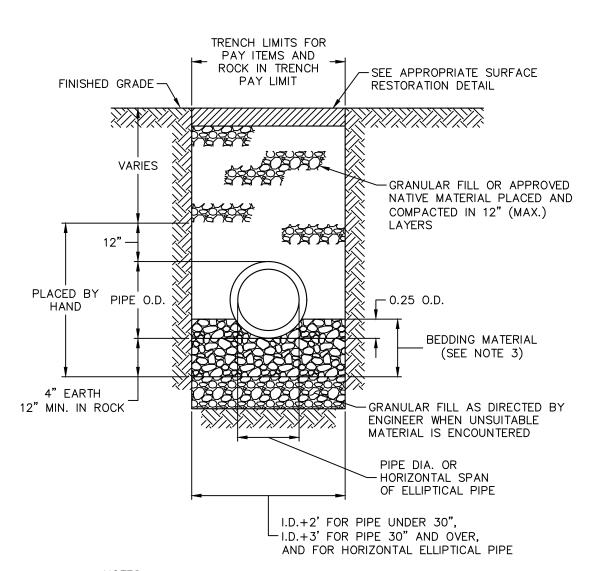

- ${\hbox{NOTES}}$: 1. ALL CONCRETE PIPE TO BE MINIMUM CLASS IV WITH 2 FT OF COVER UNLESS OTHERWISE APPROVED BY THE ENGINEER.
- USE WATERTIGHT RUBBER GASKETS IN ALL PIPE JOINTS. 3. BEDDING MATERIAL SHALL BE INSTALLED A MINIMUM OF 12"
- ABOVE THE TOP OF ALL PLASTIC PIPES AND PIPES 48" IN DIAMETER AND LARGER.
- 4. EXCAVATION, BEDDING MATERIAL AND BACKFILL ARE INCLUDED IN CONTRACT UNIT PRICE BID FOR "CULVERT" OF THE TYPE

TYPICAL TRENCH DETAIL (STORM SEWER)

NOT TO SCALE

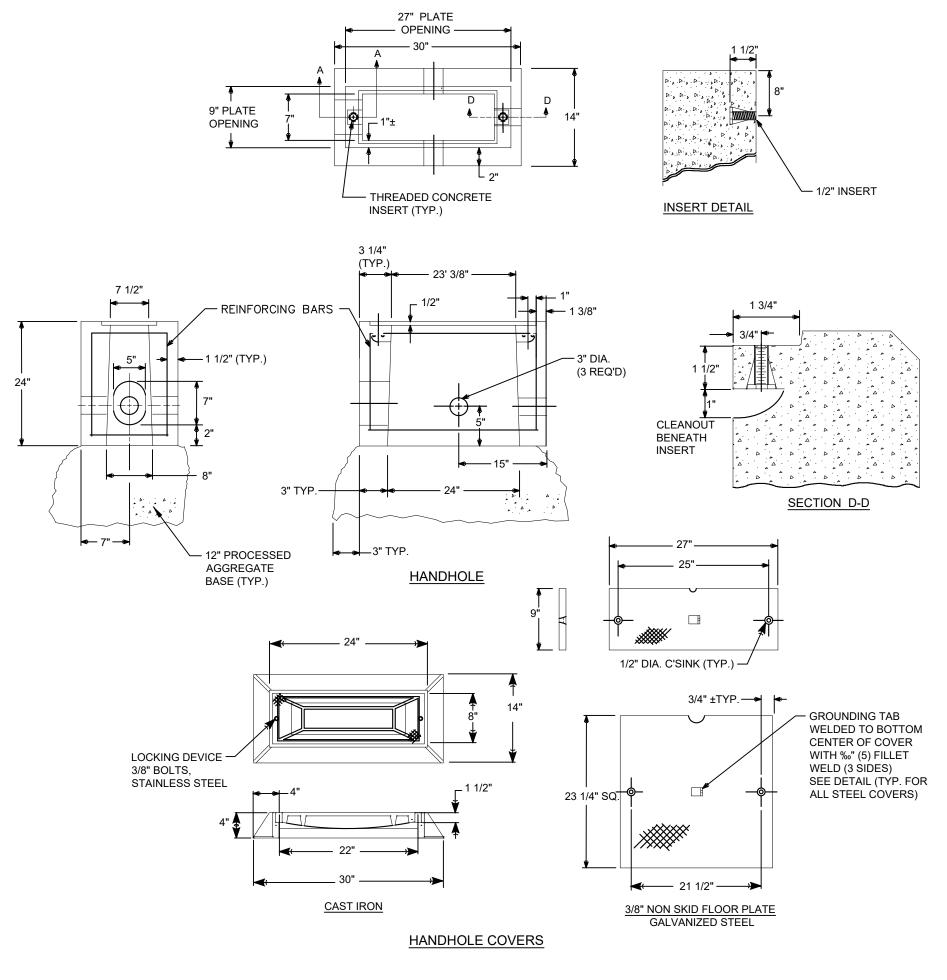


NOTES: 1. BLOCK UNUSED OPENINGS OF HANDHOLE ON THE OUTSIDE WITH PRESSURE TREATED PLYWOOD. 2. GROUT AROUND ALL CONDUITS.

- USE 1 1/2" X 3/8" CONCRETE INSERT. STANDARD THREAD, STAINLESS STEEL, FLAT HEAD
- BOLT, RÉCESSED'IN PLATE COVER. INSERTS TO HAVE CLEANOUTS.
- 4. TYPE II HANDHOLE 30" SIDE INSTALLED PARELLEL TO ROAD UNLESS OTHERWISE NOTED.
- 5. CAST THE WORD "IRRIGATION" INTO TOP EDGE OF HANDHOLE, 1 1/2" LETTERS.
 6. WHERE AN EXISTING CONCRETE SIDEWALK SLAB ABUTTING A HANDHOLE IS DAMAGED OR CUT DURING INSTALLATION THE ENTIRE SECTION SHALL BE REPLACED.
 7. 12-#3 REINFORCING BARS REQUIRED FOR ALL HANDHOLES.

CONCRETE HANDHOLE


NOT TO SCALE

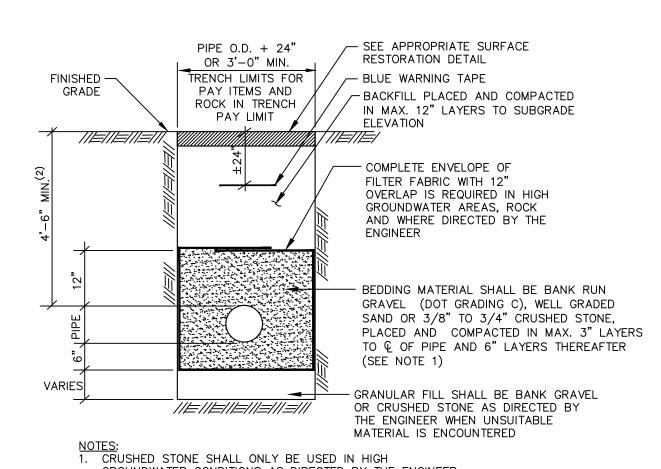

GROUNDWATER CONDITIONS AS DIRECTED BY THE ENGINEER. 2. ALL WATER MAIN WITH LESS THAN 4'-6" OF COVER SHALL BE INSULATED UNLESS APPROVED OTHERWISE BY THE ENGINEER. SEE TYPICAL TRENCH DETAIL (INSULATED WATER) FOR ADDITIONAL INFORMATION.

TYPICAL TRENCH DETAIL (WATER)

NOT TO SCALE

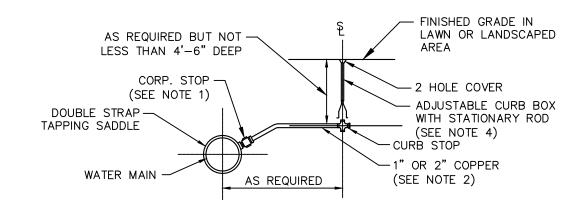

- NOTES:

 1. THE TOP OF THE CORPORATION AND THE FIRST THREE (3) FEET OF COPPER TUBING SHALL

 WATER MAIN BE INSTALLED NO HIGHER THAN THE TOP OF THE WATER MAIN. 2. NO INTERMEDIATE SIZES (i.e. 3/4", 1 1/2", 1 3/4") ARE ALLOWED FOR COPPER SERVICES.
 ANY SERVICE REQUIREMENT GREATER THAN 2" COPPER SHALL BE CLDIP (4" MIN.) WITH THE SHUT-OFF LOCATED AT THE MAIN. COPPER TUBING SHALL BE CONTINUOUS WITH NO COUPLINGS BETWEEN THE CORPORATION STOP AND THE CURB STOP.
- 3. IN GENERAL, ALL EXISTING SERVICES THAT ARE CONSTRUCTED OF MATERIALS OTHER THAN COPPER TUBING BETWEEN THE CURB STOP AND METER SHALL BE REPLACED UNLESS
- DIRECTED OTHERWISE BY THE ENGINEER. 4. TOP SECTION OF VALVE BOX WITH FLANGE SHALL BE SET AT FINISHED GRADE OVER CURB STOP COVER WHEN LOCATED WITHIN PAVED AREAS AND SIDEWALK.

TYPICAL WATER SERVICE CONNECTION

NOT TO SCALE



TOWN OF MANCHESTER PUBLIC WORKS DEPARTMENT **ENGINEERING DIVISION** 494 MAIN STREET - P.O. BOX 191 MANCHESTER, CT 06045-0191

LEGEND			
= WETLANDS BOUNDARY	\$	= LIGHT POLE	
= RETAINING WALL	*	= CONIFEROUS	
GUIDE RAIL	8	= DECIDUOUS	
STONE WALL		= SANITARY M	
	0	= DRAINAGE N	
×× = WIRE FENCE		= CATCH BAS	
o	Δ	= CULVERT EN	
= PROPERTY LINE	敠	= HYDRANT	
= RAILROAD TRACKS	es .	= CURB STOP	
	U	= WATER VALV	
■ = CONCRETE MONUMENT		- WATER VAL	
	BV	= BUTTERFLY	

= GRANITE MONUMEN O = BLOW OFF O = IRON PIPE O = SIGN o o = DOUBLE POST SIGN M = MAIL BOX = DRILL HOLE = BOLLARD UTILITY POLE = CONTROLLER CABINE دكر = UTILITY POLE WITH LIGH O = GAS GATE T = TELEPHONE BOX E = ELECTRIC BOX = WETLAND FLAG

> PROJECT NUMBER 2021078

FILENAME 2021078-PLAN-PZC.DWG

NO.	DATE	FILE	
_	03/15/24	PZC PERMIT SUBMISSION	

CHECKED BY: JL RELEASED BY: TB

DRAWN BY:

DATUM HORIZONTAL: NAD83 VERTICAL: NAVD88

PROJECT LOCATION

CHARTER OAK STREET MANCHESTER, CT

PROJECT TITLE

PARK IMPROVEMENTS CHARTER OAK WEST

SHEET TITLE


DETAILS

APPROVED


PLANNING & ZONING COMMISSION

MANCHESTER, CT.


SHEET NUMBER

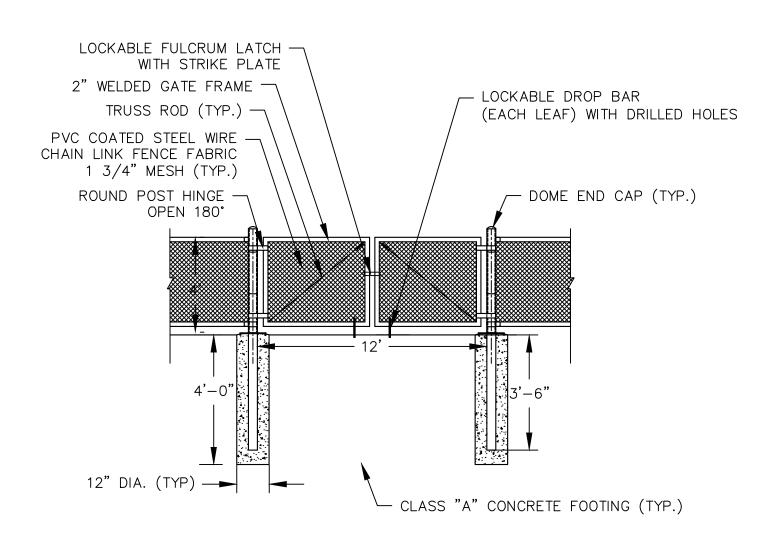


4" HIGH CHAIN LINK DOUBLE GATE NOT TO SCALE

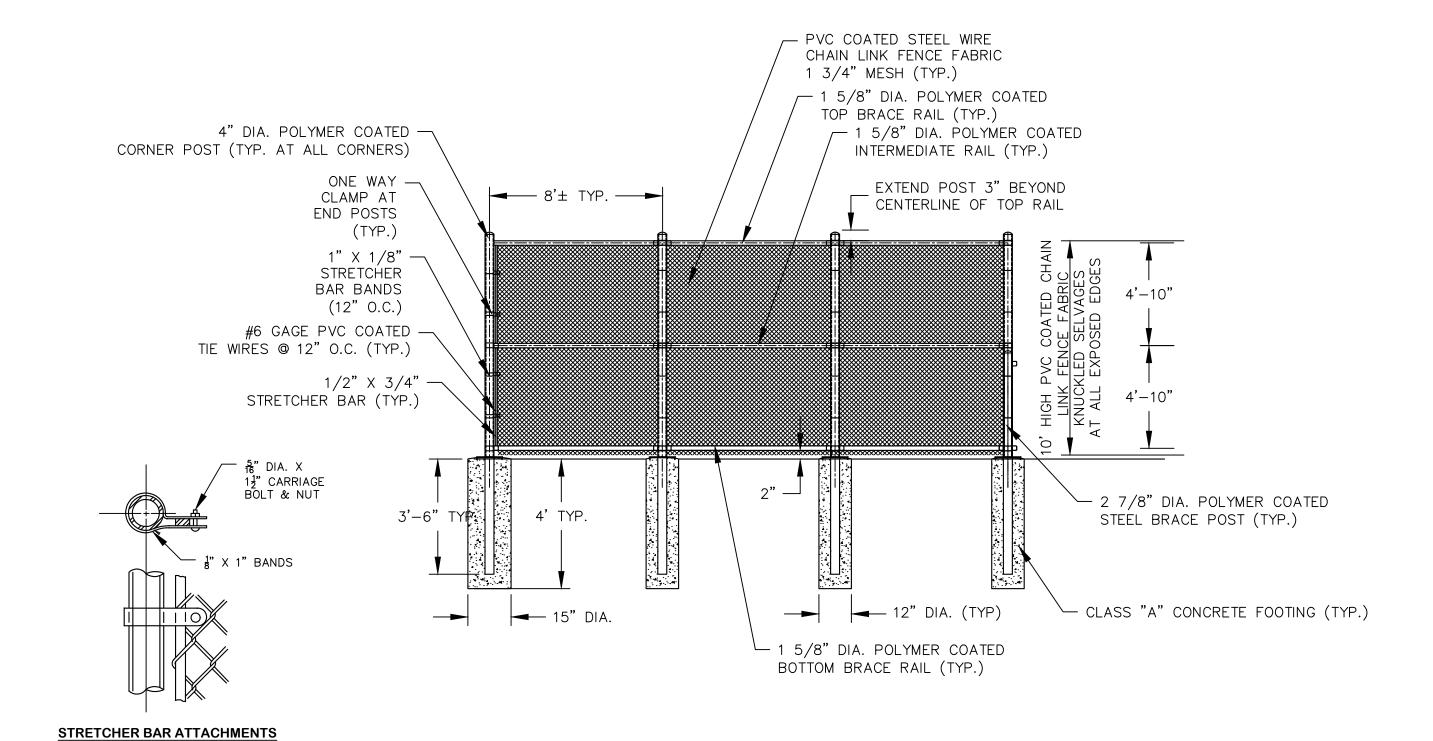

10' HIGH CHAIN LINK FENCE NOT TO SCALE

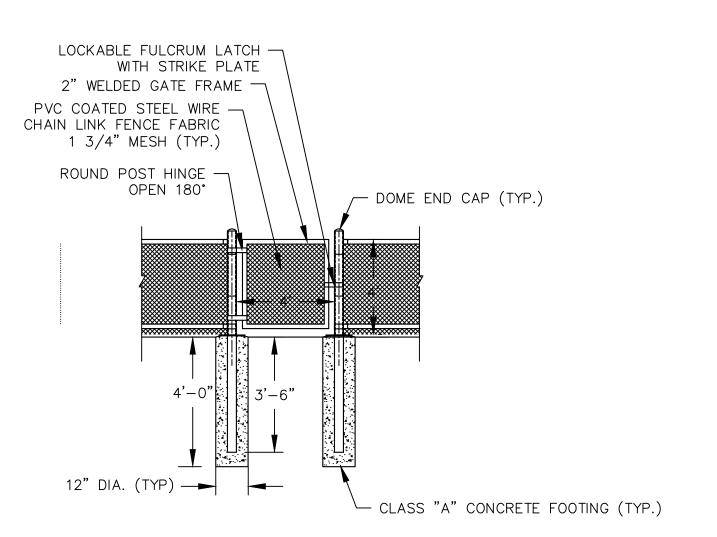

4" HIGH CHAIN LINK SINGLE GATE NOT TO SCALE

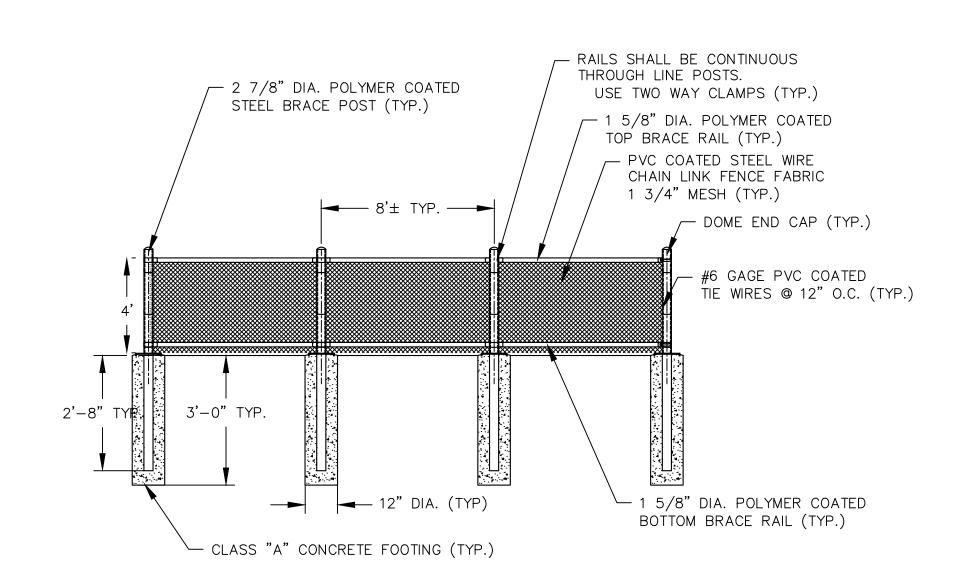

4" HIGH CHAIN LINK FENCE NOT TO SCALE

APPROVED PLANNING & ZONING COMMISSION MANCHESTER, CT.

SIGNED:_



TOWN OF MANCHESTER PUBLIC WORKS DEPARTMENT ENGINEERING DIVISION 494 MAIN STREET - P.O. BOX 191 MANCHESTER, CT 06045-0191

	LE	GEND	
	LE - WETLANDS BOUNDAR - RETAINING WALL - GUIDE RAIL - STONE WALL - STOCKADE FENCE - WIRE FENCE - CHAIN LINK FENCE - PROPERTY LINE - RAILROAD TRACKS - SILT FENCE - CONCRETE MONUME	TY	= LIGHT POLE = CONIFEROUS TREE = DECIDUOUS TREE = SANITARY MANHOLE = DRAINAGE MANHOLE = CATCH BASIN = CULVERT END = HYDRANT = CURB STOP = WATER VALVE
•	= GRANITE MONUMENT	T ₩ BO	BUTTERFLY VALVEBLOW OFF
0		Bo O	
۵	= CONTROL POINT		= DOUBLE POST SIGN = MAIL BOX

= SIGN = DOUBLE POST SIGN] = MAIL BOX • = BOLLARD O = GAS GATE T = TELEPHONE BOX E = ELECTRIC BOX = WETLAND FLAG

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NO.	DATE	FILE
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CHECKED BY: JL RELEASED BY: TB

DRAWN BY:

DATUM HORIZONTAL: NAD83 VERTICAL: NAVD88 PROJECT LOCATION

CHARTER OAK STREET MANCHESTER, CT


PROJECT TITLE

PARK IMPROVEMENTS CHARTER OAK WEST

SHEET TITLE


DETAILS

SHEET NUMBER

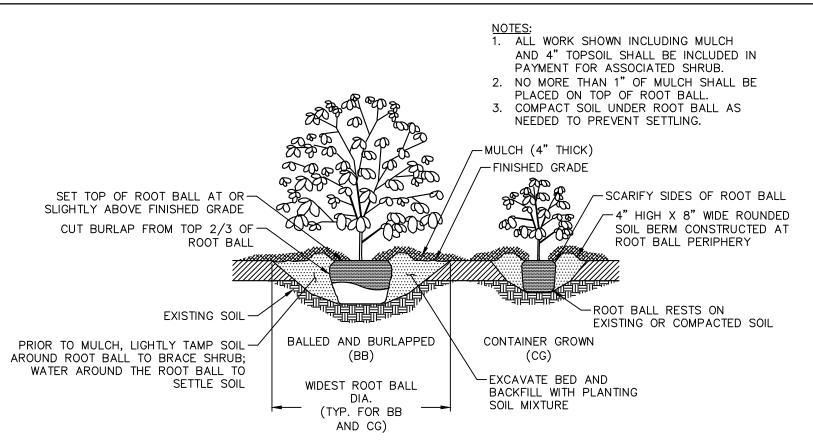


SHRUB PLANTING

NOT TO SCALE

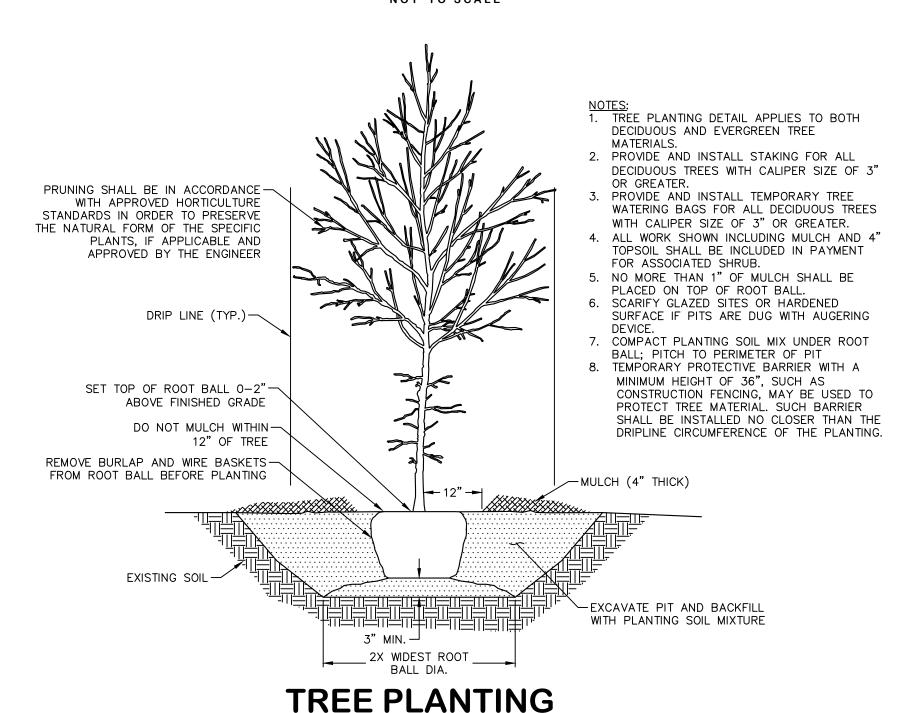


NOT TO SCALE

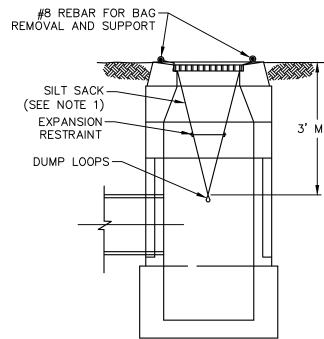

1. SILT SACKS SHALL BE HI-FLOW SILTSACK® 'TYPE A' FOR TYPE "C-L" CB TOPS AND 'TYPE B' WITH CURB DEFLECTORS FOR TYPE "C" CB TOPS OR OTHER STRUCTURES WITH CURB INLETS AS

MANUFACTURED BY ACF ENVIRONMENTAL, INC OR APPROVED EQUAL SILT SACKS SHALL BE PROVIDED WITH INTERNAL OVERFLOWS. 3. SILT SACKS SHALL BE EMPTIED WHEN THEY HAVE COLLECTED 6" TO 12" OF SEDIMENT. INSPECT EVERY 1 TO 2 WEEKS AND AFTER EVERY MAJOR RAINFALL EVENT.

> SILT SACK NOT TO SCALE

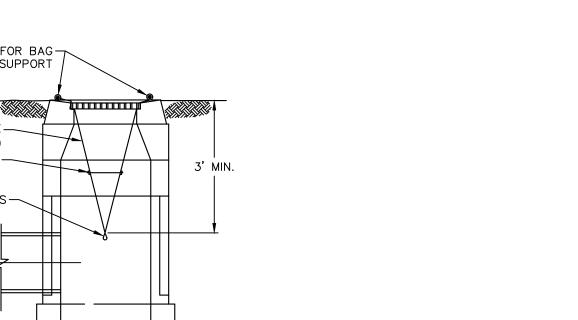

CONSTRUCTION ENTRANCE

EDGE OF PAVEMENT

– SEE PLAN FOR LENGTH –

SECTION A-A

SEE PLAN

FILTER FABRIC-

6" OF 2" CRUSHED STONE-


2 22 22


SITE ENTRANCE DRIVE -

2 1/2" BITUMINOUS CONCRETE -

CLASS 1 WITH 2" LIP

NOT TO SCALE

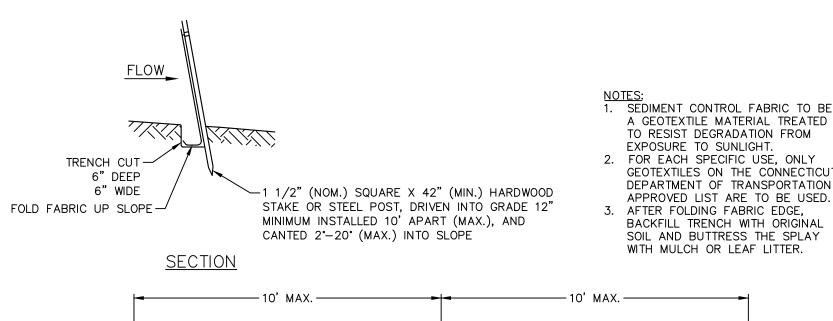

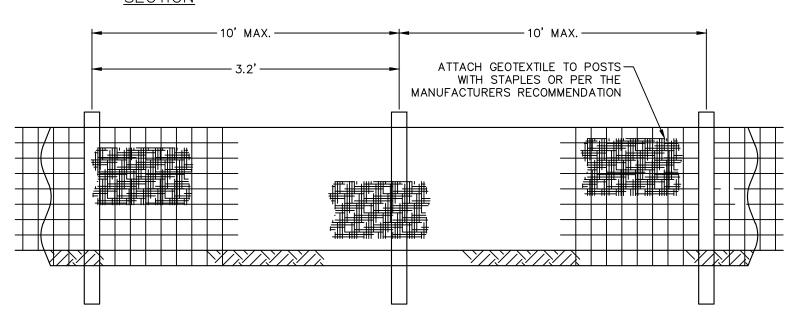

ELEVATION

SILT FENCE NOT TO SCALE

PROJECT NOTES

- 1. ALL MATERIALS AND METHODS OF CONSTRUCTION SHALL BE IN ACCORDANCE WITH THE "MANCHESTER PUBLIC IMPROVEMENT STANDARDS", EFFECTIVE OCTOBER 31, 2020, AS AMENDED AND THE STATE OF CONN. DEPT. OF TRANSPORTATION STANDARD SPECIFICATIONS FOR ROADS, BRIDGES, FACILITIES AND INCIDENTAL CONSTRUCTION, FORM 818, DATED 2020, INCLUDING ANY SUPPLEMENTS.
- 2. ALL ELEVATIONS ARE BASED ON THE TOWN OF MANCHESTER CONTROL NETWORK.
- 3. IMPLEMENTING WORKER SAFETY AND HEALTH PROTOCOLS THAT ADDRESS COMPLIANCE WITH ALL RULES, LAWS AND REGULATIONS REGARDING SAFETY AND RISK OF EXPOSURE TO PHYSICAL AND CHEMICAL HAZARDS IS THE SOLE RESPONSIBILITY OF THE CONTRACTOR. ALL EMPLOYEES OF THE CONTRACTOR AND SUBCONTRACTORS ARE TO WEAR REFLECTIVE VESTS AND HARD HATS AT ALL TIMES WHEN ON THE PROJECT SITE.
- 4. A PRECONSTRUCTION MEETING WITH TOWN STAFF IS REQUIRED PRIOR TO THE START OF ANY CONSTRUCTION ACTIVITY.
- 5. IT IS ANTICIPATED THAT IMPROVEMENTS IDENTIFIED ON THE PLANS AS BEING COMPLETED "BY OTHERS" WILL BE DONE PRIOR TO OR AT THE BEGINNING STAGES OF CONSTRUCTION.
- 6. THE CONTRACTOR SHALL TAKE CARE NOT TO DISTURB EXISTING MONUMENTATION THAT MAY BE PRESENT NEAR THE PROJECT AREA.
- 7. THE CONTRACTOR IS RESPONSIBLE TO OBTAIN ALL REQUIRED PERMITS AND PAY ASSOCIATED FEES PRIOR TO ANY CONSTRUCTION ACTIVITY. THE CONTRACTOR MUST OBTAIN AN ENCROACHMENT PERMIT FROM THE STATE OF CONNECTICUT, DEPARTMENT OF TRANSPORTATION, PRIOR TO BEGINNING WORK WITHIN THE CHARTER OAK STREET RIGHT-OF-WAY AND SHALL BE RESPONSIBLE FOR ALL ASSOCIATED FEES AND REQUIREMENTS.

- 8. THE CONTRACTOR SHALL COMMIT SUFFICIENT RESOURCES TO THE PROJECT TO ENSURE THE PROJECT IS COMPLETED WITHIN THE ALLOTTED CONTRACT TIME. ONCE MOBILIZED, THE CONTRACTOR SHALL WORK CONTINUOUSLY ON THE PROJECT UNTIL COMPLETION. ANY UNAUTHORIZED VACATING OF THE JOBSITE IS SUBJECT TO PENALTIES DESCRIBED UNDER THE "LIQUIDATED DAMAGES" SECTION OF THE CONTRACT SPECIFICATIONS.
- CONSTRUCTION ENTRANCES SHALL BE INSTALLED WHERE SHOWN ON THE ADJUSTED TO FIT EXISTING FIELD CONDITIONS WITH THE APPROVAL OF PLANS OR WHERE DIRECTED BY THE ENGINEER DURING CONSTRUCTION. ALL CONSTRUCTION TRAFFIC SHALL ACCESS AND EXIT THE SITES OVER CONSTRUCTION ENTRANCES. CONTRACTOR SHALL PROVIDE TEMPORARY 15. THE CONTRACTOR SHALL IMMEDIATELY NOTIFY THE ENGINEER IF BARRIERS OR CONSTRUCTION FENCE ACROSS OTHER ACCESS LOCATIONS TO THE SITE AT NO ADDITIONAL COST.
- IN PLACE.
- 11. ALL GRASSED AREAS DISTURBED BY THE CONTRACTOR SHALL BE REPLACED WITH TOPSOIL, FERTILIZED AND SEEDED AS PER THE SPECIFICATIONS. CONTRACTOR SHALL MAKE ALL EFFORTS TO MINIMIZE THE LIMITS OF DISTURBANCE AND ASSOCIATED RESTORATION THAT IS REQUIRED.
- 12. ALL SEDIMENT CONTROL SYSTEMS SHALL MEET THE "GUIDELINES FOR SOIL EROSION AND SEDIMENT CONTROL" AS PREPARED BY THE CONNECTICUT COUNCIL ON SOIL AND WATER CONSERVATION, LATEST REVISION. THE CONTRACTOR IS RESPONSIBLE FOR THE INSTALLATION, MAINTENANCE AND REPAIR OF EROSION CONTROLS REQUIRED FOR THE 18. SURPLUS EXCAVATED MATERIAL SHALL BECOME THE PROPERTY OF THE PROJECT. ADDITIONAL EROSION CONTROLS SHALL BE INSTALLED BY THE CONTRACTOR FOR TEMPORARY STOCKPILING OF EXCAVATED MATERIAL AND WHERE DEEMED NECESSARY BY THE ENGINEER. EROSION CONTROLS SHALL REMAIN IN PLACE AND BE MAINTAINED BY THE CONTRACTOR UNTIL THE SITE IS STABILIZED AND THE ENGINEER

- APPROVES THEIR REMOVAL
- 13. SILT SACKS SHALL BE INSTALLED IN ALL EXISTING AND PROPOSED CATCH BASINS WITHIN THE PROJECT AREA AND WHERE DIRECTED BY THE ENGINEER. SILT SACKS SHALL BE THE APPROPRIATE TYPE FOR CATCH BASINS WITH AND WITHOUT CURB INLETS.
- 14. HORIZONTAL AND VERTICAL LOCATIONS OF PROPOSED WORK MAY BE THE ENGINEER.
- CONDITIONS ENCOUNTERED IN THE FIELD ARE DIFFERENT THAN INFORMATION SHOWN ON THE PLANS.
- 10. NO WORK SHALL COMMENCE UNTIL ALL CONSTRUCTION AREA SIGNS ARE 16. THE EXISTENCE OF UTILITIES AND APPURTENANCES AS SHOWN ON THESE DRAWINGS ARE FOR REFERENCE ONLY. THE EXACT SIZE, LOCATION, TYPE, AND ELEVATION OF ALL UTILITIES WITHIN ALL WORK AREAS SHALL BE THOROUGHLY INVESTIGATED BY THE CONTRACTOR PRIOR TO THE START OF CONSTRUCTION. THE CONTRACTOR SHALL BE RESPONSIBLE FOR NOTIFYING "CALL-BEFORE-YOU-DIG" AT 1-800-922-4455 AND MUST HAVE ALL UTILITIES MARKED ON THE GROUND PRIOR TO THE START OF CONSTRUCTION.
 - 17. THE QUANTITIES AS INDICATED IN THE CONTRACT DOCUMENTS ARE APPROXIMATE AND MAY NOT INDICATE THE ACTUAL QUANTITIES OF WORK REQUIRED. THE CONTRACTOR MUST VERIFY ALL QUANTITIES.
 - CONTRACTOR. THE CONTRACTOR SHALL DISPOSE OF SURPLUS EXCAVATED MATERIAL IN ACCORDANCE WITH STATE AND FEDERAL REGULATIONS.
 - 19. THE CONTRACTOR SHALL BE RESPONSIBLE FOR TEMPORARY HANDLING

- OF ALL STORMWATER RUNOFF DURING CONSTRUCTION. METHODS OF
- 20. AT THE END OF EACH WORKING DAY, THE CONTRACTOR SHALL BE MAINTAINED BY THE CONTRACTOR.
- 21. FOR CONNECTIONS TO EXISTING SANITARY SEWER STRUCTURES AND PIPING, THE CONTRACTOR SHALL VERIFY EXISTING INVERT ELEVATIONS, NOTIFY THE ENGINEER IF A DISCREPANCY EXISTS, AND ADJUST THE PIPE SLOPES AS DIRECTED.
- 22. THE CONTRACTOR SHALL BE RESPONSIBLE FOR TEMPORARY HANDLING
- NEW SANITARY FACILITIES. THE CONTRACTOR IS RESPONSIBLE FOR PROPER DISPOSAL OF ALL MATERIALS.
- 24. ALL SANITARY SEWER MANHOLES SHALL HAVE A 48" INTERNAL DIAMETER UNLESS SPECIFIED OTHERWISE ON THE PLANS.
- 25. ALL NEW WATER MAINS AND SERVICES SHALL HAVE 4.5 FEET OF COVER UNLESS OTHERWISE INDICATED ON THE PLANS. COVER LESS THAN OR IN EXCESS OF 4.5 FEET SHALL BE ALLOWED ONLY WHERE INDICATED ON THE PLANS OR APPROVED BY THE ENGINEER. WATER MAINS AND SERVICES WITH COVER LESS THAN 4.5 FEET SHALL BE INSULATED UNLESS APPROVED OTHERWISE BY THE ENGINEER.
- 26. THE CONTRACTOR SHALL BE RESPONSIBLE FOR PROVIDING ANY TEMPORARY THRUST RESTRAINT THAT IS REQUIRED.

HANDLING RUNOFF SHALL BE APPROVED BY THE ENGINEER.

- RESPONSIBLE FOR CONNECTING NEW DRAINAGE SYSTEMS TO EXISTING. ALL DRAINAGE SYSTEMS WITHIN THE CONSTRUCTION LIMITS SHALL BE
- OF ALL SEWAGE FLOWS DURING CONSTRUCTION. METHODS OF HANDLING SEWAGE FLOWS SHALL BE APPROVED BY THE ENGINEER.
- 23. AT THE END OF EACH WORKING DAY, THE CONTRACTOR SHALL BE RESPONSIBLE FOR CONNECTING EXISTING SANITARY SEWER LATERALS TO

TOWN OF MANCHESTER

PUBLIC WORKS DEPARTMENT **ENGINEERING DIVISION** 494 MAIN STREET - P.O. BOX 191

LEGEND = WETLANDS BOUNDARY = CONIFEROUS TREE

= DECIDUOUS TREE

MANCHESTER, CT 06045-0191

x----x = WIRE FENCE o----o = CHAIN LINK FENC ---- = PROPERTY LIN

💥 = HYDRANT = RAILROAD TRACKS CS = CURB STOP WX = WATER VALVE BV = BUTTERFLY VALV = GRANITE MONUMENT O = BLOW OFF O = IRON PIPE

- = SIGN = IRON ROD O O = DOUBLE POST SIG M = MAIL BOX = BOLLARD UTILITY POL = CONTROLLER CABIN = UTILITY POLE WITH

G = GAS GATE T = TELEPHONE BOX FT = ELECTRIC BOX A = WETLAND FLAG ⊕ CATV TUBE

PROJECT NUMBER

2021078

FILENAME 2021078-PLAN-PZC.DWG

NO.	DATE	FILE
_	03/15/24	PZC PERMIT SUBMISSION

DRAWN BY: CHECKED BY: JI

RELEASED BY: TB

HORIZONTAL: NAD83 VERTICAL: NAVD88

DATUM

PROJECT LOCATION

CHARTER OAK STREET

PROJECT TITLE

PARK IMPROVEMENTS **CHARTER OAK WEST**

SHEET TITLE

DETAILS


APPROVED


PLANNING & ZONING


COMMISSION

MANCHESTER, CT.

SHEET NUMBER

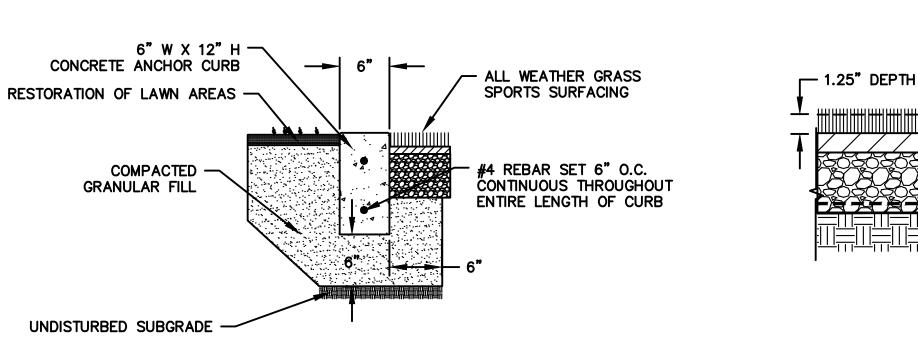

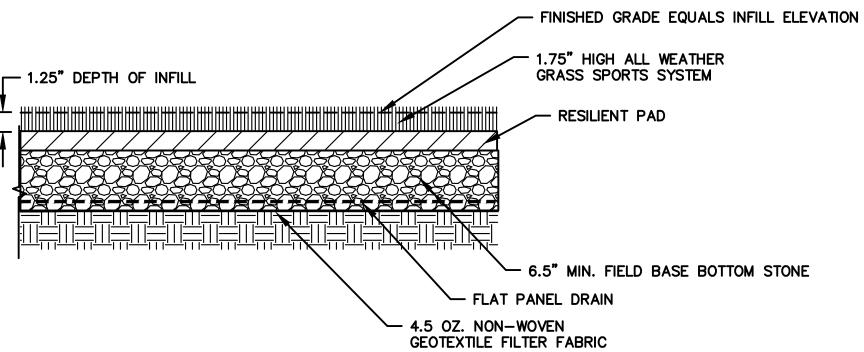

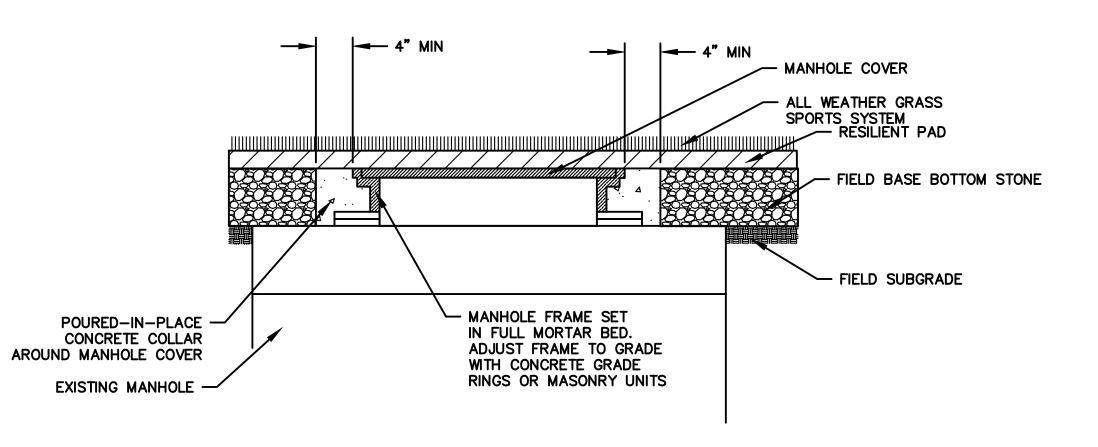


CONCRETE ANCHOR CURB

NOT TO SCALE

ALL WEATHER GRASS SPORTS SURFACE

NOT TO SCALE

MANHOLE IN ALL WEATHER GRASS NOT TO SCALE

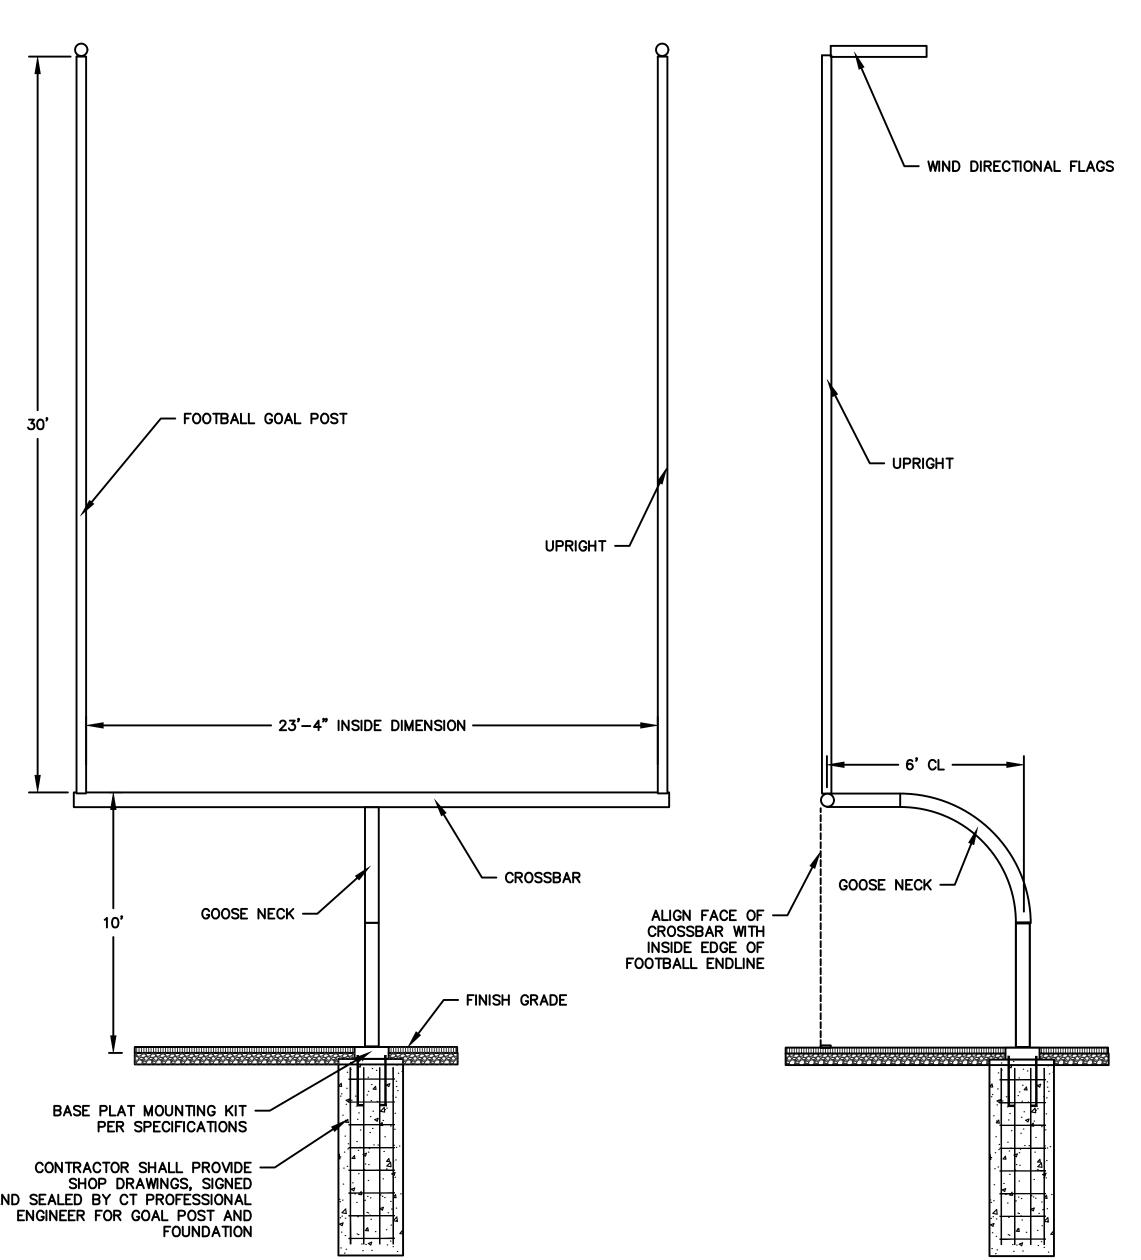


FOOTBALL GOAL POST

NOT TO SCALE

—— 20 O.C. ——- - ALL WEATHER
GRASS SPORTS SYSTEM - RESILIENT PAD - FIELD BASE BOTTOM STONE - 4.5 OZ. NON-WOVEN GEOTEXTILE FILTER FABRIC - FLAT PANEL DRAIN LAID FLAT ON GEOTEXTILE FABRIC AND SECURED WITH 60 PENNY PINS

FLAT PANEL DRAIN NOT TO SCALE

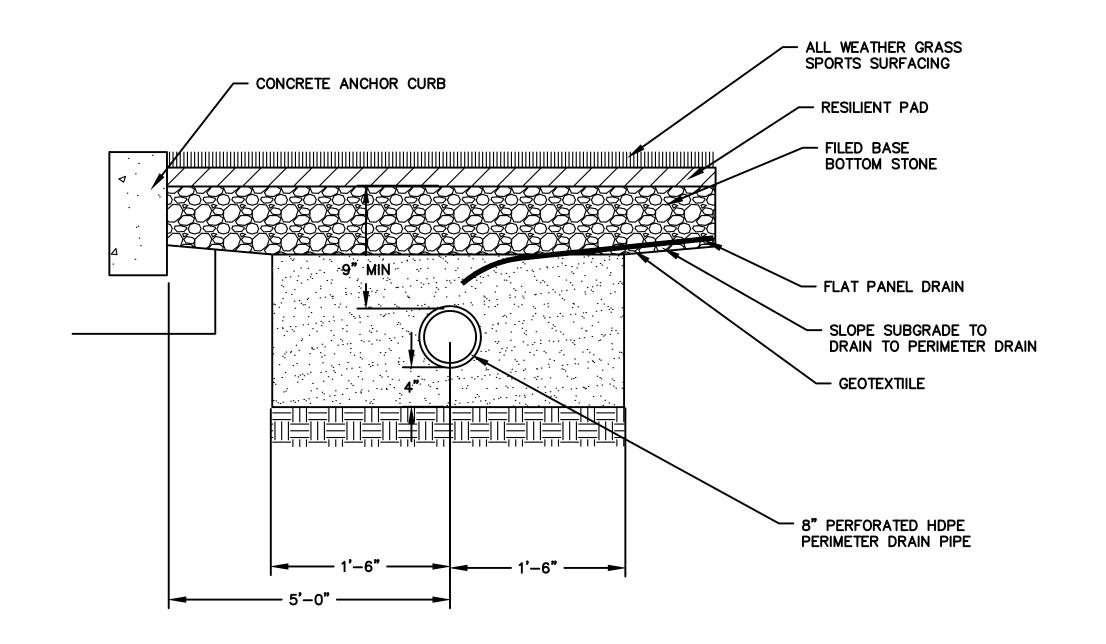

FIELD PERIMETER **COLLECTION DRAIN** NOT TO SCALE

APPROVED PLANNING & ZONING COMMISSION MANCHESTER, CT.



TOWN OF MANCHESTER PUBLIC WORKS DEPARTMENT ENGINEERING DIVISION 494 MAIN STREET - P.O. BOX 191 MANCHESTER, CT 06045-0191

LEGEN	טו
= WETLANDS BOUNDARY	
= RETAINING WALL	= CONIFEROUS TREE
GUIDE RAIL	= DECIDUOUS TREE
STONE WALL	S = SANITARY MANHOLE
	= DRAINAGE MANHOLE
xx = WIRE FENCE	= CATCH BASIN
oo = CHAIN LINK FENCE	△ = CULVERT END
= PROPERTY LINE	¥ = HYDRANT
= RAILROAD TRACKS	CS = CURB STOP
SF = SILT FENCE	WV = WATER VALVE
= CONCRETE MONUMENT	
■ = GRANITE MONUMENT	BV = BUTTERFLY VALVE
O = IRON PIPE	O = BLOW OFF
● ■ IRON ROD	o = SIGN
A = CONTROL POINT	o o = DOUBLE POST SIGN
= DRILL HOLE	M = MAIL BOX
C) = UTILITY POLE	• = BOLLARD
*	= CONTROLLER CABINET
= UTILITY POLE WITH LIGHT	O = GAS GATE
TRAFFIC SPAN POLE	T = TELEPHONE BOX
E = ELECTRIC BOX	_
\triangle = Wetland Flag	⊕ CATV TUBE

PROJECT NUMBER 2021078

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DRAWN BY: CHECKED BY: JL RELEASED BY: TB

DATUM HORIZONTAL: NAD83 VERTICAL: NAVD88

PROJECT LOCATION

CHARTER OAK STREET MANCHESTER, CT

PROJECT TITLE


PARK IMPROVEMENTS CHARTER OAK WEST


SHEET TITLE

DETAILS

SHEET NUMBER

15 of 16

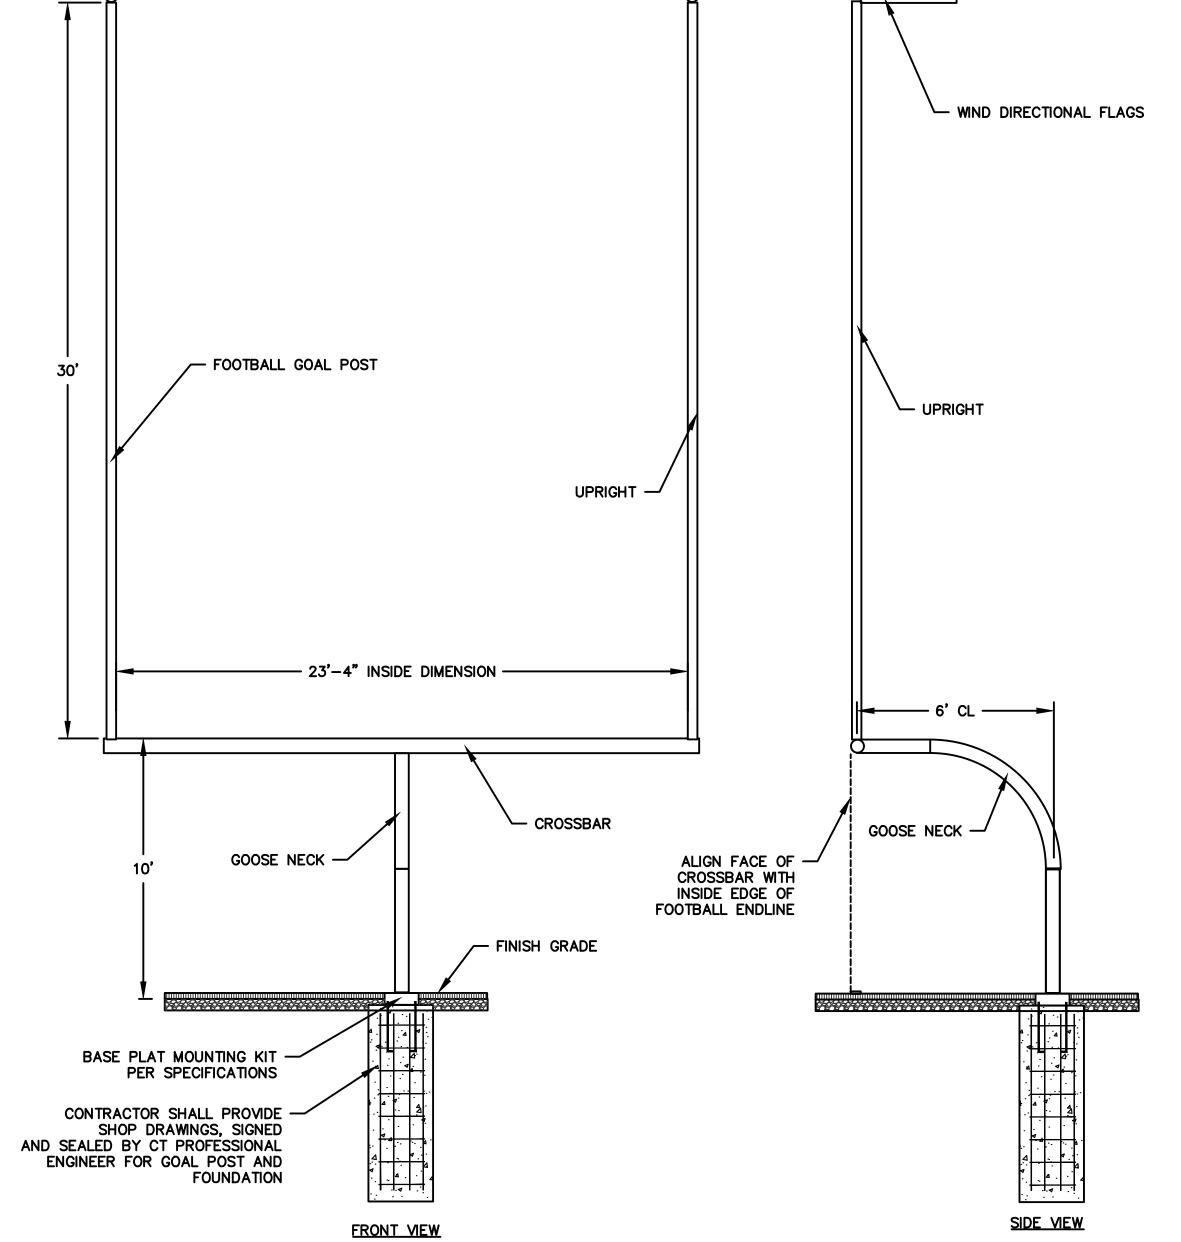

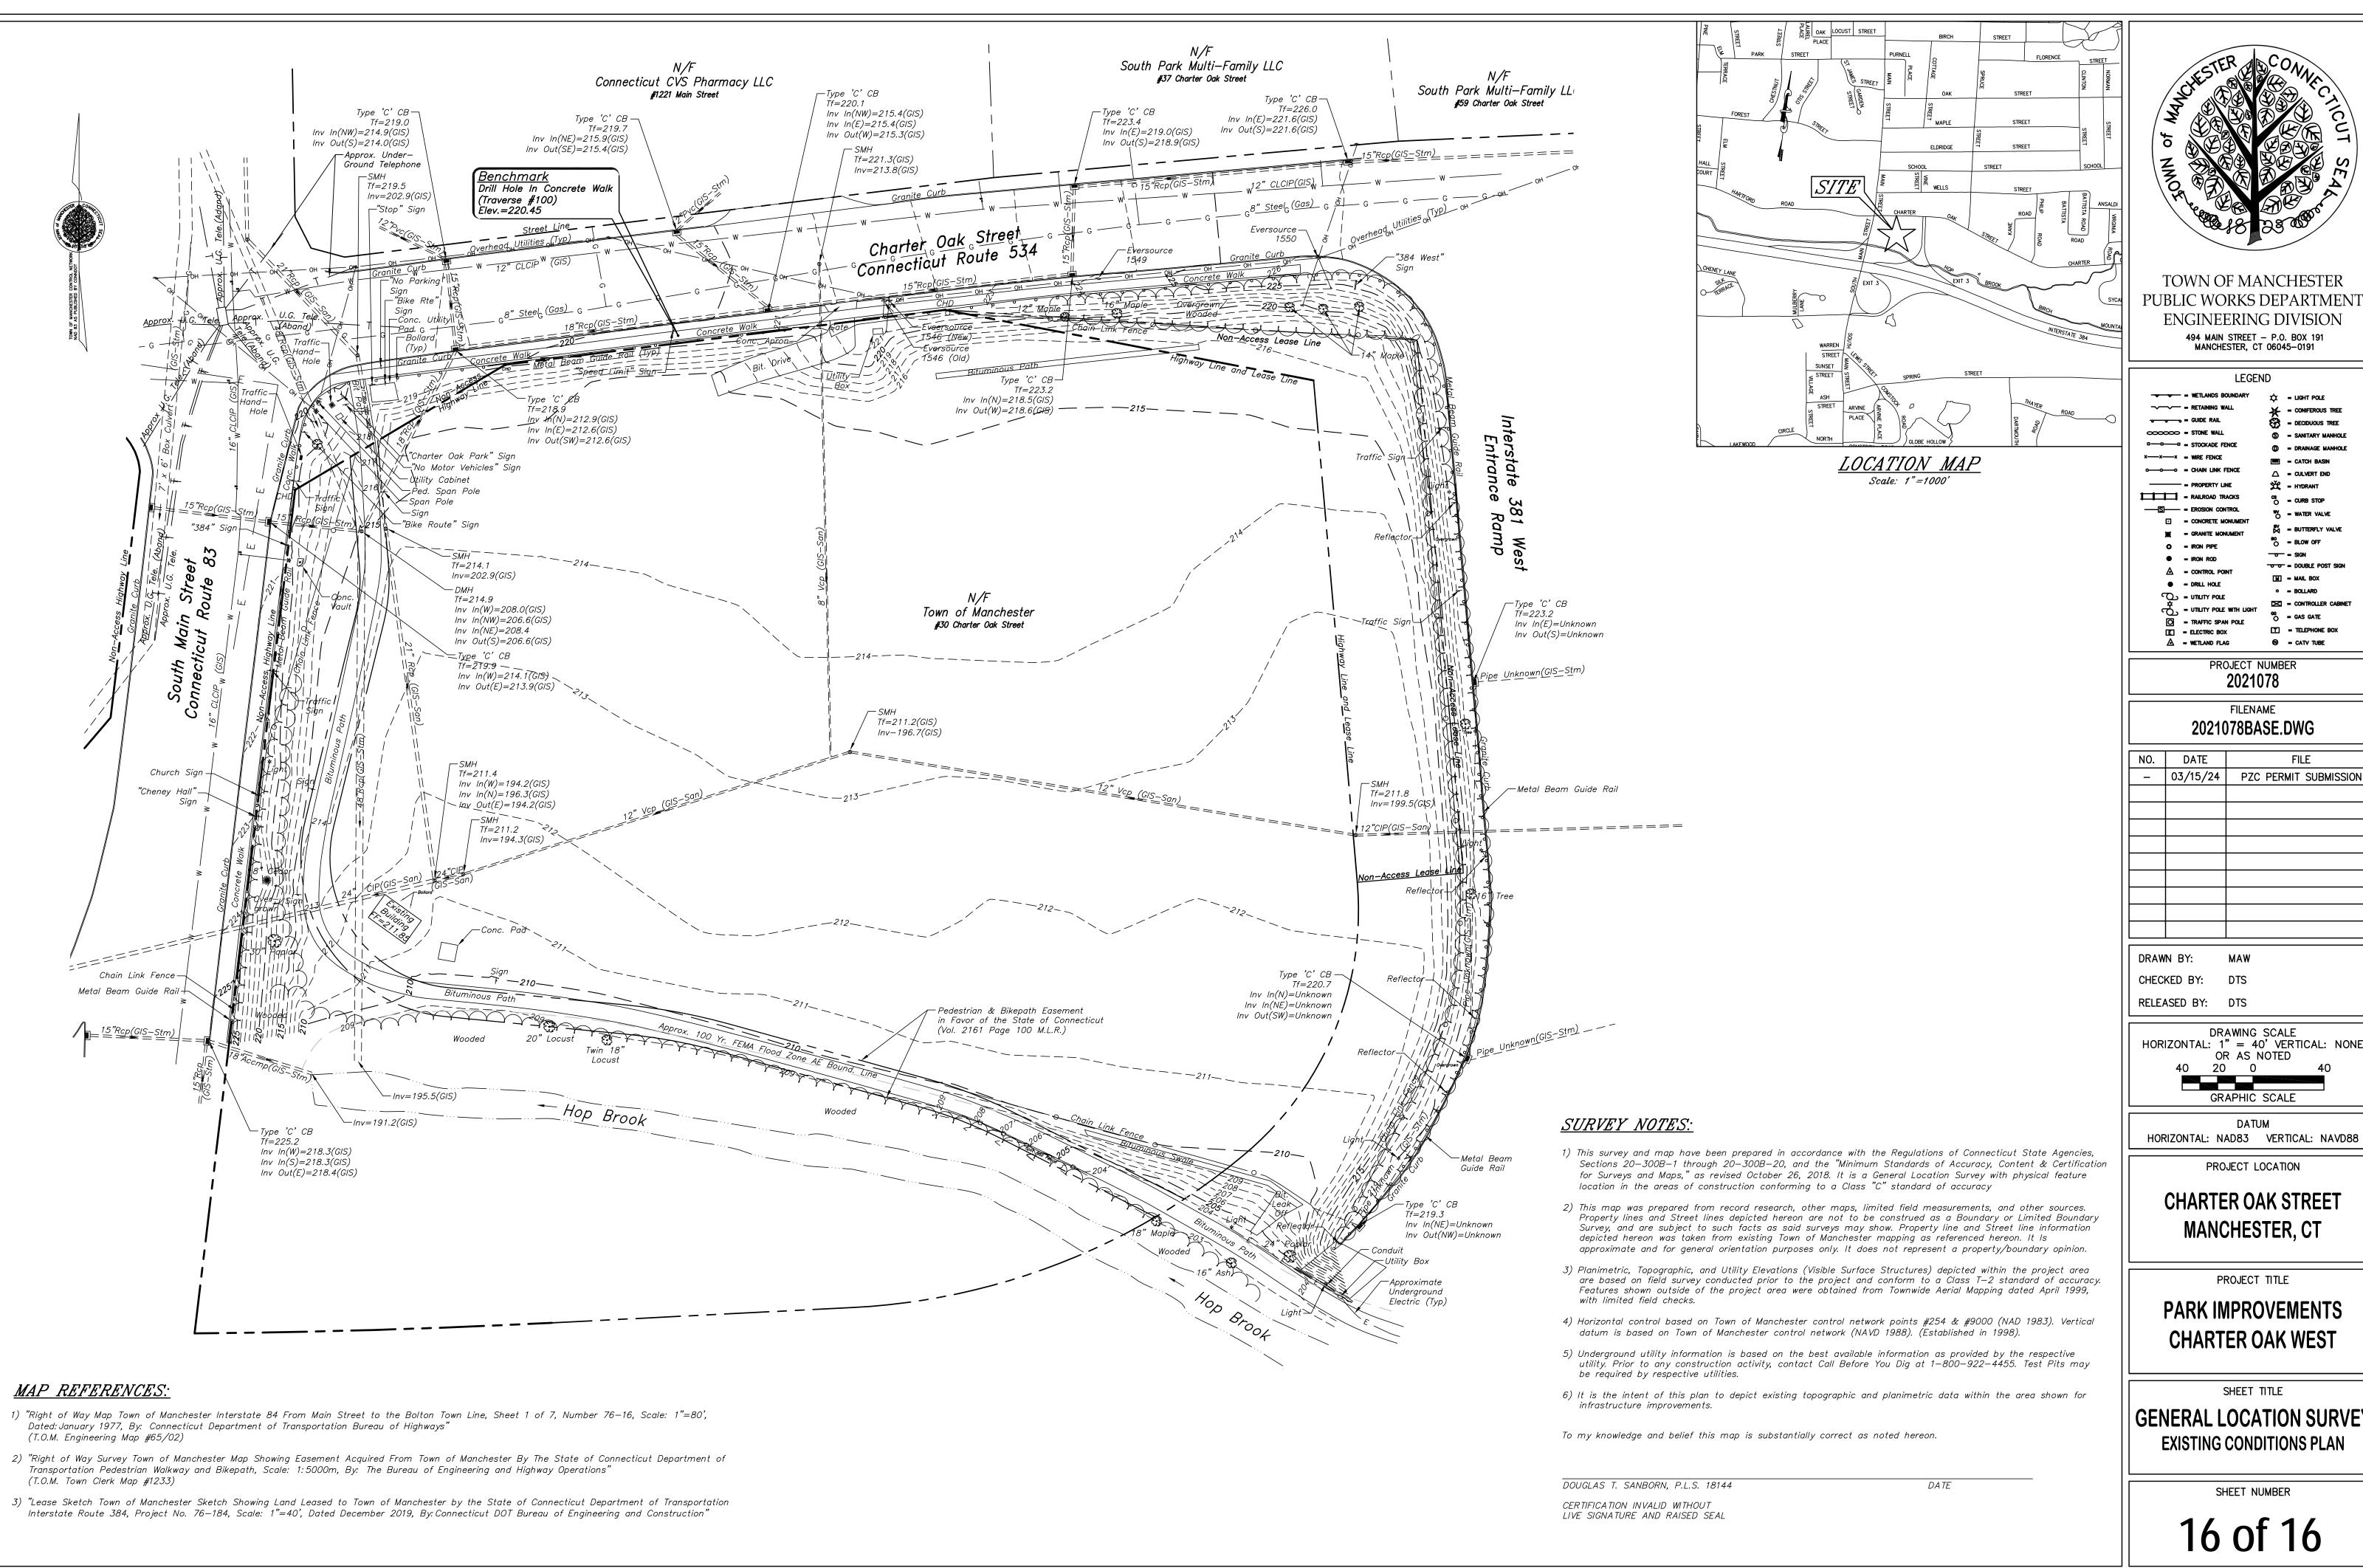



TOWN OF MANCHESTER PUBLIC WORKS DEPARTMENT **ENGINEERING DIVISION** 494 MAIN STREET - P.O. BOX 191 MANCHESTER, CT 06045-0191

LEGEND			
= WETLANDS B	OUNDARY	☆	= LIGHT POLE
= RETAINING W	ALL	*	= CONIFEROUS TREE
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= STOCKADE F	ENCE	0	- DRAINAGE MANHOLE
			= CATCH BASIN
= CHAIN LINK	FENCE	Δ	= CULVERT END
= PROPERTY L	INE	從	= HYDRANT
= RAILROAD TE	RACKS	ဇန	= CURB STOP
= EROSION COI	NTROL	w	- WATER VALVE
■ CONCRETE M	ONUMENT	_	
= GRANITE MOI	NUMENT	S N	= BUTTERFLY VALVE
O = IRON PIPE		0	= BLOW OFF
	•		= SIGN

 = WETLAND FLAG PROJECT NUMBER

- UTILITY POLE WITH LIGHT

FILENAME

2021078

O O = DOUBLE POST SIGN

M = MAIL BOX

G = GAS GATE

2021078BASE.DWG

NO.	DATE	FILE
_	03/15/24	PZC PERMIT SUBMISSION
DRAWN BY:		MAW
CHEC	KED BY:	DTS

RELEASED BY: DTS DRAWING SCALE HORIZONTAL: 1" = 40' VERTICAL: NONE

GRAPHIC SCALE

OR AS NOTED

PROJECT LOCATION

CHARTER OAK STREET MANCHESTER, CT

PROJECT TITLE

PARK IMPROVEMENTS **CHARTER OAK WEST**

SHEET TITLE

GENERAL LOCATION SURVEY **EXISTING CONDITIONS PLAN**

SHEET NUMBER

16 of 16

TOWN OF MANCHESTER PLANNING AND ECONOMIC DEVELOPMENT DEPARTMENT

TO: Planning & Zoning Commission

Megan Pilla, Principal Development Planner FROM:

DATE: March 28, 2024

RE: Discussion – Open space acquisition process

Introduction

The attached draft of a proposed resolution regarding the open space acquisition process has been provided for discussion by Commissioner Farina.

Staff will provide feedback at the April 1, 2024 meeting.

 $\label{eq:mp} mp \\ R:\Planning\PZC\2024\04 - April\ 01\Packet\Land\ Acquisition - Memo.docx$

Attach.

Manchester Planning and Zoning Commission Resolution to Create a Plan of Open Space Acquisition and Greenways Protection and Development

WHEREAS, the Town of Manchester is committed to preserving and protecting its natural resources and open spaces for the benefit of its residents and future generations; and

WHEREAS, open space acquisition is a stated goal of the Town of Manchester Plan of Conservation and Development; and

WHEREAS, the Town of Manchester Planning and Zoning Commission may make recommendations for the implementation of the Plan of Conservation and Development [Sec. 8-23. (f) (6)]; and

WHEREAS, the Town of Manchester Planning and Zoning Commission may make plans for open space acquisition and greenways protection and development [Sec. 8-23. (f) (6) (E)]; and

WHEREAS, no current Planning and Zoning Commission plan for open space acquisition and greenways protection and development exists; and

WHEREAS, whereas the Planning and Zoning Commission desires a plan for open space acquisition and greenways protection and development:

NOW, THEREFORE, BE IT RESOLVED that the Planning and Zoning Commission of the Town of Manchester shall create a Plan of Open Space Acquisition and Greenways Protection and Development; and

BE IT FURTHER RESOLVED that the Planning and Zoning Commission of the Town of Manchester shall appoint a subcommittee of [3–4] commissioners to draft a Plan of Open Space Acquisition and Greenways Protection and Development; and

BE IT FURTHER RESOLVED that the subcommittee shall take into consideration the recommendations of, but not limited to, the Conservation Commission, Advisory Recreation and Parks Commission, the Hockanum River Trail Committee, the Manchester Land Conservation Trust, and the Manchester Land Acquisition and Historical Preservation Committee; and

BE IT FURTHER RESOLVED that the Plan of Open Space Acquisition and Greenways Protection and Development shall include explicit goals consistent with the Town of Manchester Plan of Conservation and Development; and

BE IT FURTHER RESOLVED that the Plan of Open Space Acquisition and Greenways Protection and Development shall include recommendations for implementation of the plan,

including but not limited to timelines, amount of land to be purchased, funds to be expended annually, and funding mechanisms such as referenda and grants; and

BE IT FURTHER RESOLVED that the subcommittee shall present a draft plan to the Planning and Zoning Commission for review by Sept 16, 2024, which may debate and modify the plan directly, or return the plan to the subcommittee for additional work, to be finalized and presented no later than December 9, 2024.

ADOPTED this [day] of [month], 2024.
PLANNING AND ZONING COMMISSION OF THE TOWN OF MANCHESTER
Ву:
Chair

TOWN OF MANCHESTER PLANNING AND ECONOMIC DEVELOPMENT DEPARTMENT

TO: Planning & Zoning Commission

Megan Pilla, Principal Development Planner FROM:

DATE: March 28, 2024

RE: Discussion – Municipal fines for inland wetlands violations

Introduction

The attached draft of a possible ordinance proposal has been modified from the draft originally provided by Commissioner Farina, in consultation with the Town Attorney's office.

The two (2) references to the Connecticut General Statutes that are highlighted in yellow are being confirmed, and may be updated if necessary.

Attach.

Proposed Ordinance:

Inland Wetlands Agency Citations and Fines

Article I - Authority and Purpose

This ordinance is enacted under the authority of the Connecticut General Statutes §§ 22a-36 to 22a-45, inclusive, and the Town of Manchester Charter. It aims to describe the principals and procedures associated with the enforcement and implementation of citations and/or fines associated with inland wetland violations in the Town of Manchester, Connecticut.

Article II – Definitions [Is this redundant to definitions in

Charter?] Article III - Citation Authority and Procedure

The Inland Wetlands Agent or any duly authorized person as designated by the Town Manager, of the Town of Manchester is empowered to issue citations for any violations of this ordinance. Citations may be served either by hand delivery or by certified mail, return receipt requested, to the person or entity named in the citation. Citations shall be issued for egregious violations and/or instances where the violator has failed to comply with initial notices and/or orders issued by the Inland Wetlands Agent.

Article IV - Violations and Penalties

Any activity violating the regulations set forth by this ordinance, the Inland Wetlands and Watercourses Regulations (Regulations), or any actions, activities, or requirements as included within an active approved permit, or any order issued pursuant thereto, may be subject to citation and/or fine.

Article V. Penalties for offenses; fines

- A. Violations of Wetlands Regulations.
 - (1) The following fines may be assessed by citation for a violation of the Inland Wetland and Watercourse Regulations, or any actions, activities, or requirements as included within an active approved permit, or any order issued pursuant thereto:
 - (a) For conducting, assisting, or allowing the conduct of any regulated activity within wetlands or watercourses or the 100-foot upland review area without a permit or in violation of any permit, as further defined in Section 3.5 of the Regulations: a fine of up to \$1,000 for each offense.
 - (b) For conducting, assisting, permitting the conduct of, undertaking, permitting the existence of, or allowing any regulated activity outside of an inland wetland or watercourse without a permit or in violation of any permit which causes, directly or indirectly, any alteration of the physical, chemical or biological properties of any wetland or watercourse: a fine of up to \$1,000 for each offense.
 - (c) For noncompliance with permit conditions and/or limitations or with enforcement orders, where such noncompliance is not described in Article V(1)(a-b) of this section: a fine of up to \$1,000 for each offense.
 - (d) For conducting any other regulated activity without the issuance of a permit, where such activity is not described in Article V(1)(a-b) of this section: a fine of up to \$1000 for each offense.
 - (2) Each violation of the Regulations or permit or enforcement order may be a separate and distinct offense, and, in the case of a continuing violation, each day's continuance may be deemed to be a separate and distinct offense.

- (3) For repeated violations on the same property, fines shall be doubled to the extent permissible by law.
- (4) The date of the offense shall be concurrent with the date that the violation was first identified. Any fines associated with the current offense shall be retroactively incurred to the date of identification of the violation.

Article VI - Period for Uncontested Payment of Fines

Those persons or entities cited have a period of thirty days from receipt of the citation to make an uncontested payment of the fine. Such fines shall be made payable to the Collector of Revenue of the Town of Manchester. If such fine is not paid within the thirty-day period, further actions may be taken pursuant to Section 7-152c of the Connecticut General Statutes.

Article VII - Appeals and Hearing Procedures

Any person or entity cited wishing to contest a citation may request a hearing before the Citation Hearing Officer within thirty days of receipt of the citation. Hearing procedures shall be established in accordance with the provisions of Section 7-152c of the Connecticut General Statutes.

Article VIII - Citation Hearing Officers

The Town Manager shall appoint an impartial Citation Hearing Officer to conduct hearings. No person with a personal conflict of interest shall serve as a Citation Hearing Officer. The Inland Wetlands Agent, Zoning Enforcement Officer, or any current member of the Planning and Zoning Commission or Inland Wetlands Agency may not be appointed as a Citation Hearing Officer.

Article IX - Remedies Not Exclusive

The remedies provided by this ordinance are not exclusive and shall be in addition to any other remedies available under state law or other municipal ordinances.

Article X - Severability

If any part of this ordinance is declared invalid by a court, the remainder shall not be affected and shall continue in full force and effect.

Article XI - Effective Date

This ordinance shall take effect upon passage by the Board of Directors.

Adoption

This ordinance is hereby adopted by the Board of Directors of the Town of Manchester, Connecticut, on [Adoption Date], and shall be published as required by law.

DRAFT

TOWN OF MANCHESTER MINUTES OF PUBLIC HEARING HELD BY THE PLANNING AND ZONING COMMISSION/ INLAND WETLANDS AND WATERCOURSES AGENCY MARCH 18, 2024

MEMBERS PRESENT:

In Person: Eric Prause, Chairman

Patrick Kennedy, Vice Chairman

Michael Stebe, Secretary

Teresa Ike

Chris Schoeneberger

Daniela Luna Michael Farina

ALTERNATE MEMBER SITTING FOR APPROVAL OF MINUTES ONLY:

In Person: Maliha Ahsan

ALTERNATES PRESENT

In Person: Bonnie Potocki

ABSENT: Zachary Schurin

ALSO PRESENT:

In Person: Megan Pilla, Principal Development Planner

Gary Anderson, Director of Planning & Economic

Development

Electronically: Nancy Martel, Recording Secretary

The Chairman opened the Public Hearing at 7:00 P.M. The Secretary read the legal notice when the call was made.

TOWN OF MANCHESTER PLANNING & ZONING COMMISSION (continued from March 4, 2024) — Proposed regulation amendment at Art. II, Sec. I (General Requirements for Residential Zones) to allow the conversion of former school buildings to multi-family residential. — Zoning Regulation Amendment (REG-0001-2024)

Ms. Pilla recapped the proposed new section to allow for the conversion of former school buildings to multi-family residential by special exception. It is similar to, though not exactly the same as, special exceptions that allow similar conversions of historic mills and hotels and motels. This would be applicable to all residential zones because that is where nearly all existing school buildings are located and where schools are permitted.

Ms. Pilla responded to questions:

- 1. How was Bennet housing approved? In 1982, housing for the elderly and handicapped was a special exception use in residential zones. It was later removed from the zoning regulations and replaced with the EHD zone.
- 2. Minimum floor area requirements in the draft proposal. That has been removed. In doing research, she sought examples of other municipalities' minimum floor areas of dwelling units, which she could not find. She contacted the Connecticut Planning Listserve as well as the Town Attorney's office and learned that it is not allowed to have minimum dwelling unit floor areas in zoning regulations anymore, which was part of Public Act 21-29 in 2021: Zoning regulations shall not: (7) Establish for any dwelling unit a minimum floor area that is greater than the minimum floor area set forth in the applicable building, housing or other code.
- 3. *Financial Guarantee*. Art. IV, Sec. 22 of Manchester's zoning regulations, added after the mill conversion regulations were created, does outline all financial guarantee requirements in accordance with state law and they are applicable to all projects. She added a brief reference to the proposed section to ensure it is noted.

4. Affordable Housing.

- Option 1 No requirement. Most consistent with the rest of the zoning regulations.
- Option 2 Incentivizes by allowing construction of new buildings or building additions if 15% of units in the development are dedicated affordable units. (Includes height and density criteria for new buildings and additions.)
- Option 3 Same requirement as historic mill conversions, 10% of all must be dedicated as affordable units.

If the Commission moved tonight to approve the draft as written, it would be Option 1 with no affordable housing requirement.

- 5. Consistency with POCD Recommendations.
 - "Educational Facilities" Recommendation #3 Complete the Repurposed Schools project and move forward.
 - "Housing Changing Preferences" Recommendation #1 Strengthen neighborhoods and expand housing choices through an increased mix of uses, diversified housing choices, and the concentration of more housing within mixed-use areas such as Downtown.
 - "Housing Attainability" Recommendation #2 Prioritize policies and programs that encourage higher density pedestrian-oriented neighborhoods with a range of housing choices.

Between Option 2 and Option 3, staff prefers Option 2 because Option 3 with the mill conversion did not achieve the intent they sought in terms of affordable units. Incentivizing, rather than requiring, allows more flexibility and opens the door to more development proposals and a wider range of possibilities, and potentially more interest from developers.

Mr. Farina asked for clarification about the state guidelines for affordable housing in a community and where Manchester stands. He noted that Manchester has done a great job providing affordable housing.

Mr. Anderson reported that there is an Affordable Housing Appeals List. The municipalities in the state are required to have at least 10% of their units dedicated as affordable. Manchester is on the good side of that, in the 14% range. The Planning Department has issues with the way those are measured, but all towns are measured by the same criteria.

Mr. Stebe observed that Manchester had to report its listing and ratings recently, and Mr. Anderson confirmed that it is every year.

Ms. Potocki stated that she reviewed the Transforming Manchester document put together by the consultant on the schools. Page 27, which pertains to Nathan Hale School, reported the desires of the neighborhood: housing, school, incorporating mixed use, and perhaps community space. She suggested that Commission members consider the effort made to have a consultant review the survey. Regarding the historic character of the building, it is a historic façade, but the inside will need substantial rehab.

Mr. Anderson pointed out that this proposal is just the work to change the zoning regulations to allow this type of use.

Mr. Prause thanked the staff for the affordable housing options. Having a requirement may be difficult and developers may shy away. The second option with an incentive would allow expansion of the density or the height and he asked whether staff believe it to be in any way detrimental to have this clause in the regulations.

Mr. Anderson did not see it as a negative. One of the Commission's priorities over the next year or two will be redoing the zoning regulations. In his opinion, that is something to be looked at holistically instead of adding it to a rehab use within the regulations. While he did not see the harm in adding it, perhaps there are other places to add it and think more about incentivizing affordable housing throughout town.

Mr. Prause added that the two incentives it looks at are: increasing the building height to three floors, and potentially adding more buildings to increase density on the site. Looking at all the potential schools, there are not any that are already three stories high, and he is unsure how feasible it would be to add a third story. However, a developer could add more structures that are three story.

Ms. Pilla agreed, clarifying that it does not have to be a third story; it could be an addition of any kind. This is a special exception regulation, and each proposal would be reviewed and approved on a case-by-case basis.

Mr. Prause speculated whether there would be enough area to have the correct amount of open space and parking for there to be another building, or if it could never be invoked based on the three potential buildings.

Ms. Pilla stated that it could potentially be feasible at the sites based on the size, setbacks and other dimensional standards that would be required.

Mr. Schoeneberger, referring to Option 2, stated that is illustrative and there could be other types of incentives.

Ms. Pilla reported that, for the Option 2 wording, any building addition or any new building could trigger that requirement for affordable housing. She acknowledged that it could be worded however the Commission wanted it to be.

Mr. Stebe recognized that there is already a plan for a more holistic review of the zoning regulations, and adding an affordable housing clause would be pushing this out for another meeting. In his opinion, going with what was written without an affordable housing section is the appropriate step, with the notion that the overhaul of the regulations adds a section on affordable housing.

Ms. Potocki referred to Sec. 12, Recreational Areas, noting that minimum floor areas are not allowed. She asked whether that would be in conflict. She additionally asked about Public Act 21-29.

Ms. Pilla stated that has nothing to do with minimum floor areas of the dwelling units; that references the gross floor area of the entire building. Public Act 21-29 refers to minimum floor area of dwelling units.

Ms. Pilla reported the response to the referral to CRCOG. They found no conflict with the original proposal and regional plans and applauded the effort to increase diversified housing options by allowing conversions.

There were no members of the public to speak on the application.

MOTION: Mr. Kennedy moved to close the public hearing. Ms. Ike seconded the motion and all members voted in favor.

The public hearing was closed at 7:30 P.M.

I certify these minutes were adopted on the following date:

D	Pate	Eric Prause, Chairman
NOTICE:	A DIGITAL RECORDING IN THE PLANNING DEPA	OF THIS PUBLIC HEARING CAN BE HEARD

DRAFT

TOWN OF MANCHESTER MINUTES OF BUSINESS MEETING HELD BY THE PLANNING AND ZONING COMMISSION/ INLAND WETLANDS AND WATERCOURSES AGENCY MARCH 18, 2024

MEMBERS PRESENT:

In Person: Eric Prause, Chairman

Patrick Kennedy, Vice Chairman

Michael Stebe, Secretary

Teresa Ike

Chris Schoeneberger

Daniela Luna Michael Farina

ALTERNATE MEMBER SITTING FOR APPROVAL OF MINUTES ONLY:

In Person: Maliha Ahsan

ALTERNATES PRESENT

In Person: Bonnie Potocki

ABSENT: Zachary Schurin

ALSO PRESENT:

In Person: Megan Pilla, Principal Development Planner

Gary Anderson, Director of Planning & Economic

Development

Electronically: Nancy Martel, Recording Secretary

The Chairman opened the Business Meeting at 7:30 P.M.

TOWN OF MANCHESTER PLANNING & ZONING COMMISSION – Proposed regulation amendment at Art. II, Sec. I (General Requirements for Residential Zones) to allow the conversion of former school buildings to multi-family residential. – Zoning Regulation Amendment (REG-0001-2024)

Zoning Regulation Amendment (REG-0001-2024)

MOTION: Mr. Kennedy moved to approve the zoning regulation amendment to add Art. II,

Sec. 1.00.03 to allow the conversion of former school buildings to multi-family housing by special exception in residential zones. Ms. Ike seconded the motion

and all members voted in favor.

The reason for the approval is that the proposed amendment is consistent with the following recommendations of the Plan of Conservation and Development:

- "Educational Facilities" recommendation #3: Complete the Repurposed Schools project and move forward.
- "Housing Changing Preferences" recommendation #1: Strengthen neighborhoods and expand housing choices through an increased mix of uses, diversified housing choices, and the concentration of more housing within mixed-use areas such as Downtown.
- "Housing Attainability" recommendation #2: Prioritize policies and programs that encourage higher density pedestrian-oriented neighborhoods with a range of housing choices.

The zoning regulation amendment will be effective on April 8, 2024.

Mr. Stebe commended Town staff for their diligence in revising the proposal. He felt this is a major step to bringing life and vitality back into the Nathan Hale building and neighborhood.

Mr. Prause commented that this is very much in compliance with the recent Plan of Conservation and Development (POCD), in that it referenced the Repurposed Schools project. He reported that he is in support of Option 2, which would provide incentives when affordable housing is included.

APPROVAL OF MINUTES

March 4, 2024 – Public Hearing/Business Meeting

MOTION:

Mr. Kennedy moved to approve the minutes as written. Mr. Schoeneberger seconded the motion. Mr. Prause, Mr. Kennedy, Mr. Stebe, Ms. Ike, Mr. Schoeneberger, Mr. Farina, and Ms. Ahsan voted in favor of the motion. Ms. Luna abstained.

ADMINISTRATIVE REPORTS

- Lot Line Revision administratively approved for 38 and 46 Markwood Lane.
- Upcoming Training Opportunities
- Notice of Intent received to file a petition for a declaratory ruling to the Connecticut Siting Council for a 1.66 megawatt solar facility at 186 Foster Street in South Windsor.
- Update on 250 Carter Street At a hearing last week, the Siting Council did grant the request that they hold a public hearing. The date has not yet been set.
- Comprehensive Zoning Update Interviews of potential consultants are scheduled for the first week of April with the Steering Committee.

Mr. Stebe interjected that CRCOG will hold a series of items that will precede their quarterlies.

Ms. Potocki requested an update on a matter before Superior Court regarding Wyneding Hill Road.

Ms. Pilla responded that there is no update at this time. It was an appeal brought by a resident on the decision.

RECEIPT OF NEW APPLICATIONS

There were no new applications.

MOTION:	Mr. Kennedy moved to close and all members voted in favor	the Business Meeting. Ms. Ike seconded the motion or.
The Business	Meeting was closed at 7:50 P.	М.
I certify these	minutes were adopted on the f	Collowing date:
	Date	Eric Prause, Chairman

NOTICE: A DIGITAL RECORDING OF THIS BUSINESS MEETING CAN BE HEARD IN THE PLANNING DEPARTMENT.